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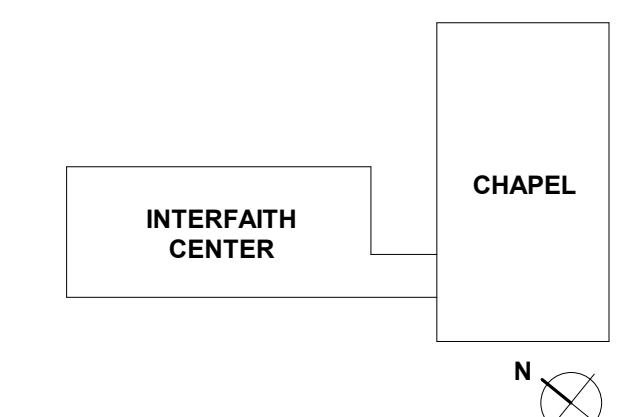
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REVISIONS

REV. #	DESCRIPTION	DATE

KEY PLAN



ARCHITECTS + PLANNERS

NOT FOR CONSTRUCTION

DRAWING INFORMATION

ISSUE DATE:	04/28/17
SCALE:	As indicated
JOB NO.:	16072
DRAWN BY:	CRS

PROJECT DESIGN PHASE


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DRAWING NAME

FOUNDATION AND LOWER LEVEL PLAN

DRAWING NUMBER

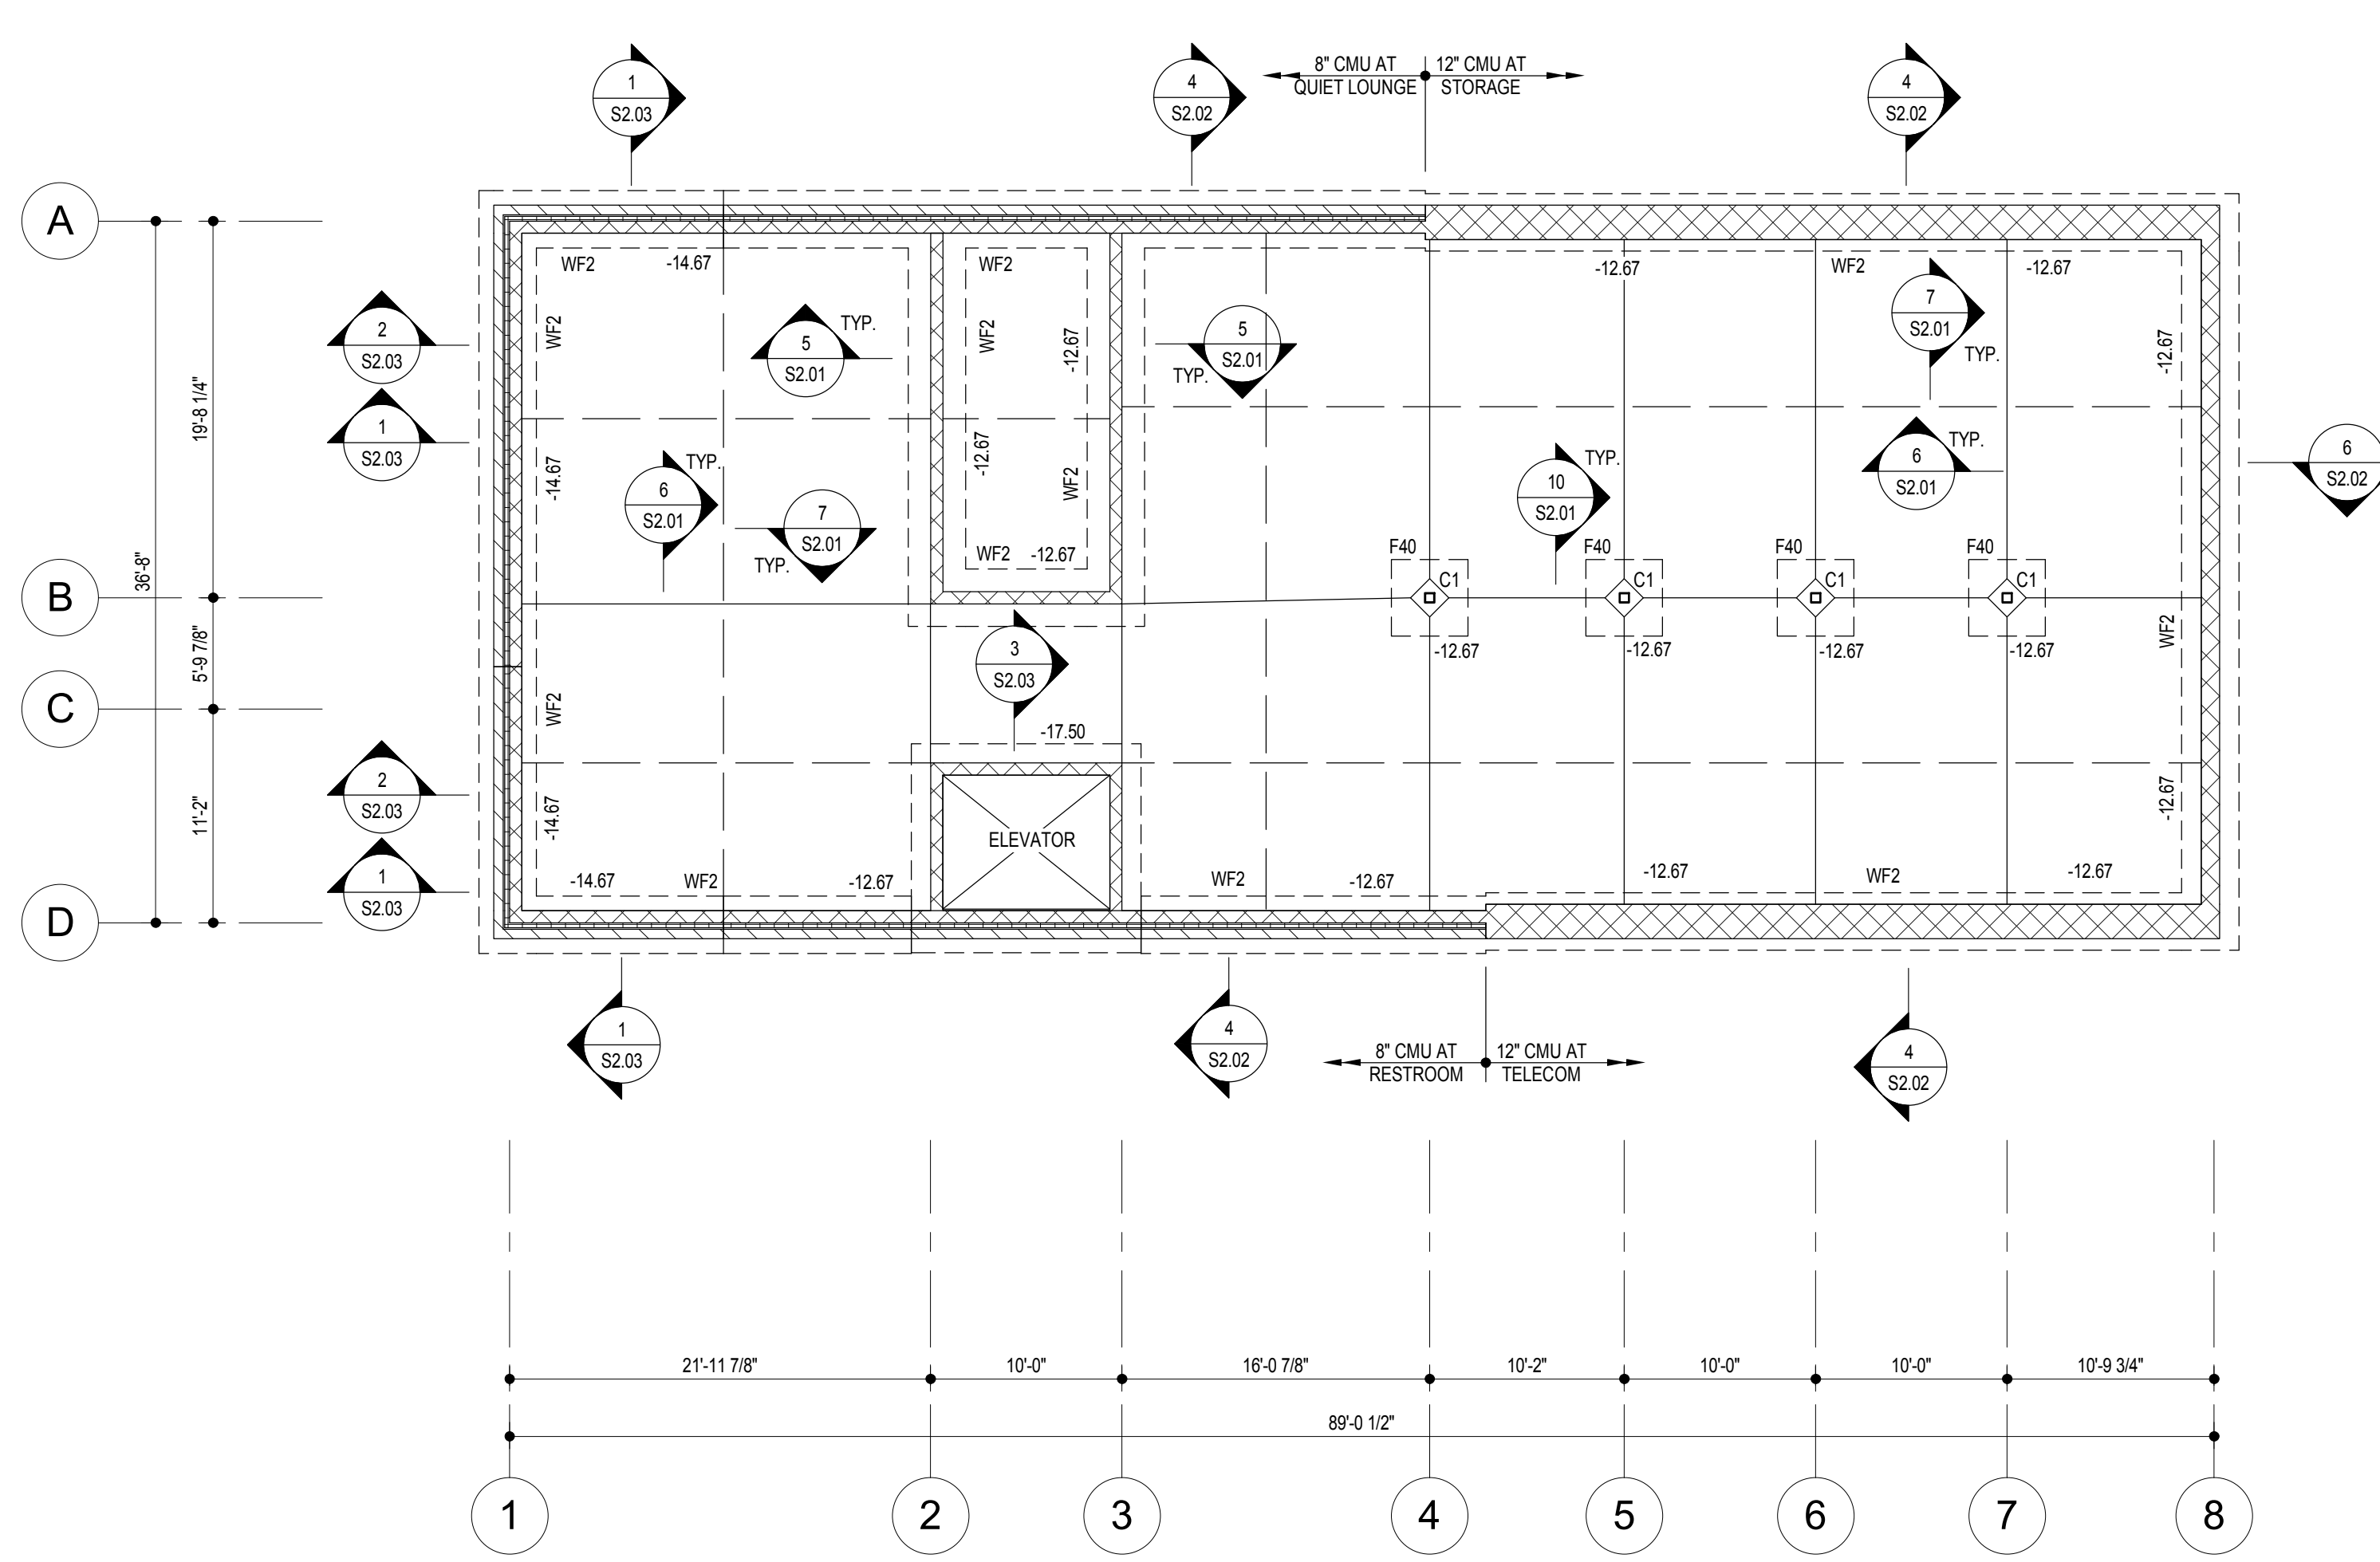S1.00



- FOUNDATION AND LOWER LEVEL PLAN** SCALE: 1/8" = 1'-0"
- ELEVATION TOP OF STRUCTURAL SLAB ON GRADE = EL. -11.00 (U.N.O.)
 - STRUCTURAL SLAB SHALL BE 6" CONCRETE SLAB ON GRADE (f_c = 3000 PSI) REINFORCED WITH 6" x 6" W2.9 / W2.9 WELDED WIRE FABRIC POURED OVER VAPOR BARRIER OVER 4" POROUS FILL (U.N.O.)
 - EXTERIOR SLAB ON GRADE BY LANDSCAPE ARCHITECT. FOR ADDITIONAL INFORMATION SEE LANDSCAPE ARCHITECTURAL DRAWINGS.
 - ALL WALL FOOTINGS NOT SPECIFICALLY SHOWN ON PLAN SHALL BE 12" DEEP BY WALL WIDTH WITH 6" PROJECTION ON EACH SIDE OF WALL WITH 2#5 CONT. BARS AND #5 BARS AT 24"o/c.
 - ELEVATION BOTTOM OF FOOTING IS SHOWN ON PLAN.
 - ASSUMED SOIL BEARING VALUE = 3000 PSF WAS USED IN DESIGN OF THE STRUCTURE. THIS VALUE SHALL BE FIELD VERIFIED BY A REGISTERED GEOTECHNICAL ENGINEER. SEE GEOTECHNICAL ENGINEERING REPORT PREPARED BY HERBST/BENSON & ASSOCIATES DATED JANUARY 6, 2017 FOR ADDITIONAL INFORMATION AND REQUIREMENTS.
 - WALL TYPES INDICATED ON PLAN THUS:
 [Symbol] REINFORCED MASONRY BLOCK WALLS (ASTM C-90)
 - STAIRS SHALL BE DESIGNED FOR 100 POUNDS PER SQUARE FOOT LIVE LOAD. SUBMIT SIGNED AND SEALED SHOP DRAWINGS TO ENGINEER FOR REVIEW. SEE ARCHITECTURAL DRAWINGS FOR RISER AND TREAD DIMENSIONS.
 - CONTRACTOR SHALL COORDINATE ALL DIMENSIONS AND ELEVATIONS WITH ARCHITECTURAL AND SITE DRAWINGS PRIOR TO CONSTRUCTION.
 - PROVIDE FOOTING IN SLAB ON GRADE AT ALL NON-LOAD BEARING BLOCK PARTITIONS PER DETAIL 9 ON S2.01. SEE ARCHITECTURAL DRAWINGS FOR LOCATION OF ALL BLOCK PARTITIONS NOT SHOWN ON STRUCTURAL DRAWINGS.
 - SEE MECHANICAL DRAWINGS FOR EXACT SIZE AND LOCATION OF REQUIRED EQUIPMENT PADS. SEE DETAIL 3 ON S2.02 FOR ADDITIONAL INFORMATION.
 - MASONRY WALLS SHALL BE 8" MASONRY (f_m = 2500 PSI) REINFORCED PER MASONRY WALL SCHEDULE ON S1.00.12. MASONRY WALLS SHALL BE 8" MASONRY (f_m = 1500 PSI) REINFORCED PER MASONRY WALL SCHEDULE ON S1.00.

MARK	COLUMN SIZE	BASE PLATE SIZE	ANCHOR BOLTS	PEDESTAL SIZE AND REINFORCING	NOTES
C1	HSS6x6x1/4	12" x 12" x 1'-0"	(4) 3/4" x 8" LONG	16" x 16" PEDESTAL WITH (4) #7 VERTICAL	PROVIDE PEDESTAL WHERE SHOWN ON PLAN

- COLUMN SCHEDULE NOTES:**
- FOR ORIENTATION OF COLUMNS, BASE PLATES, LEVEL PLATES, PEDESTALS, AND FOOTINGS - SEE PLAN
 - STRUCTURAL STEEL HSS SHAPES SHALL CONFORM TO ASTM A-600 GRADE B. STRUCTURAL STEEL PLATES SHALL CONFORM TO ASTM A-36 UNLESS NOTED OTHERWISE.
 - ALL ANCHOR BOLTS SHALL CONFORM TO ASTM F-1554, GRADE 55.
 - IN ADDITION TO DETAILED OUTER PEDESTAL TIES, PROVIDE ALL INTERIOR AND CROSS TIES AS REQUIRED BY ACI-318 LATEST EDITION.

MARK	FOOTING SIZE	REINFORCING	NOTES
F30	3'-0" x 3'-0" x 12"	4#5 E.W. BOTTOM	PROVIDE PEDESTAL WHERE SHOWN ON PLAN
F40	4'-0" x 4'-0" x 12"	5#5 E.W. BOTTOM	PROVIDE PEDESTAL WHERE SHOWN ON PLAN
WF1	12" DEEP x 2'-0" CONTINUOUS	3#5 CONT. WITH #4 TIE BARS AT 24"o/c	
WF2	12" DEEP x 3'-0" CONTINUOUS	4#5 CONT. WITH #4 TIE BARS AT 24"o/c	

FLOOR	BLOCK STRENGTH	VERTICAL REINFORCING	TENSION LAP SPLICE
LL TO GROUND	HIGH STRENGTH	#7 AT 8"	5'-3"
GROUND TO LEVEL 2	HIGH STRENGTH	#7 AT 16"	5'-3"
LEVEL 2 TO TRUSS BRG.	HIGH STRENGTH	#7 AT 24"	5'-3"

- MASONRY WALL NOTES**
- FILL ALL REINFORCED MASONRY CELLS 100% SOLID WITH 3000 PSI GROUT.
 - LAP ALL #5 VERTICAL REINFORCING 2'-0" MINIMUM. #5 VERTICAL REINFORCING 3'-0" MINIMUM, AND #7 VERTICAL REINFORCING 3'-6" MINIMUM.
 - PROVIDE TENSION LAP SPLICE WHERE REQUIRED ON PLAN AND IN TYPICAL DETAILS.
 - PROVIDE FOOTING DOWELS AT WALL FOUNDATIONS SAME SIZE AND SPACING AS WALL VERTICAL REINFORCING. PROVIDE LAP SPLICE IN ACCORDANCE WITH NOTES 3 AND 4.
 - REINFORCING SHOWN ON MASONRY RETAINING WALL DETAILS ON S2.02 SHALL SUPERSEDE AND REPLACE REINFORCING SHOWN IN SCHEDULE ABOVE.

STAPLE EDGE

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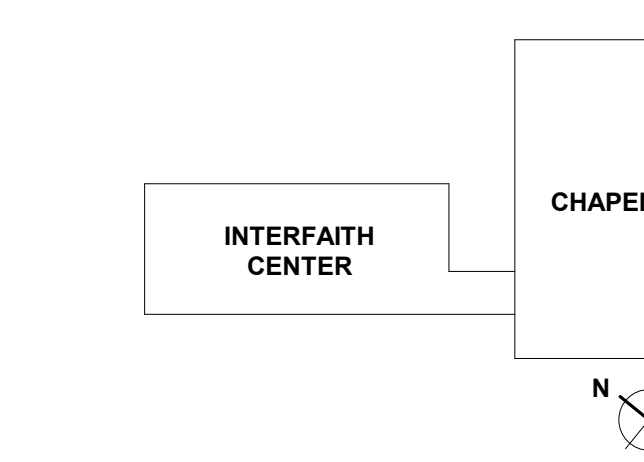
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PROJECT DESIGN PHASE

50% CD SET

DRAWING NAME

GROUND LEVEL FRAMING PLAN

DRAWING NUMBER

S1.01




GROUND LEVEL PLAN

SCALE: 1/8" = 1'-0"

- ELEVATION TOP OF STRUCTURAL WOOD FRAMED FLOOR SHALL BE 0.00.
- STRUCTURAL FLOOR SHALL BE 3/4" GYPSUM TOPPING (TYPICAL, REFER TO ARCHITECTURAL DRAWINGS FOR OTHER THICKNESSES) OVER 1/4" ACUSTIMA OVER 23/32" TONGUE AND GROOVE EXPOSURE 1 APA GROUP 1 RATED STURD-FLOOR NAILED WITH 8d COMMON NAILS AT 6"OC ALONG PANEL EDGES AND 12"OC ALONG INTERMEDIATE SUPPORTS. AS AN ALTERNATE, CONTRACTOR MAY GLUE AND NAIL FLOOR SHEATHING TO FLOOR TRUSSES WITH 6d RING OR SCREW SHANK NAILS AT 6"OC ALONG PANEL EDGES AND 12"OC ALONG INTERMEDIATE SUPPORTS.
- ELEVATION TOP OF STEEL BEAMS SHOWN ON PLAN = -0.14.
- WALL TYPES ARE SHOWN ON PLAN, THUS:
 □ WOOD STUD WALLS
 □ REINFORCED MASONRY BLOCK WALLS (ASTM C-90)
- CONTRACTOR SHALL COORDINATE ALL DIMENSIONS AND ELEVATIONS WITH ARCHITECT PRIOR TO CONSTRUCTION.
- ALL WOOD STUDS SHALL BE NO. 1/NO. 2 SPRUCE PINE FIR (UNO). APARTMENT WOOD STUD BEARING / SHEAR WALLS BELOW THIRD FLOOR SHALL BE COMPRISED OF THE FOLLOWING, UNLESS NOTED OTHERWISE:
 LOCATION STUD SIZE / SPACING
 EXTERIOR 2x6 AT 16"OC
 STAIR SHAFT 2x6 AT 16"OC
 ELEVATOR SHAFT 2x6 AT 16"OC
 NON-BEARING 2x4 AT 24"OC (UNO)
- WOOD STUD BEARING WALLS SHOWN ON PLAN SHALL BE BLOCKED AT 4'-0"OC
- WOOD TRUSS LAYOUT AS SHOWN ON PLAN IS DGNRAMATIC. ALIGN TRUSSES WITH STUDS BELOW WHERE POSSIBLE. COORDINATE ALL TRUSS LOCATIONS WITH MECHANICAL FLOOR PARAMETERS. PROVIDE DOUBLE JOISTS AND HEADERS AT ALL OPENINGS WIDER THAN TRUSS SPACING. CONNECT HEADER TO DOUBLE TRUSS WITH JOIST HANGERS.
- PRE-ENGINEERED WOOD FLOOR TRUSSES NOTED, THUS:
 PWT WOOD TRUSSES AT DEPTH AND SPACING NOTED ON PLAN
- PRE-ENGINEERED TRUSSES SHALL BE DESIGNED FOR THE FOLLOWING MINIMUM SUPERIMPOSED LIVE AND DEAD LOADS BEYOND THE SELF WEIGHT OF TRUSSES:

FLOOR TYPE	TOP CHORD		BOTTOM CHORD	
	DEAD	LIVE	DEAD	LIVE
COMMON AREAS	15 PSF	100 PSF	5 PSF	0 PSF

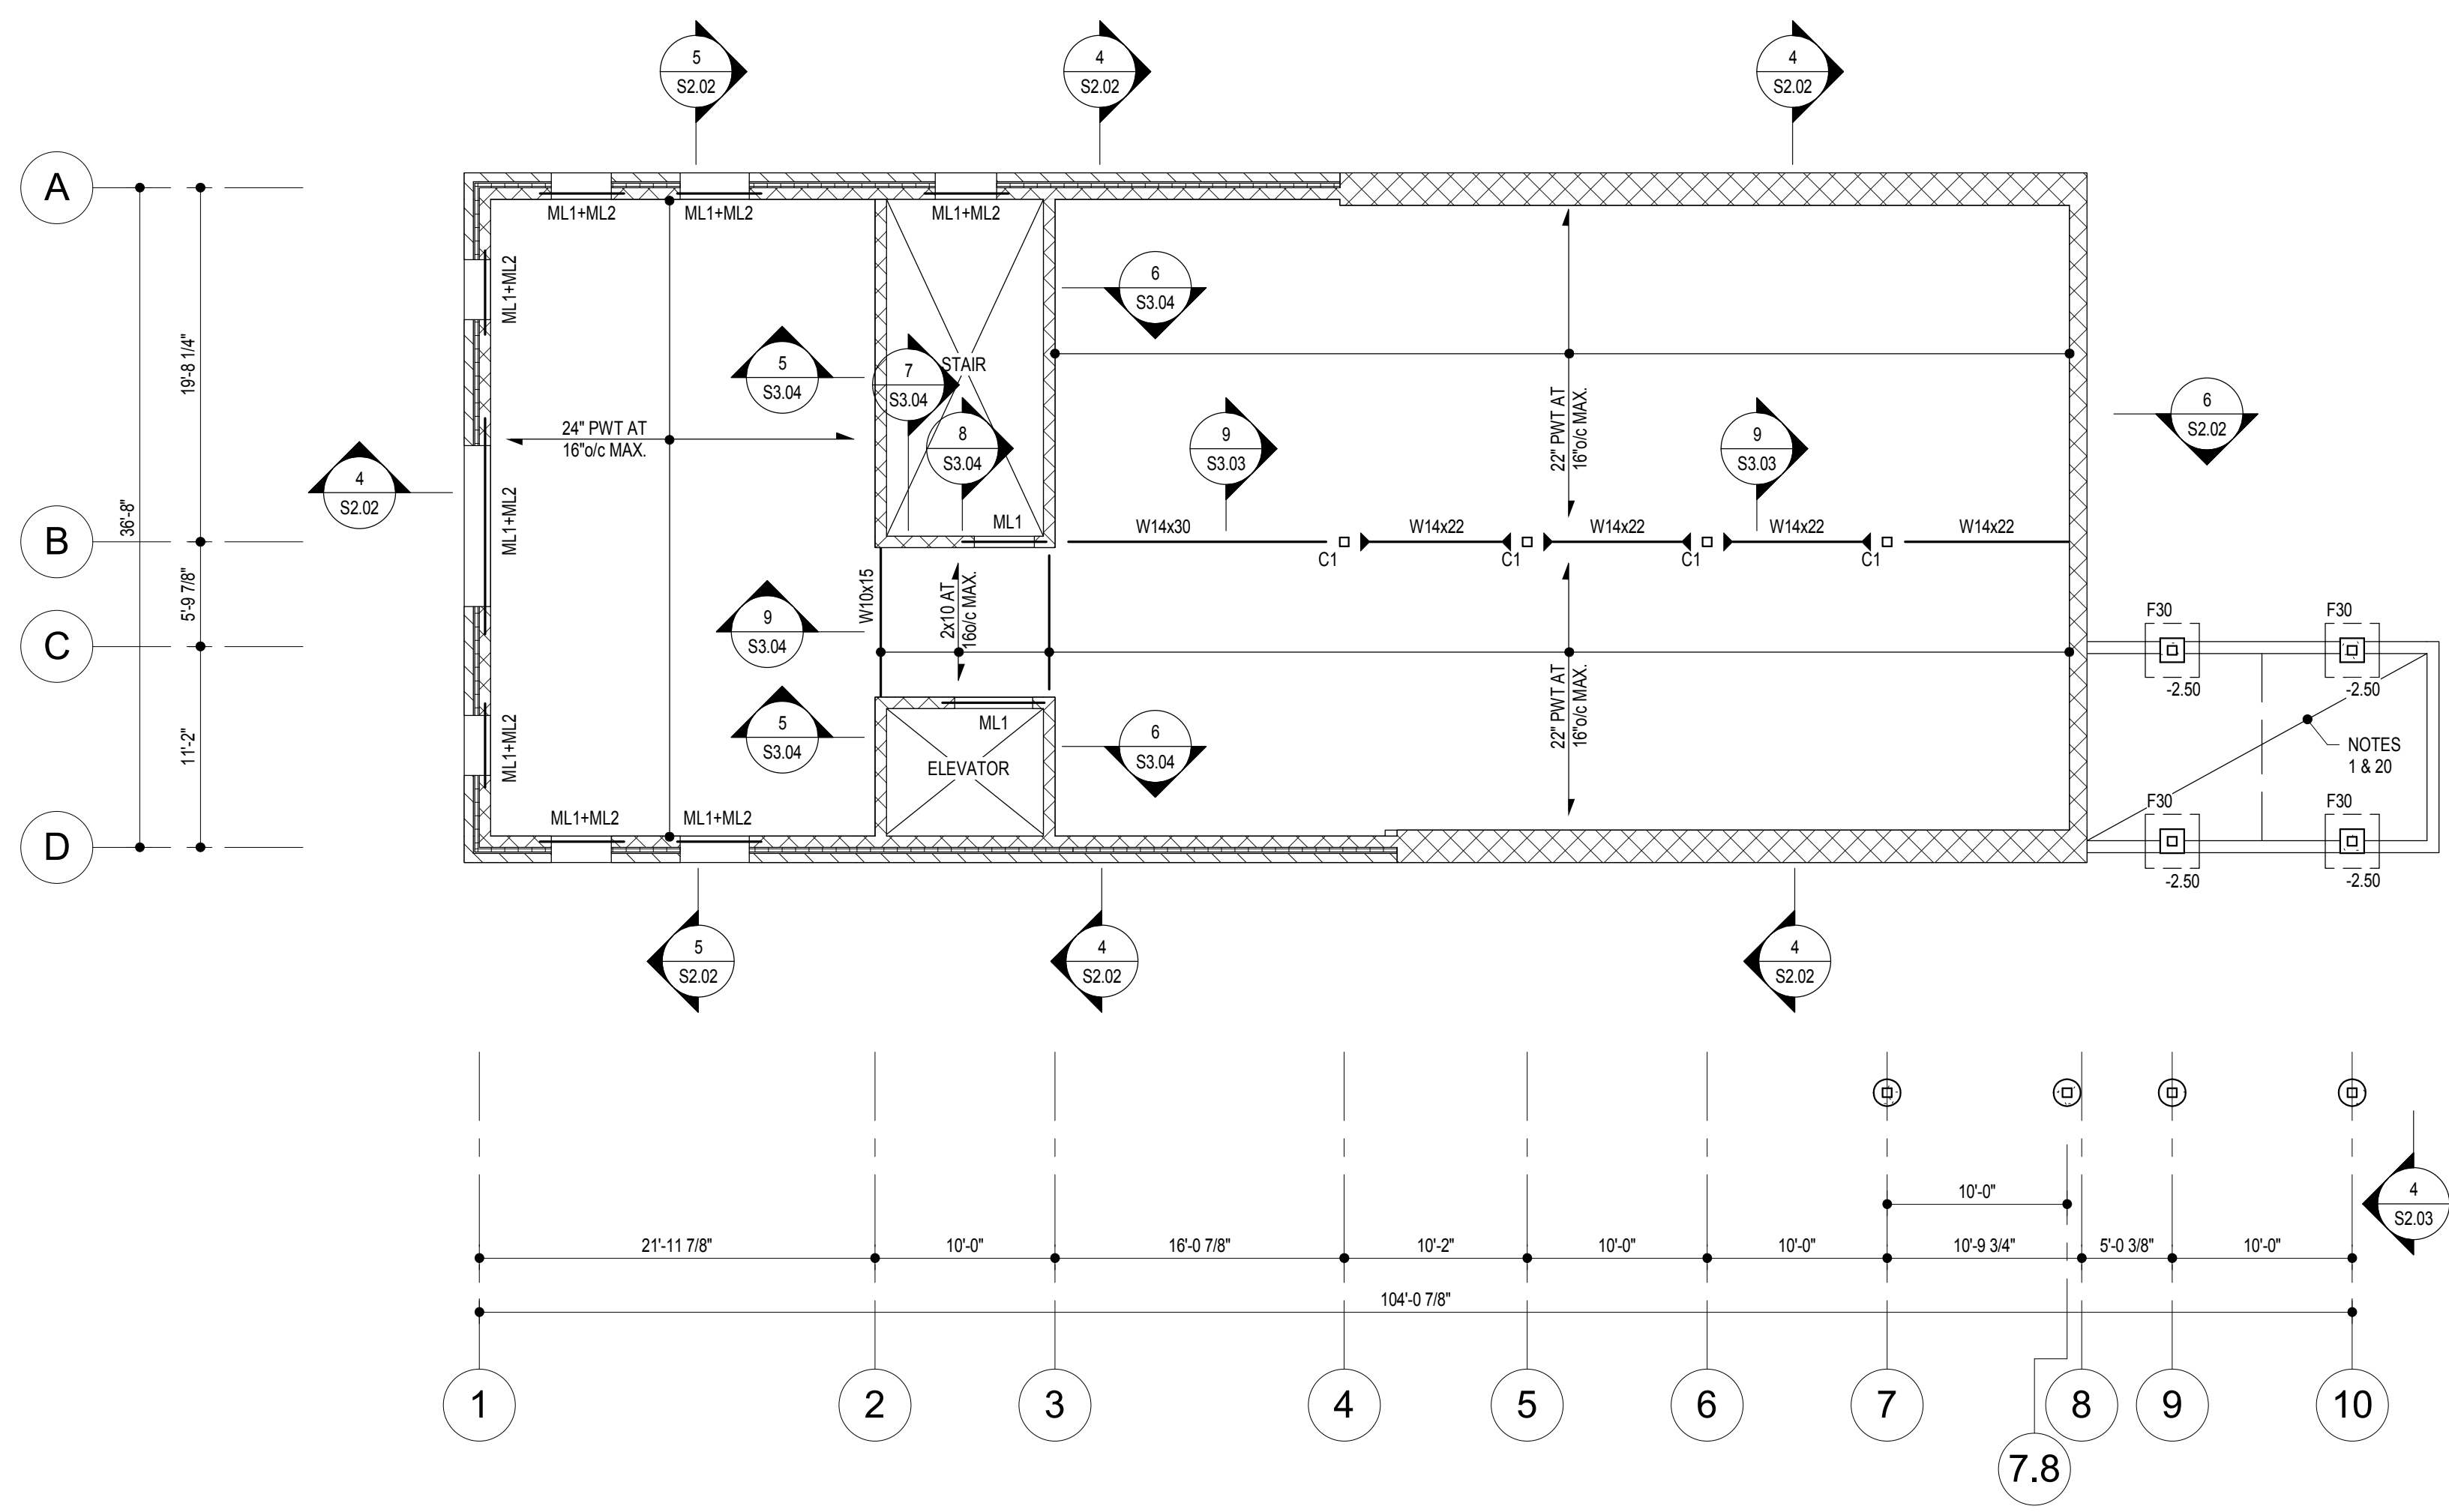 WOOD FLOOR TRUSS DEFLECTION SHALL NOT EXCEED L/480 FOR LIVE LOAD AND L/360 FOR TOTAL LOAD.
- FOR WOOD BEAM AND LINTEL SCHEDULES, REFER TO SHEET S1.01. ALL WOOD BEAMS NOTED, THUS: 'BY' ARE TO BE FLUSH FRAMED WITH FLOOR. ALL WOOD LINTELS NOTED, THUS: 'L' ARE TO BE ELEVATED AT HEAD OF OPENING.
- STAIRS SHALL BE DESIGNED FOR 100 POUNDS PER SQUARE FOOT LIVE LOAD. SUBMIT SIGNED AND SEALED SHOP DRAWINGS OF STAIR FRAMING AND HANDRAILS PREPARED BY A REGISTERED PROFESSIONAL ENGINEER FROM THE STATE OF MARYLAND FOR REVIEW.
- MASONRY WALLS SHALL BE 8" MASONRY (fm = 2500 PSI) REINFORCED PER MASONRY WALL SCHEDULE ON S1.00.
- REFER TO ARCHITECTURAL AND MECHANICAL DRAWINGS FOR LOCATIONS AND REQUIREMENTS AT LOUVERED OPENINGS BELOW EXTERIOR WINDOWS. FOR FRAMING MODIFICATIONS AT LOUVERED OPENINGS, SEE DETAIL.
- STRUCTURAL STEEL WIDE FLANGE BEAMS SHALL CONFORM TO ASTM A-992, GRADE 50. HOLLOW STRUCTURAL STEEL TUBE SHALL CONFORM TO ASTM A500, GRADE B (fy=46 KSI). STRUCTURAL STEEL PLATES, ANGLES AND CHANNELS SHALL CONFORM TO ASTM A36.
- ALL EXPOSED STRUCTURAL STEEL SHALL BE HOT-DIPPED GALVANIZED.
- STAIRS SHALL BE DESIGNED FOR 100 POUNDS PER SQUARE FOOT LIVE LOAD. SUBMIT SIGNED AND SEALED SHOP DRAWINGS TO ENGINEER FOR REVIEW. STAIRS TO BE METAL PAN. SEE ARCHITECTURAL DRAWINGS FOR RISERS AND TREAD DIMENSIONS. ALL STAIR CHANNELS BEARING ON MASONRY WALLS SHALL REQUIRE 6"x 6"x 1/4" BEARING PLATES AND 1/2"x 8" LONG ANCHOR BOLT WITH 2" HOOK.
- PROVIDE DOUBLE 8" WIDE x 8" DEEP CONT. BOND BEAM AROUND PERIMETER OF ELEVATOR AND STAIR WITH 2#5 CONT. BOTTOM REINFORCING EACH COURSE AND FILLED SOLID WITH 3000 PSI GROUT AT EACH FLOOR AND ROOF ELEVATION. PROVIDE 90 DEGREE HOOK BARS AT CORNERS.
- EXTERIOR SLAB ON GRADE BY LANDSCAPE ARCHITECT. FOR ADDITIONAL INFORMATION SEE LANDSCAPE ARCHITECTURAL DRAWINGS.
- FULL CONTINUITY MOMENT CONNECTIONS ARE INDICATED ON PLAN THUS: ◀▶ SHALL HAVE FULL PENETRATION WELDS AT BEAM TO COLUMN TO DEVELOP FULL CAPACITY OF SECTION. SEE DETAIL 6 ON S3.01 FOR ADDITIONAL INFORMATION.
- STRUCTURAL SLAB SHALL BE 5" CONCRETE SLAB ON GRADE (fc = 3000 PSI) REINFORCED WITH 6" x 6" - W2.9 / W2.9 WELDED WIRE FABRIC POURED OVER VAPOR BARRIER OVER 4" POROUS FILL. (U.N.O.)



LINTEL SCHEDULE			
MARK	MEMBER	TYPE	REMARKS
ML1	(2)-6"x 3 1/2"x 3/8" ANGLE (LLV)		8" MIN. BEARING AT EACH END
ML2	5"x 5"x 3/4" ANGLE		8" MIN. BEARING AT EACH END
ML3	W8x28 WITH 16" WIDE x 3/4" THICK CONT. PLATE		16" MIN. BEARING AT EACH END
L1	(2)-2x6 + FULL-DEPTH BLOCKING AT MIDPOINT		PROVIDE (2)-2x6 JACK STUDS EACH END
L2	(2)-2x6 + FULL-DEPTH BLOCKING AT MIDPOINT		PROVIDE (2)-2x6 JACK STUDS EACH END
L3	(4)-2x10 + 1/2" PLYWOOD PLATE + 3/4" PLYWOOD PLATE		PROVIDE (2)-2x6 JACK STUDS EACH END
L4	(4)-2x12 + 1/2" PLYWOOD PLATE + 3/4" PLYWOOD PLATE		PROVIDE (2)-2x6 JACK STUDS EACH END

LINTEL NOTES

- REFER TO ARCHITECTURAL DRAWINGS FOR EXACT SIZE AND LOCATION OF WALL OPENINGS.
- SECURE MULTIPLE SAWN MEMBERS TOGETHER WITH (2) ROWS OF 16d NAILS AT 12"OC FOR MEMBERS UP TO 12" DEEP AND (3) ROWS OF 16d NAILS FOR MEMBERS GREATER THAN 12" DEEP (UNLESS NOTED OTHERWISE). USE GALVANIZED NAILS FOR ALL EXTERIOR LINTELS.
- ALL WOOD LINTELS EXPOSED TO THE WEATHER SHALL BE PRESSURE TREATED.
- STRUCTURAL WOOD LINTELS SHALL BE NO.1/NO.2 SPRUCE PINE FIR WITH THE FOLLOWING MINIMUM PROPERTIES:
 Fb = 875 PSI Fc = 425 PSI Fv = 135 PSI
 E = 1,400,000 PSI Fcl = 1,150 PSI E = 1,400,000 PSI
- CONTRACTOR HAS OPTION TO PROVIDE ADDITIONAL WOOD JOISTS AND PLYWOOD PLATES TO WOOD LINTELS AS NOTED TO ACHIEVE DESIRED THICKNESS.
- SEE PLAN FOR END POST OR END JACK STUDS AND PROVIDE (2) FULL HEIGHT KING STUDS EACH END OF LINTEL. SECURE MULTIPLE JAMB STUDS TOGETHER WITH 16d NAILS AT 9"OC STAGGERED, EACH PLY.
- FOR ADDITIONAL INFORMATION AT TYPICAL WOOD LINTEL FRAMING, REFER TO DETAILS 7, 8, 9, 99, 100.
- ALL STRUCTURAL STEEL EXPOSED TO THE WEATHER OR THAT ARE IN CONTACT WITH MASONRY SHALL BE HOT-DIPPED GALVANIZED IN ACCORDANCE WITH SPECIFICATION SECTION 05100.
- PROVIDE 8" MINIMUM BEARING AT EACH END OF ANGLE LINTEL.
- WOOD POST AND BUILT-UP WOOD POST TO BEAM CONNECTIONS: PROVIDE CC COLUMN CAP SERIES SIZED ACCORDING TO BEAM WIDTH AND BEARING CONDITION. PROVIDE 5/8" DIA. BOLTS AND WOOD SHIM PLATES AS REQUIRED, SEE DETAIL 11.

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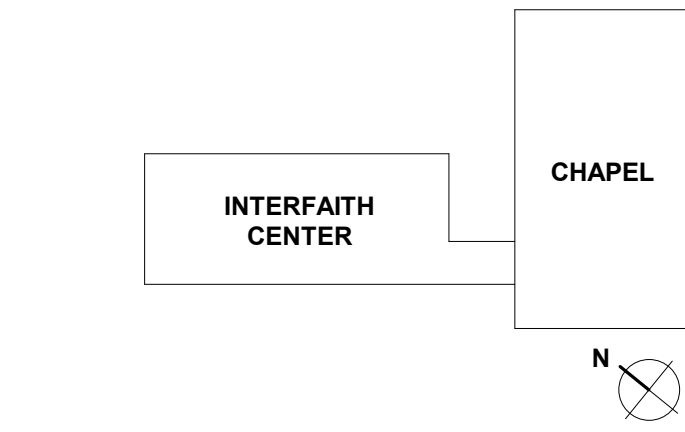
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REVISIONS

Table with 3 columns: REV. #, DESCRIPTION, DATE. Contains multiple empty rows for revisions.

KEY PLAN



ARCHITECTS + PLANNERS

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Drawing information table with fields for ISSUE DATE (04/28/17), SCALE (1/8" = 1'-0"), JOB NO. (16072), and DRAWN BY (CRS).

PROJECT DESIGN PHASE
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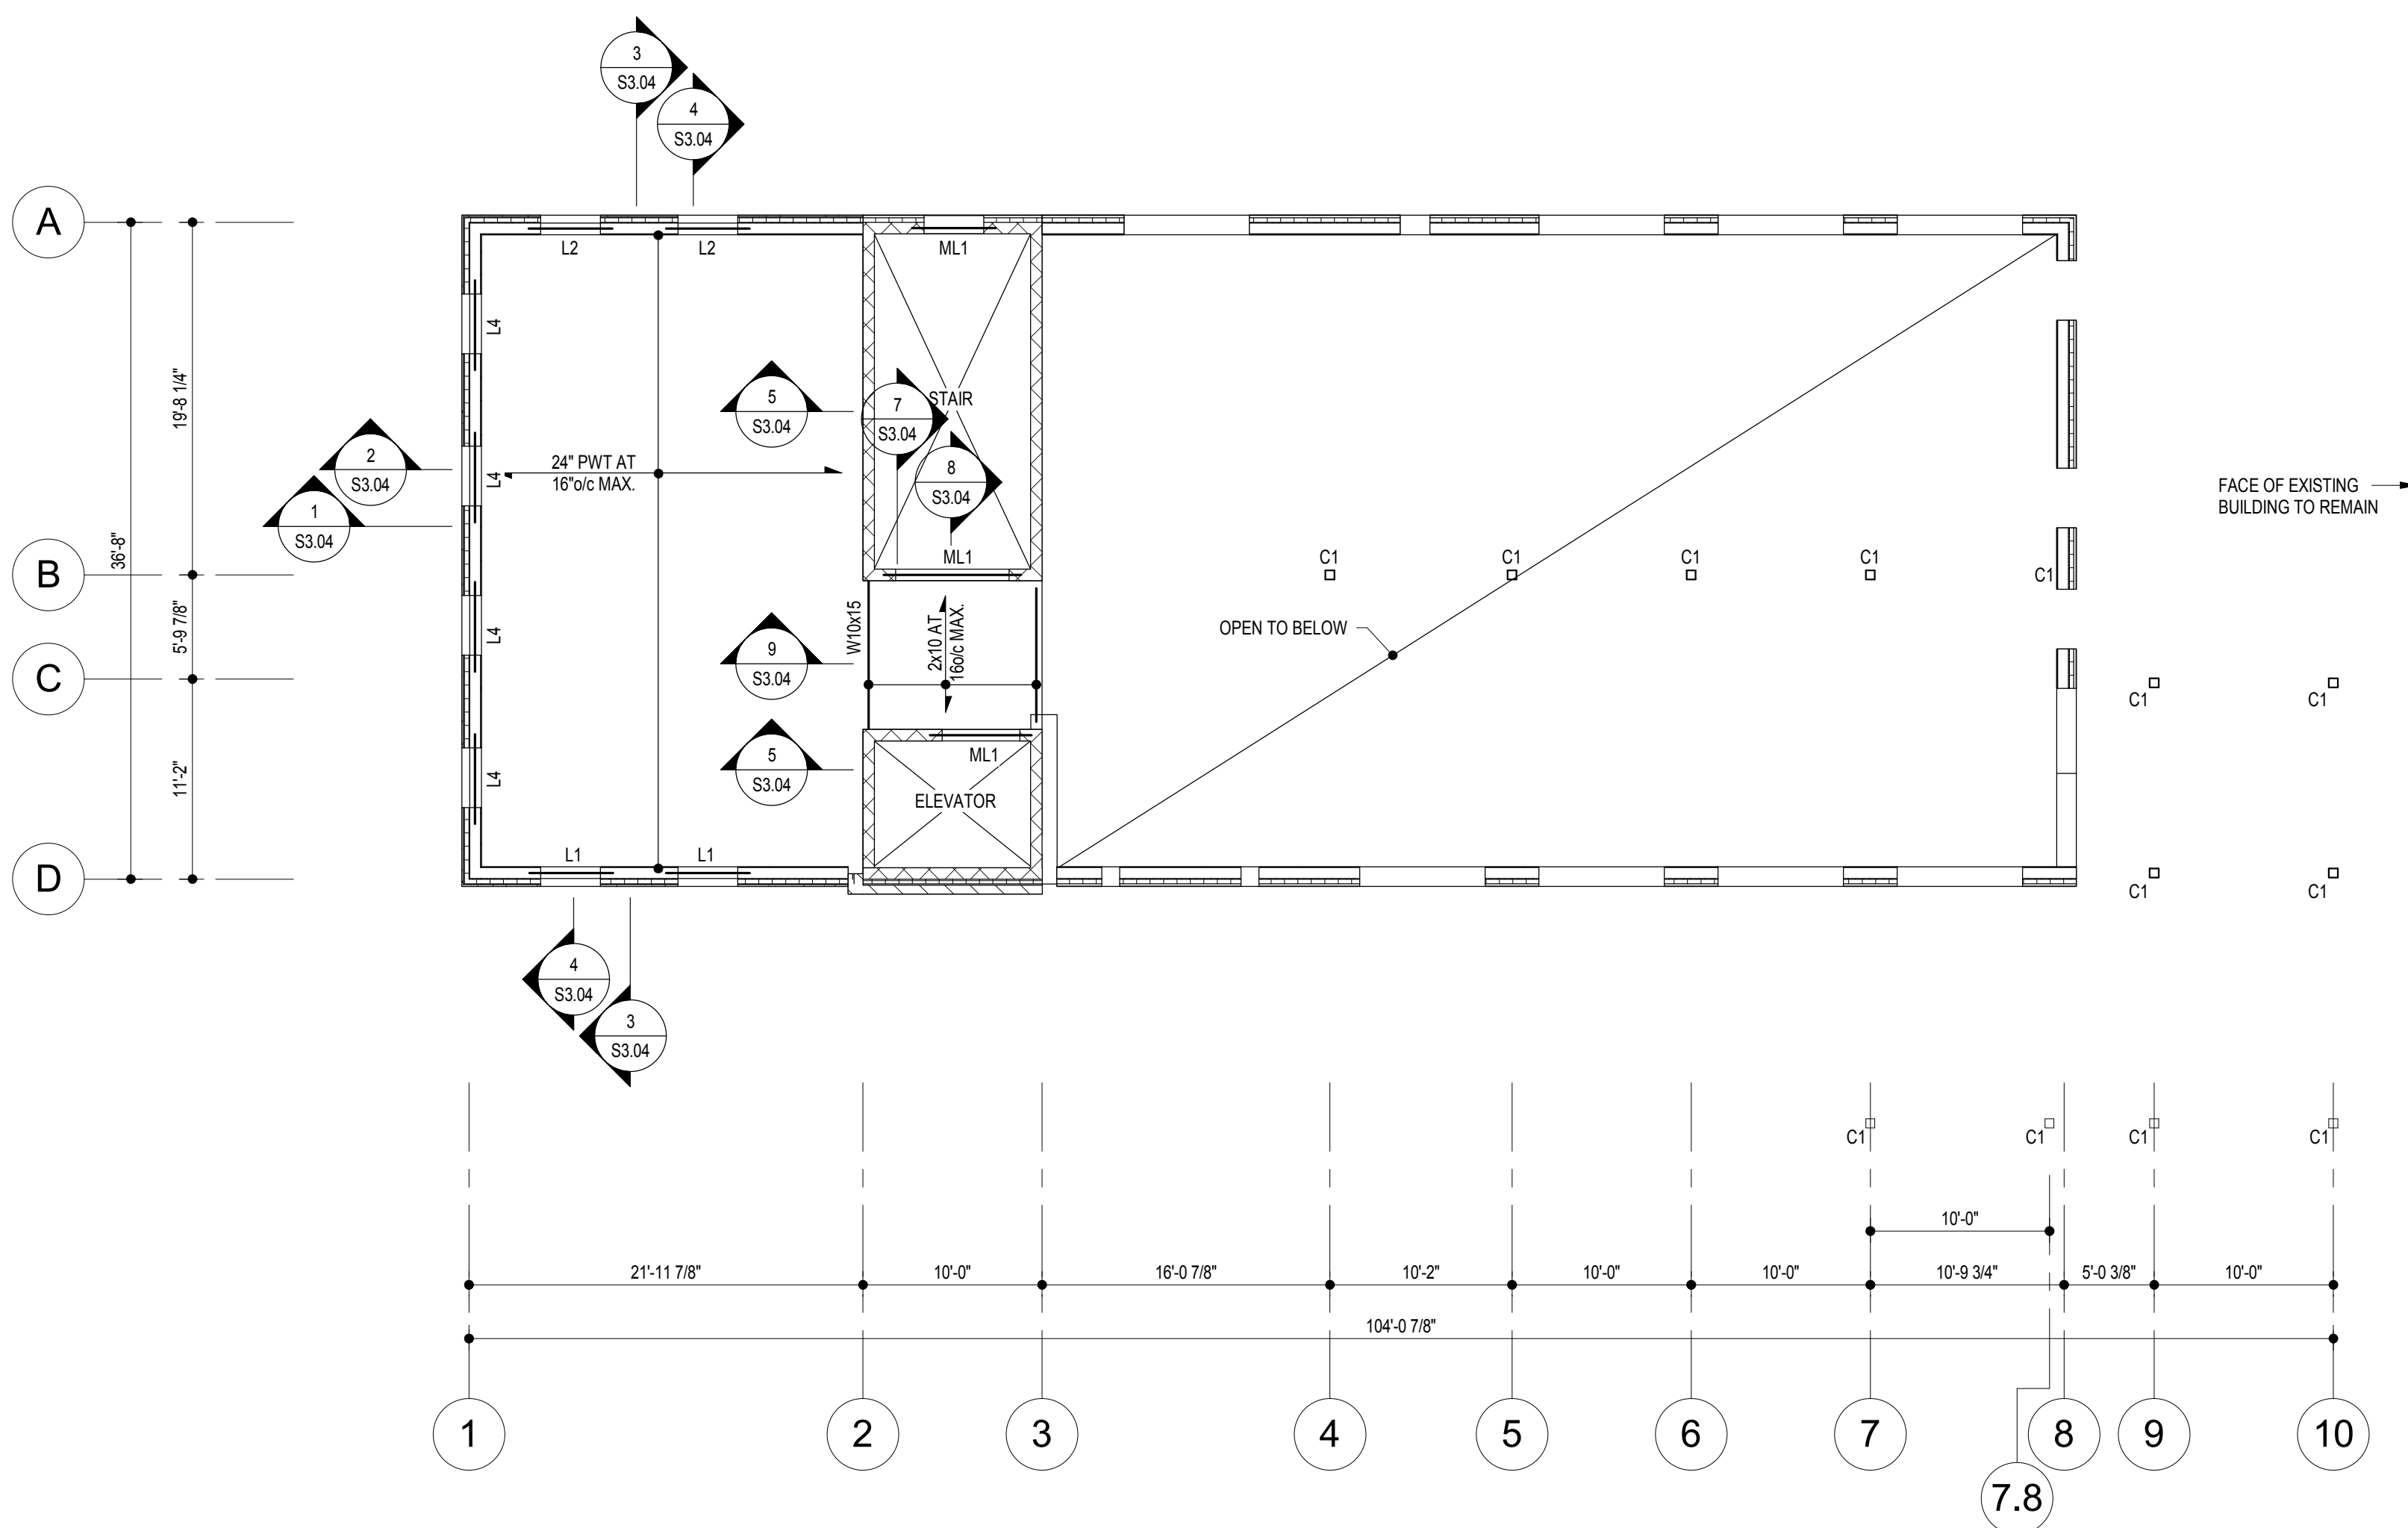
DRAWING NAME
LEVEL 2 FRAMING PLAN

DRAWING NUMBER
S1.02



SECOND FLOOR FRAMING PLAN SCALE: 1/8" = 1'-0"

- 1. ELEVATION TOP OF FRAMED STRUCTURAL SLAB AT HAMBRO FLOOR = EL. 11.33 (U.N.O.)
2. STRUCTURAL FLOOR SHALL BE 3/4" GYPSUM TOPPING (TYPICAL, REFER TO ARCHITECTURAL DRAWINGS FOR OTHER THICKNESSES) OVER 1/4" ACOUSTIMAT OVER 2x2x2 TONGUE AND GROOVE EXPOSURE 1 APA GROUP 1 RATED STURD-FLOOR NAILED WITH 8d COMMON NAILS AT 6" OC ALONG PANEL EDGES AND 12" OC ALONG INTERMEDIATE SUPPORTS. AS AN ALTERNATE, CONTRACTOR MAY GLUE AND NAIL FLOOR SHEATHING TO FLOOR TRUSSES WITH 8d RING OR SCREW SHANK NAILS AT 6" OC ALONG PANEL EDGES AND 12" OC ALONG INTERMEDIATE SUPPORTS.
3. ELEVATION TOP OF STEEL BEAMS SHOWN ON PLAN = 11.19.
4. WALL TYPES ARE SHOWN ON PLAN, THUS:
WOOD STUD WALLS
REINFORCED MASONRY BLOCK WALLS (ASTM C-90)
5. CONTRACTOR SHALL COORDINATE ALL DIMENSIONS AND ELEVATIONS WITH ARCHITECT PRIOR TO CONSTRUCTION.
6. ALL WOOD STUDS SHALL BE NO. 1 / NO. 2 SPRUCE PINE FIR (UNO), APARTMENT WOOD STUD BEARING / SHEAR WALLS BELOW THIRD FLOOR SHALL BE COMPRISED OF THE FOLLOWING, UNLESS NOTED OTHERWISE:
LOCATION STUD SIZE / SPACING
EXTERIOR 2x6 AT 16" OC
STAIR SHAFT 2x6 AT 16" OC
ELEVATOR SHAFT 2x6 AT 16" OC
NON-BEARING 2x4 AT 24" OC (UNO)
WOOD STUD BEARING WALLS SHOWN ON PLAN SHALL BE BLOCKED AT 4'-0" OC.
7. WOOD TRUSS LAYOUT AS SHOWN ON PLAN IS DIAGRAMMATIC. ALIGN TRUSSES WITH STUDS BELOW WHERE POSSIBLE. COORDINATE ALL TRUSS LOCATIONS WITH MECHANICAL FLOOR PARAMETERS. PROVIDE DOUBLE JOISTS AND HEADERS AT ALL OPENINGS WIDER THAN TRUSS SPACING. CONNECT HEADERS TO DOUBLE TRUSS WITH JOIST HANGERS.
8. PRE-ENGINEERED WOOD FLOOR TRUSSES NOTED, THUS:
PWT WOOD TRUSSES AT DEPTH AND SPACING NOTED ON PLAN
9. PRE-ENGINEERED TRUSSES SHALL BE DESIGNED FOR THE FOLLOWING MINIMUM SUPERIMPOSED LIVE AND DEAD LOADS BEYOND THE SELF-WEIGHT OF TRUSSES:
FLOOR TYPE DEAD LIVE DEAD LIVE
OFFICES 15 PSF 50 PSF 5 PSF 0 PSF
WOOD FLOOR TRUSS DEFLECTION SHALL NOT EXCEED L/480 FOR LIVE LOAD AND L/360 FOR TOTAL LOAD.
10. FOR WOOD BEAM AND LINTEL SCHEDULES, REFER TO SHEET S1.01. ALL WOOD BEAMS NOTED, THUS: '80' ARE TO BE FLUSH FRAMED WITH FLOOR. ALL WOOD LINTELS NOTED, THUS: 'L0' ARE TO BE ELEVATED AT HEAD OF OPENING.
11. STARS SHALL BE DESIGNED FOR 100 POUNDS PER SQUARE FOOT LIVE LOAD. SUBMIT SIGNED AND SEALED SHOP DRAWINGS OF STAR FRAMING AND HANDRAILS PREPARED BY A REGISTERED PROFESSIONAL ENGINEER FROM THE STATE OF MARYLAND FOR REVIEW.
12. MASONRY WALLS SHALL BE 8" MASONRY (fm = 2500 PSI) REINFORCED PER MASONRY WALL SCHEDULE ON S1.00.
13. REFER TO ARCHITECTURAL AND MECHANICAL DRAWINGS FOR LOCATIONS AND REQUIREMENTS AT LOUVERED OPENINGS BELOW EXTERIOR WINDOWS. FOR FRAMING MODIFICATIONS AT LOUVERED OPENINGS, SEE DETAIL.
14. STRUCTURAL STEEL WIDE FLANGE BEAMS SHALL CONFORM TO ASTM A-992, GRADE 50. HOLLOW STRUCTURAL STEEL TUBE SHALL CONFORM TO ASTM A500, GRADE B (Fy=46 KSI). STRUCTURAL STEEL PLATES, ANGLES AND CHANNELS SHALL CONFORM TO ASTM A36.
15. ALL EXPOSED STRUCTURAL STEEL SHALL BE HOT-DIPPED GALVANIZED.
16. STARS SHALL BE DESIGNED FOR 100 POUNDS PER SQUARE FOOT LIVE LOAD. SUBMIT SIGNED AND SEALED SHOP DRAWINGS TO ENGINEER FOR REVIEW. STARS TO BE METAL PAN. SEE ARCHITECTURAL DRAWINGS FOR RISERS AND TREAD DIMENSIONS. ALL STAR CHANNELS BEARING ON MASONRY WALLS SHALL REQUIRE 6" x 6" x 1/4" BEARING PLATES AND 1/2" x 8" LONG ANCHOR BOLT WITH 2" HOOK.
17. PROVIDE DOUBLE 8" WIDE x 8" DEEP CONT. BOND BEAM AROUND PERIMETER OF ELEVATOR AND STAIR WITH 2#5 CONT. BOTTOM REINFORCING EACH COURSE AND FILLED SOLID WITH 3000 PSI GROUT AT EACH FLOOR AND ROOF ELEVATION. PROVIDE 90 DEGREE HOOK BARS AT CORNERS.




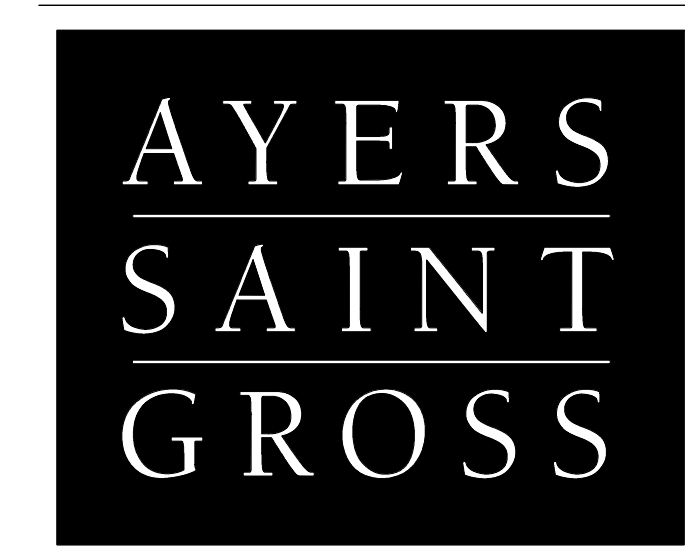
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- ARCHITECT: AYERS SAINT GROSS
M/E/P & FIRE PROTECTION ENGINEER: MUELLER ASSOCIATES
STRUCTURAL ENGINEER: MORABITO CONSULTANTS
CIVIL ENGINEER: WBCM
LANDSCAPE ARCHITECT: AYERS SAINT GROSS
IT / AV / SECURITY: SPEXSYS
COMMISSIONING: KIBART
CODE CONSULTANT: KOFFEL ASSOCIATES

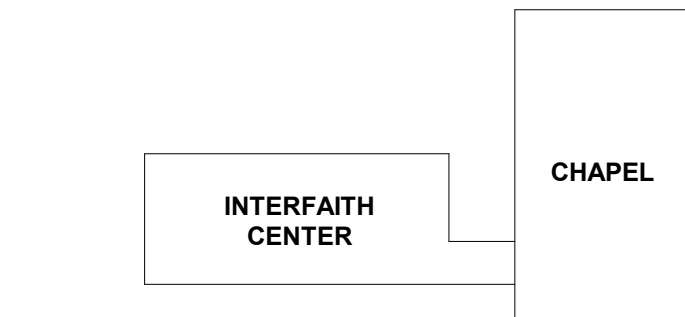Table with 3 columns: REV. #, DESCRIPTION, DATE. Includes a KEY PLAN section below it.



ARCHITECTS + PLANNERS

NOT FOR CONSTRUCTION

Table with 2 columns: ISSUE DATE, SCALE, JOB NO., DRAWN BY. Values include 04/28/17, As indicated, 16072, and CRS.

PROJECT DESIGN PHASE


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DRAWING NAME

ROOF FRAMING PLAN

DRAWING NUMBER

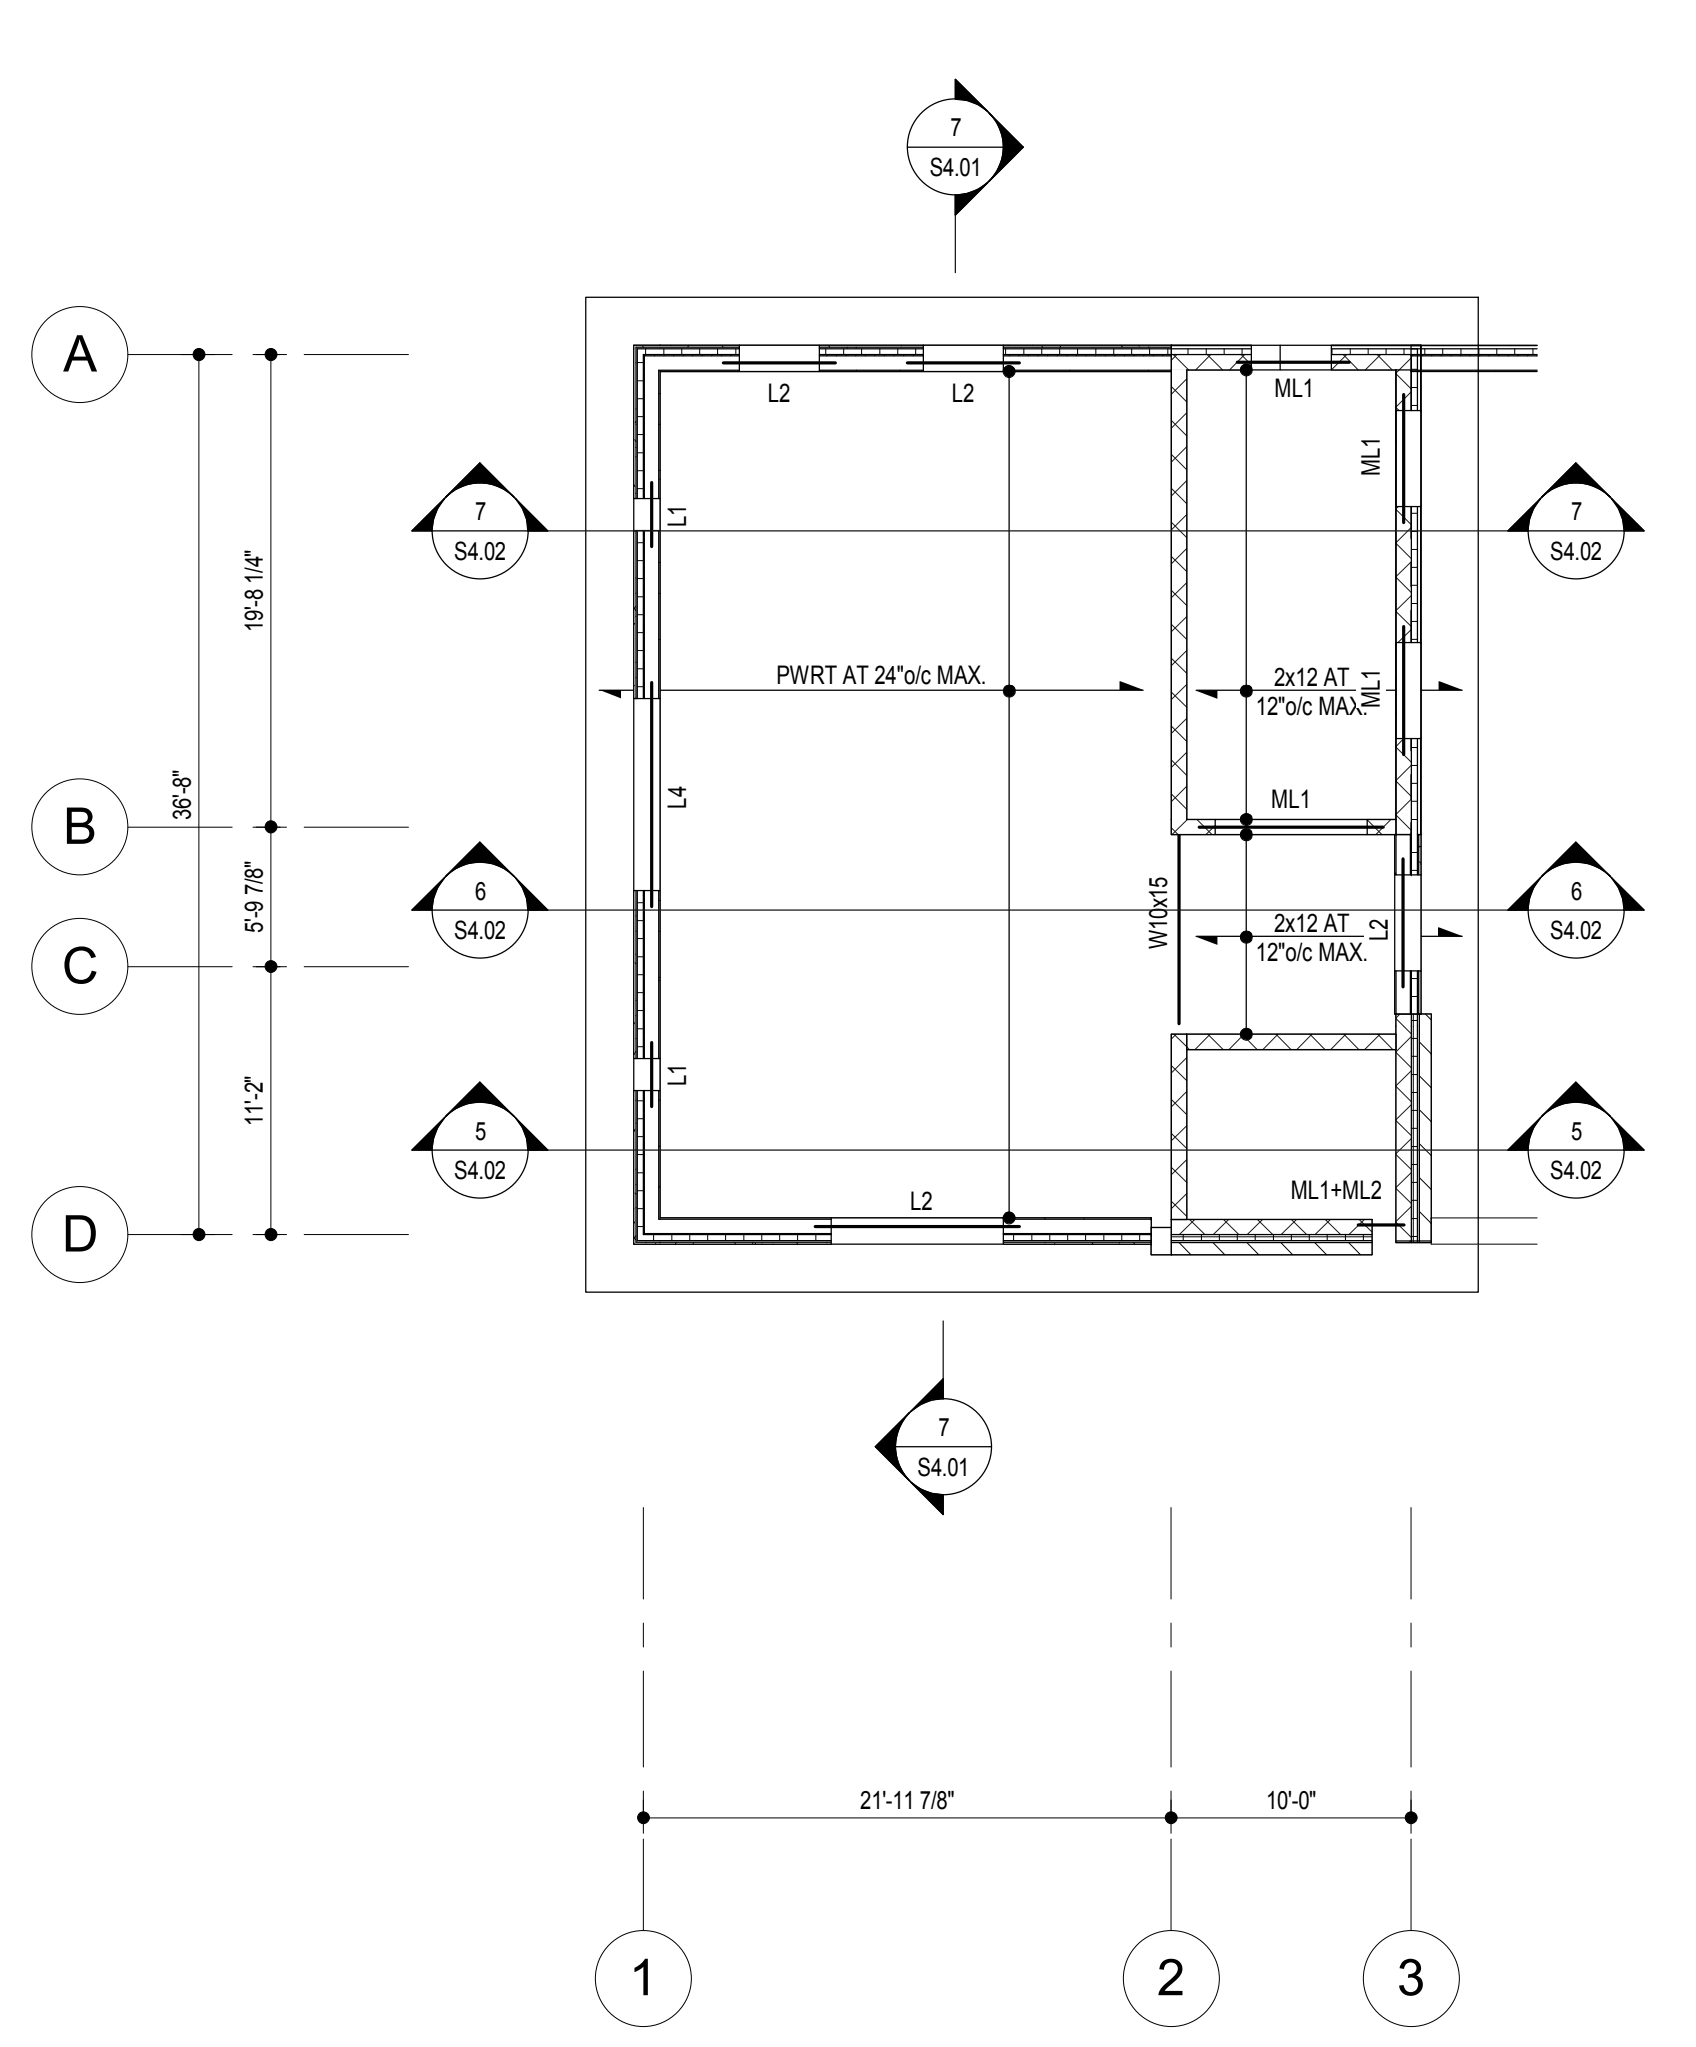S1.03




HIGH ROOF FRAMING PLAN SCALE: 1/8" = 1'-0"

- 1. ELEVATION TOP OF STRUCTURAL WOOD FRAMED ROOF VARIES...
2. STRUCTURAL ROOF DECK OVER WOOD TRUSSES SHALL BE 1902' EXTERIOR 2416 EXPOSURE 1 APA RATED PLYWOOD...
3. WALL TYPES ARE SHOWN ON PLAN, THUS:
4. CONTRACTOR SHALL COORDINATE ALL DIMENSIONS AND ELEVATIONS WITH ARCHITECT PRIOR TO CONSTRUCTION.
5. ALL WOOD STUDS SHALL BE NO. 1 NO. 2 SPRUCE PINE FIR AND SHALL BE COMPRISED OF THE FOLLOWING, UNLESS NOTED OTHERWISE.
6. WOOD TRUSS LAYOUT AS SHOWN ON PLAN IS DIAGRAMMATIC...
7. PRE-ENGINEERED TRUSSES SHALL BE DESIGNED FOR THE FOLLOWING MINIMUM SUPERIMPOSED LIVE AND DEAD LOADS BEYOND THE SELF WEIGHT OF TRUSSES.
8. FOR WOOD BEAM AND LINTEL SCHEDULES, REFER TO SHEET S1.01...
9. STAIRS SHALL BE DESIGNED FOR 100 POUNDS PER SQUARE FOOT LIVE LOAD...
10. MASONRY WALLS SHALL BE 8" MASONRY (fm = 2500 PSI) REINFORCED PER MASONRY WALL SCHEDULE ON S1.01.
11. REFER TO ARCHITECTURAL AND MECHANICAL DRAWINGS FOR LOCATIONS AND REQUIREMENTS AT LOUVERED OPENINGS...
12. STRUCTURAL STEEL WIDE FLANGE BEAMS SHALL CONFORM TO ASTM A-992, GRADE 50...
13. ALL EXPOSED STRUCTURAL STEEL SHALL BE HOT-DIPPED GALVANIZED.
14. STAIRS SHALL BE DESIGNED FOR 100 POUNDS PER SQUARE FOOT LIVE LOAD...
15. PROVIDE DOUBLE 8" WIDE x 8" DEEP CONT. BOND BEAM AROUND PERIMETER OF ELEVATOR AND STAIR WITH 265 CONT. BOTTOM REINFORCING EACH COURSE AND FILLED SOLID WITH 3000 PSI GROUT AT EACH FLOOR AND ROOF ELEVATION.

Table with 4 columns: LOCATION, STUD SIZE / SPACING, EXTERIOR, NON-BEARING. Values include 2x8 AT 16" OC and 2x4 AT 24" OC (UNO).

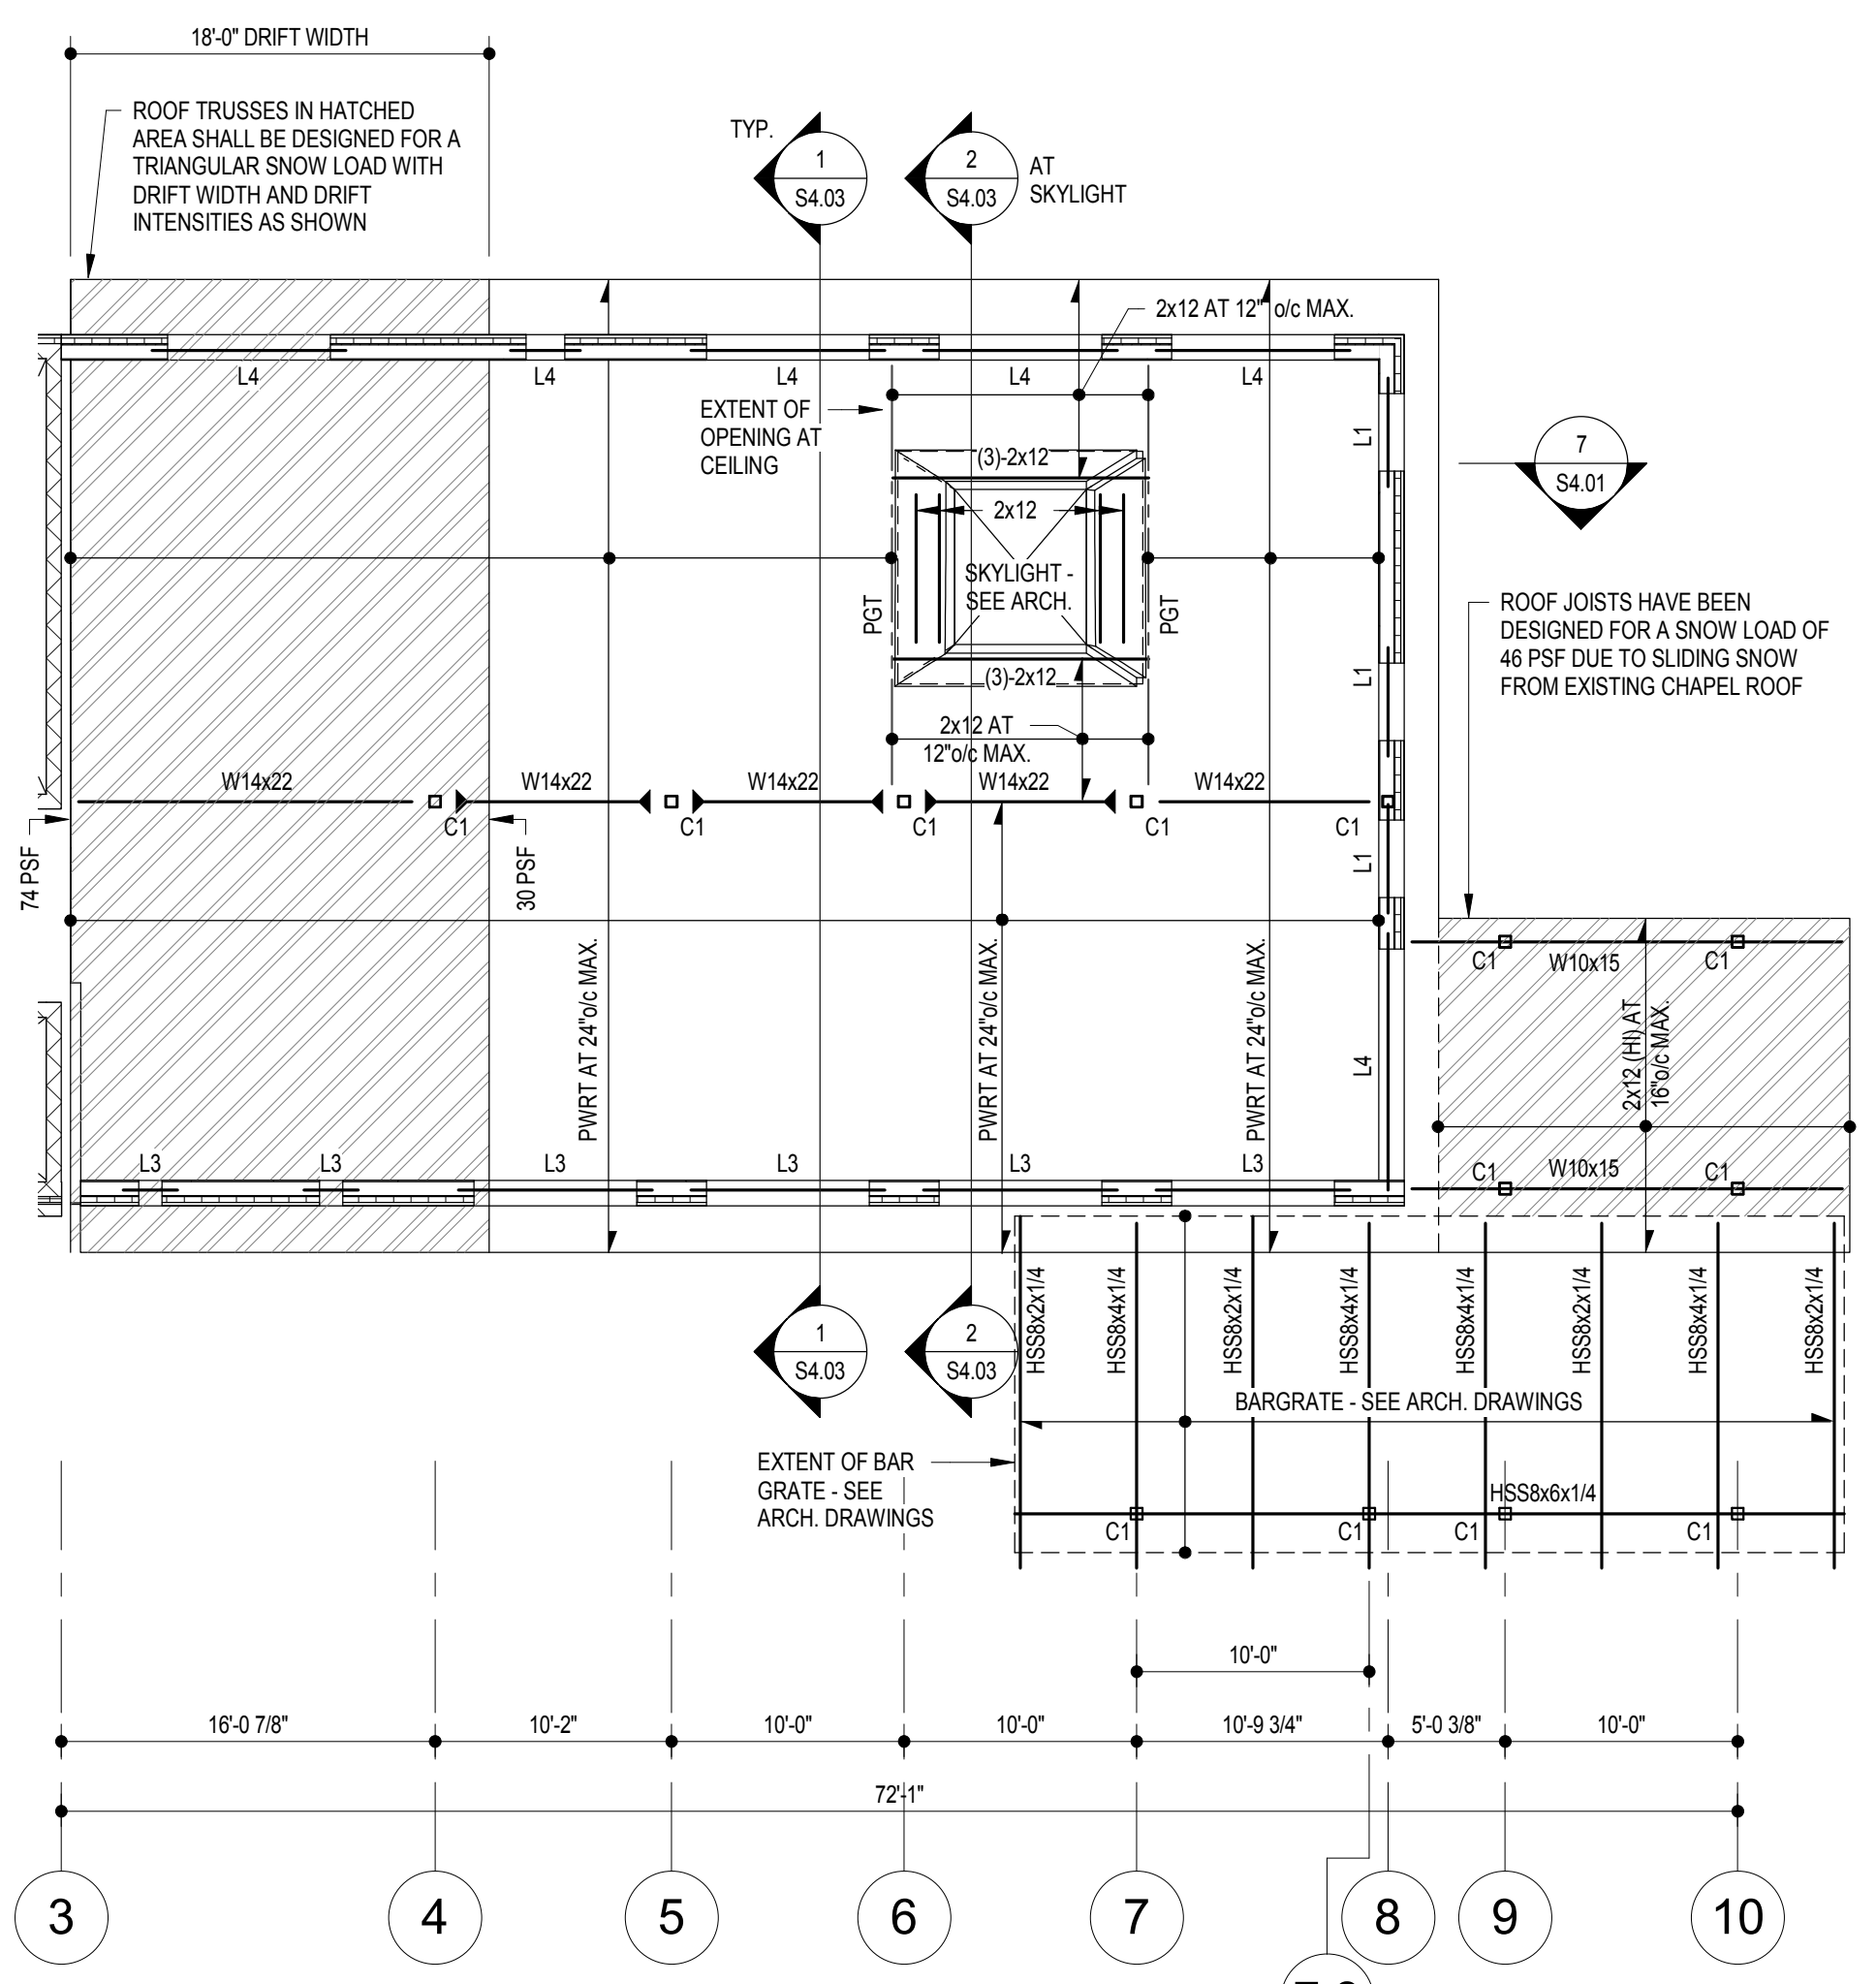Table with 4 columns: ROOF TYPE, TOP CHORD, BOTTOM CHORD, DEAD, LIVE, DEAD, LIVE. Values include 15 PSF, 30 PSF, 10 PSF, 0 PSF.




LOW ROOF FRAMING PLAN SCALE: 1/8" = 1'-0"

- 1. ELEVATION TOP OF STRUCTURAL WOOD FRAMED ROOF VARIES...
2. STRUCTURAL ROOF DECK OVER WOOD TRUSSES SHALL BE 1902' EXTERIOR 2416 EXPOSURE 1 APA RATED PLYWOOD...
3. WALL TYPES ARE SHOWN ON PLAN, THUS:
4. CONTRACTOR SHALL COORDINATE ALL DIMENSIONS AND ELEVATIONS WITH ARCHITECT PRIOR TO CONSTRUCTION.
5. ALL WOOD STUDS SHALL BE NO. 1 NO. 2 SPRUCE PINE FIR AND SHALL BE COMPRISED OF THE FOLLOWING, UNLESS NOTED OTHERWISE.
6. WOOD TRUSS LAYOUT AS SHOWN ON PLAN IS DIAGRAMMATIC...
7. PRE-ENGINEERED TRUSSES SHALL BE DESIGNED FOR THE FOLLOWING MINIMUM SUPERIMPOSED LIVE AND DEAD LOADS BEYOND THE SELF WEIGHT OF TRUSSES.
8. FOR WOOD BEAM AND LINTEL SCHEDULES, REFER TO SHEET S1.01...
9. STAIRS SHALL BE DESIGNED FOR 100 POUNDS PER SQUARE FOOT LIVE LOAD...
10. MASONRY WALLS SHALL BE 8" MASONRY (fm = 2500 PSI) REINFORCED PER MASONRY WALL SCHEDULE ON S1.01.
11. REFER TO ARCHITECTURAL AND MECHANICAL DRAWINGS FOR LOCATIONS AND REQUIREMENTS AT LOUVERED OPENINGS...
12. STRUCTURAL STEEL WIDE FLANGE BEAMS SHALL CONFORM TO ASTM A-992, GRADE 50...
13. ALL EXPOSED STRUCTURAL STEEL SHALL BE HOT-DIPPED GALVANIZED.
14. STAIRS SHALL BE DESIGNED FOR 100 POUNDS PER SQUARE FOOT LIVE LOAD...
15. PROVIDE DOUBLE 8" WIDE x 8" DEEP CONT. BOND BEAM AROUND PERIMETER OF ELEVATOR AND STAIR WITH 265 CONT. BOTTOM REINFORCING EACH COURSE AND FILLED SOLID WITH 3000 PSI GROUT AT EACH FLOOR AND ROOF ELEVATION.
16. FULL CONTINUITY MOMENT CONNECTIONS ARE INDICATED ON PLAN THUS: SHALL HAVE FULL PENETRATION WELDS AT BEAM TO COLUMN TO DEVELOP FULL CAPACITY OF SECTION.

Table with 4 columns: LOCATION, STUD SIZE / SPACING, EXTERIOR, NON-BEARING. Values include 2x8 AT 16" OC and 2x4 AT 24" OC (UNO).

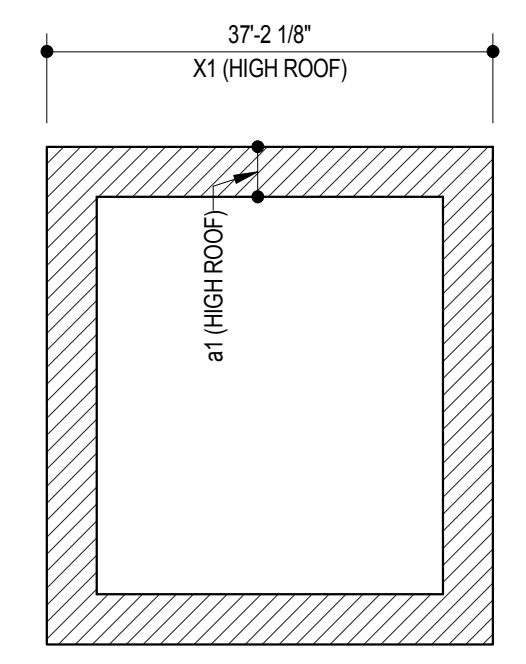
Table with 4 columns: ROOF TYPE, TOP CHORD, BOTTOM CHORD, DEAD, LIVE, DEAD, LIVE. Values include 15 PSF, 30 PSF, 10 PSF, 0 PSF.



PART PLAN: HIGH ROOF SHEATHING FASTENING

Table with 3 columns: PANEL LOCATION, ZONE 1, ZONE 2. Values include 6" and 3" for panel end and edge supports.

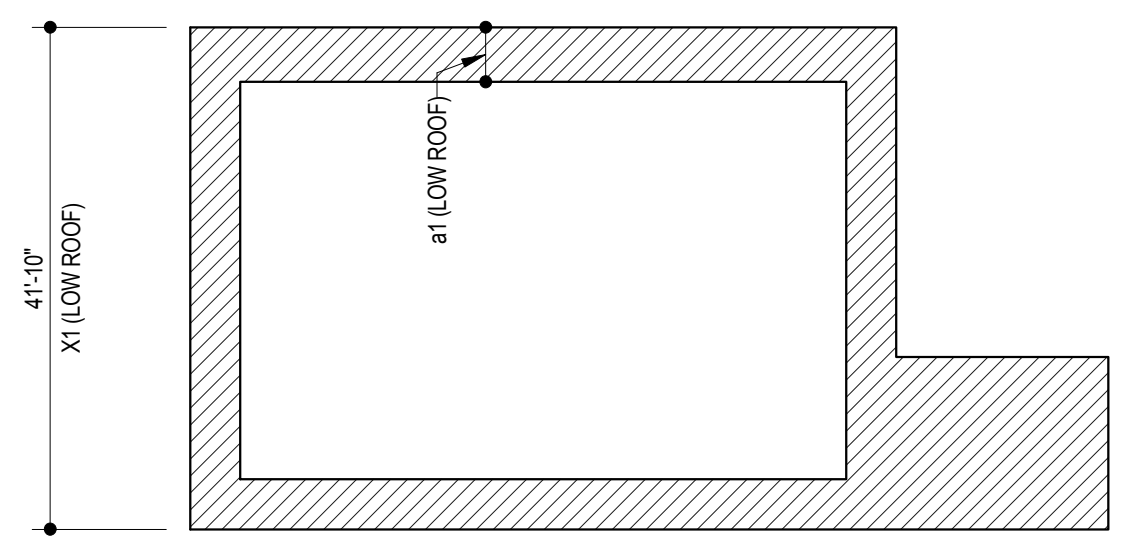Wood Fastening Schedule NOT TO SCALE



PART PLAN: LOW ROOF SHEATHING FASTENING

- 1. SHEATHING FASTENERS SHALL BE 8d RING SHANK NAILS.
2. DIMENSION "n1" SHALL BE 10% OF DIMENSION "x1" OR 40% OF THE BUILDING HEIGHT (WHICHEVER IS SMALLER), BUT NOT LESS THAN 3 FEET.
3. BLOCK PANEL EDGES PERPENDICULAR TO END WALL FRAMING MEMBERS WITHIN ZONE 2. BLOCKING SHALL HAVE A MAXIMUM SPACING OF 4'-0".
4. REFER TO ARCHITECTURAL DRAWINGS FOR BUILDING DIMENSIONS.

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Table with 3 columns: REV. #, DESCRIPTION, DATE. Includes revision 1 for 'REVISIONS'.

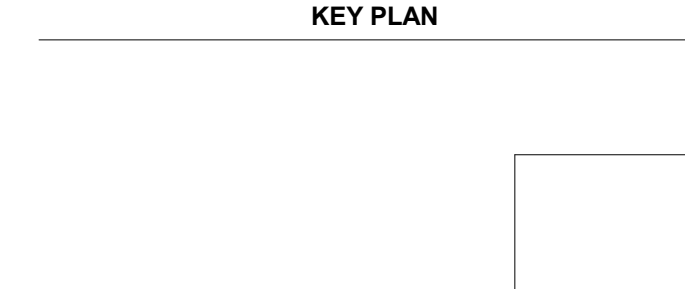


Table with 3 columns: REV. #, DESCRIPTION, DATE. Includes revision 1 for 'REVISIONS'.

AYERS SAINT GROSS
ARCHITECTS + PLANNERS

NOT FOR CONSTRUCTION

DRAWING INFORMATION table with fields: ISSUE DATE, SCALE, JOB NO., DRAWN BY.

PROJECT DESCRIPTION
FOUNDATION DETAILS AND GENERAL NOTES

DRAWING NUMBER
S2.01

GENERAL NOTES

CONTRACTOR RESPONSIBILITIES: THE STRUCTURE IS DESIGNED TO BE SELF-SUPPORTING AND STABLE AFTER THE BUILDING IS FULLY COMPLETED. IT IS SOLELY THE CONTRACTOR'S RESPONSIBILITY TO DETERMINE ERECTION PROCEDURES AND SEQUENCE, AND TO ENSURE THE STABILITY OF THE BUILDING AND ITS COMPONENT PARTS, AND THE ADEQUACY OF TEMPORARY OR INCOMPLETE CONNECTIONS DURING ERECTION. THIS INCLUDES THE ADDITION OF ANY SHORING, SHEETING, TEMPORARY GUYS, BRACING OR TIEBACKS THAT MAY BE NECESSARY. SUCH MATERIAL IS NOT SHOWN ON THE DRAWINGS. IF APPLIED, THEY SHALL BE REMOVED AS CONDITIONS PERMIT AND SHALL REMAIN THE CONTRACTOR'S PROPERTY. THE ENGINEER HAS NO EXPERTISE IN, AND TAKES NO RESPONSIBILITY FOR, CONSTRUCTION METHODS AND METHODS OR JOBSITE SAFETY DURING CONSTRUCTION. PROCESSING AND/OR APPROVED SUBMITTALS MADE BY THE CONTRACTOR WHICH RELATE TO CONSTRUCTION METHODS OR METHODS OF SAFETY ISSUES, OR PARTICIPATION IN MEETINGS WHERE SUCH ISSUES MIGHT BE DISCUSSED, SHALL NOT BE CONSTRUED AS VOLUNTARY ASSUMPTION BY THE ENGINEER OR ANY RESPONSIBILITY OF EACH CONTRACTOR TO FOLLOW ALL APPLICABLE SAFETY CODES AND REGULATIONS DURING ALL PHASES OF CONSTRUCTION. THE ENGINEER IS NOT ENGAGED IN, AND DOES NOT SUPERVISE CONSTRUCTION.

CONTROLLED FILL AND BACKFILL: SAMPLES OF ALL MATERIALS THAT THE CONTRACTOR PROPOSES TO USE FOR COMPACTED FILL SHALL BE APPROVED BY THE GEOTECHNICAL ENGINEER. COMPACTED FILL SHALL CONSIST OF LOCAL MATERIAL, FREE OF DELETERIOUS MATTER AND CLASSIFIED CL, SC, CC, GM, OR SM PER ASTM D-2487. THE CONTROL OF THE MOISTURE FOR PLACING THE FILL WILL BE BASED ON THE RESULTS OF COMPACTION TESTS PER ASTM D-1557. ALL COMPACTED FILL SHALL HAVE A DENSITY OF AT LEAST 95% OF THE PROCTOR MAXIMUM DRY DENSITY AS DETERMINED BY ASTM D-1557. PRIOR TO PLACEMENT OF ANY FILLS, THE SITE SHALL BE STRIPPED OF ALL TOPSOIL, VEGETATION, ROCKS, AND ORGANIC MATERIALS AND THE EXPOSED SUBGRADE SHALL BE COMPACTED IN PLACE TO A CONFIRMED DENSITY OF 95% OF THE MODIFIED PROCTOR MAXIMUM DRY DENSITY. FILL MATERIAL SHALL BE PLACED IN LOOSE LIFTS NOT EXCEEDING 9" IN THICKNESS AND SHALL BE MIXED, SPREAD AND PLACED IN SUCH A MANNER AS TO PRODUCE A UNIFORM THICKNESS OF MATERIAL AFTER PLACING. EACH LAYER OF FILL SHALL BE COMPACTED WITH A MINIMUM OF 6 COMPLETE PASSES ON ALL PORTIONS OF THE SURFACE OF EACH LIFT OF FILL BY RUBBER-TIRED ROLLERS, SHEEPSFOOT ROLLERS OR OTHER MECHANICAL EQUIPMENT UNDER THE SUPERVISION OF THE ENGINEER. FILL SHOULD NOT BE ALLOWED WITHIN 4 FEET OF STRUCTURES UNLESS A MINIMUM 2 FEET DEPTH OF FILL COVERS THE STRUCTURES. WHENEVER IN PLACE DENSITIES ARE FOUND BELOW ACCEPTABLE LIMITS, ADDITIONAL ROLLING TO PRODUCE THE SPECIFIED DENSITIES SHALL BE REQUIRED. THE CONTRACTOR SHALL TAKE ALL MEASURES REQUIRED TO PROVIDE FOR FREE DRAINAGE OF THE SITE AND TO PREVENT PONDING OF WATER. SEDIMENT CONTROL MEASURES SHALL BE MAINTAINED AT ALL TIMES TO PREVENT EROSION OF SOIL. PLACING OF FILL WITH FILL WITH MOISTURE CONTENT TOO HIGH OR TOO LOW FOR PROPER COMPACTION; PLACING OF FILL WHEN FREE WATER IS STANDING ON THE EXISTING FILL SURFACE; PLACING OF FILL IN A FROZEN CONDITION OR ON TOP OF FROZEN MATTER WILL NOT BE PERMITTED. THE SOILS VERIFIED BY A REGISTERED GEOTECHNICAL ENGINEER. IF SOIL OF THIS BEARING CAPACITY IS NOT ENCOUNTERED AT THE ELEVATIONS INDICATED ON THE CONTRACT DRAWINGS, FOOTINGS SHALL BE LOWERED OR REDESIGNED BY THE STRUCTURAL ENGINEER. ELEVATIONS SHOWN ON PLAN ARE TO THE BOTTOM OF THE FOOTINGS.

FOUNDATIONS: SPREAD FOOTINGS: BOTTOM OF ALL FOOTINGS SHALL BE A MINIMUM OF 2'-0" BELOW ORIGINAL GRADE OR PLACED IN APPROVED COMPACTED FILL. BOTTOM OF ALL EXTERIOR FOOTINGS SHALL BE A MINIMUM OF 2'-0" BELOW FINISHED GRADE. FOR SOIL BEARING CAPACITY THAT WAS USED IN THE FOUNDATION DESIGN, SEE PLAN. SOIL BEARING VALUES SHALL BE VERIFIED BY A REGISTERED GEOTECHNICAL ENGINEER. IF SOIL OF THIS BEARING CAPACITY IS NOT ENCOUNTERED AT THE ELEVATIONS INDICATED ON THE CONTRACT DRAWINGS, FOOTINGS SHALL BE LOWERED OR REDESIGNED BY THE STRUCTURAL ENGINEER. ELEVATIONS SHOWN ON PLAN ARE TO THE BOTTOM OF THE FOOTINGS.

CONCRETE: ALL CONCRETE WORK SHALL CONFORM TO ALL THE PROVISIONS OF THE "SPECIFICATIONS FOR STRUCTURAL CONCRETE FOR BUILDINGS (ACI 301-88) AND TO THE "BUILDING CODE REQUIREMENTS FOR REINFORCED CONCRETE (ACI 318-88). ALL STRUCTURAL CONCRETE SHALL HAVE A MINIMUM 28-DAY COMPRESSIVE STRENGTH OF 3000 POUNDS PER SQUARE INCH. ADDITIONALLY, THE CONCRETE SHALL CONFORM TO ALL THE PROVISIONS OF "RECOMMENDED PRACTICE FOR HOT WEATHER CONCRETE" (ACI 305-82) AND "RECOMMENDED PRACTICE FOR COLD WEATHER CONCRETE" (ACI 308-82). ALL FORMWORK SHALL BE IN ACCORDANCE WITH THE AMERICAN CONCRETE INSTITUTE FORMWORK FOR CONCRETE SPECIAL PUBLICATION NO. 4 AND ACI 308.2R STANDARD RECOMMENDED PRACTICE FOR CONCRETE FORMWORK (ACI 347-14 1ST EDITION). ALL CONCRETE EXPOSED TO THE WEATHER SHALL HAVE AN ENTRAINMENT OF 5% +/- 1%. THE MAXIMUM WATER CEMENT RATIO W/C SHALL NOT EXCEED 0.53 FOR ALL CONCRETE EXCEPT CONCRETE EXPOSED TO WEATHER WHICH SHALL NOT EXCEED 0.45. NO ADMIXTURES CONTAINING CALCIUM CHLORIDE SHALL BE PERMITTED. THE MAXIMUM SLUMP OF ALL CONCRETE SHALL BE 4". FLOOR SLABS SHALL BE FINISHED TO A MINIMUM FINATNESS F-NUMBER F1 + 30 AND A MINIMUM LEVELNESS F-NUMBER F1 + 25 IN ANY DIRECTION. ALL CONCRETE SHALL BE CURED WITH A SEALING COMPOUND CONFORMING TO ASTM C-309, TYPE I AND FEDERAL SPECIFICATION TT-C-00800 OR OTHER APPROVED METHOD WHICH IS COMPATIBLE WITH FLOORING ADHESIVES AND OTHER SURFACE TREATMENTS. ALL CONCRETE SHALL BE CURED WITH A SEALING COMPOUND CAPABLE OF PREVENTING INFILTRATION OF WATER BORNE CHLORIDES SUCH AS CONCRETE #1 BY CONCRETE MARKETING & MANUFACTURING CORPORATION. LOADS GREATER THAN THE DESIGN LIVE LOADS SHALL NOT BE PLACED ON THE STRUCTURE. A CONCRETE STRUCTURE MAY NOT SUPPORT ITS DESIGN LIVE LOAD FOR 28 DAYS. CONTRACTOR SHALL SUPPORT ADJACENT STRUCTURES, UTILITIES, AND EXCAVATIONS REQUIRED FOR COMPLETION OF WORK. CONTRACTOR SHALL SUBMIT SHOP DRAWINGS FOR ALL TEMPORARY FORMWORK INCLUDING STRIPPING PROCEDURES FOR CONCRETE FLAT SLABS, SHEETING, SHORING, UNDERPINNING, ETC. SEALED BY A REGISTERED PROFESSIONAL ENGINEER AS PART OF THE CONTRACTOR'S WORK.

CONCRETE SLAB ON GRADE CONSTRUCTION: THE CONCRETE SLABS ON GRADE FOR THIS PROJECT HAVE BEEN DESIGNED UTILIZING A MODULUS OF SUBGRADE REACTION "K" EQUAL TO 250 PCF FOR ALL WAREHOUSES, LOADING DOCKS, AND OTHER STORAGE AREAS, AND A MODULUS OF SUBGRADE REACTION "K" EQUAL TO 100 PCF FOR ALL OTHER AREAS OF THE CONCRETE SLABS ON GRADE. PLEASE NOTE THAT THE CONCRETE SLABS ON GRADE THROUGHOUT THIS PROJECT ARE NOT DESIGNED TO SUPPORT THE CRANES USED DURING THE ERECTION OF THE STRUCTURE. STEEL OR CONCRETE TILT-UP WALL BEARING PANELS, IF THE CONTRACTOR ELECTS TO PLACE THE CRANE ON THE CONCRETE SLAB ON GRADE, IT IS THE CONTRACTOR'S RESPONSIBILITY TO TAKE ALL NECESSARY PRECAUTIONS, INCLUDING THE TEMPORARY INSTALLATION OF WOOD CRIBS ON THE SLAB, IN ORDER TO PREVENT CRACKS FROM FORMING IN THE SLABS ON GRADE. ALL CRACKS WHICH FORM IN THE CONCRETE SLABS ON GRADE DUE TO THE CRANE BEING PLACED ON THE SLAB WILL BE REPAIRED OR REPAIRED TO THE APPROVAL OF THE STRUCTURAL ENGINEER AND OWNER AND THE CONTRACTOR'S EXPENSE.

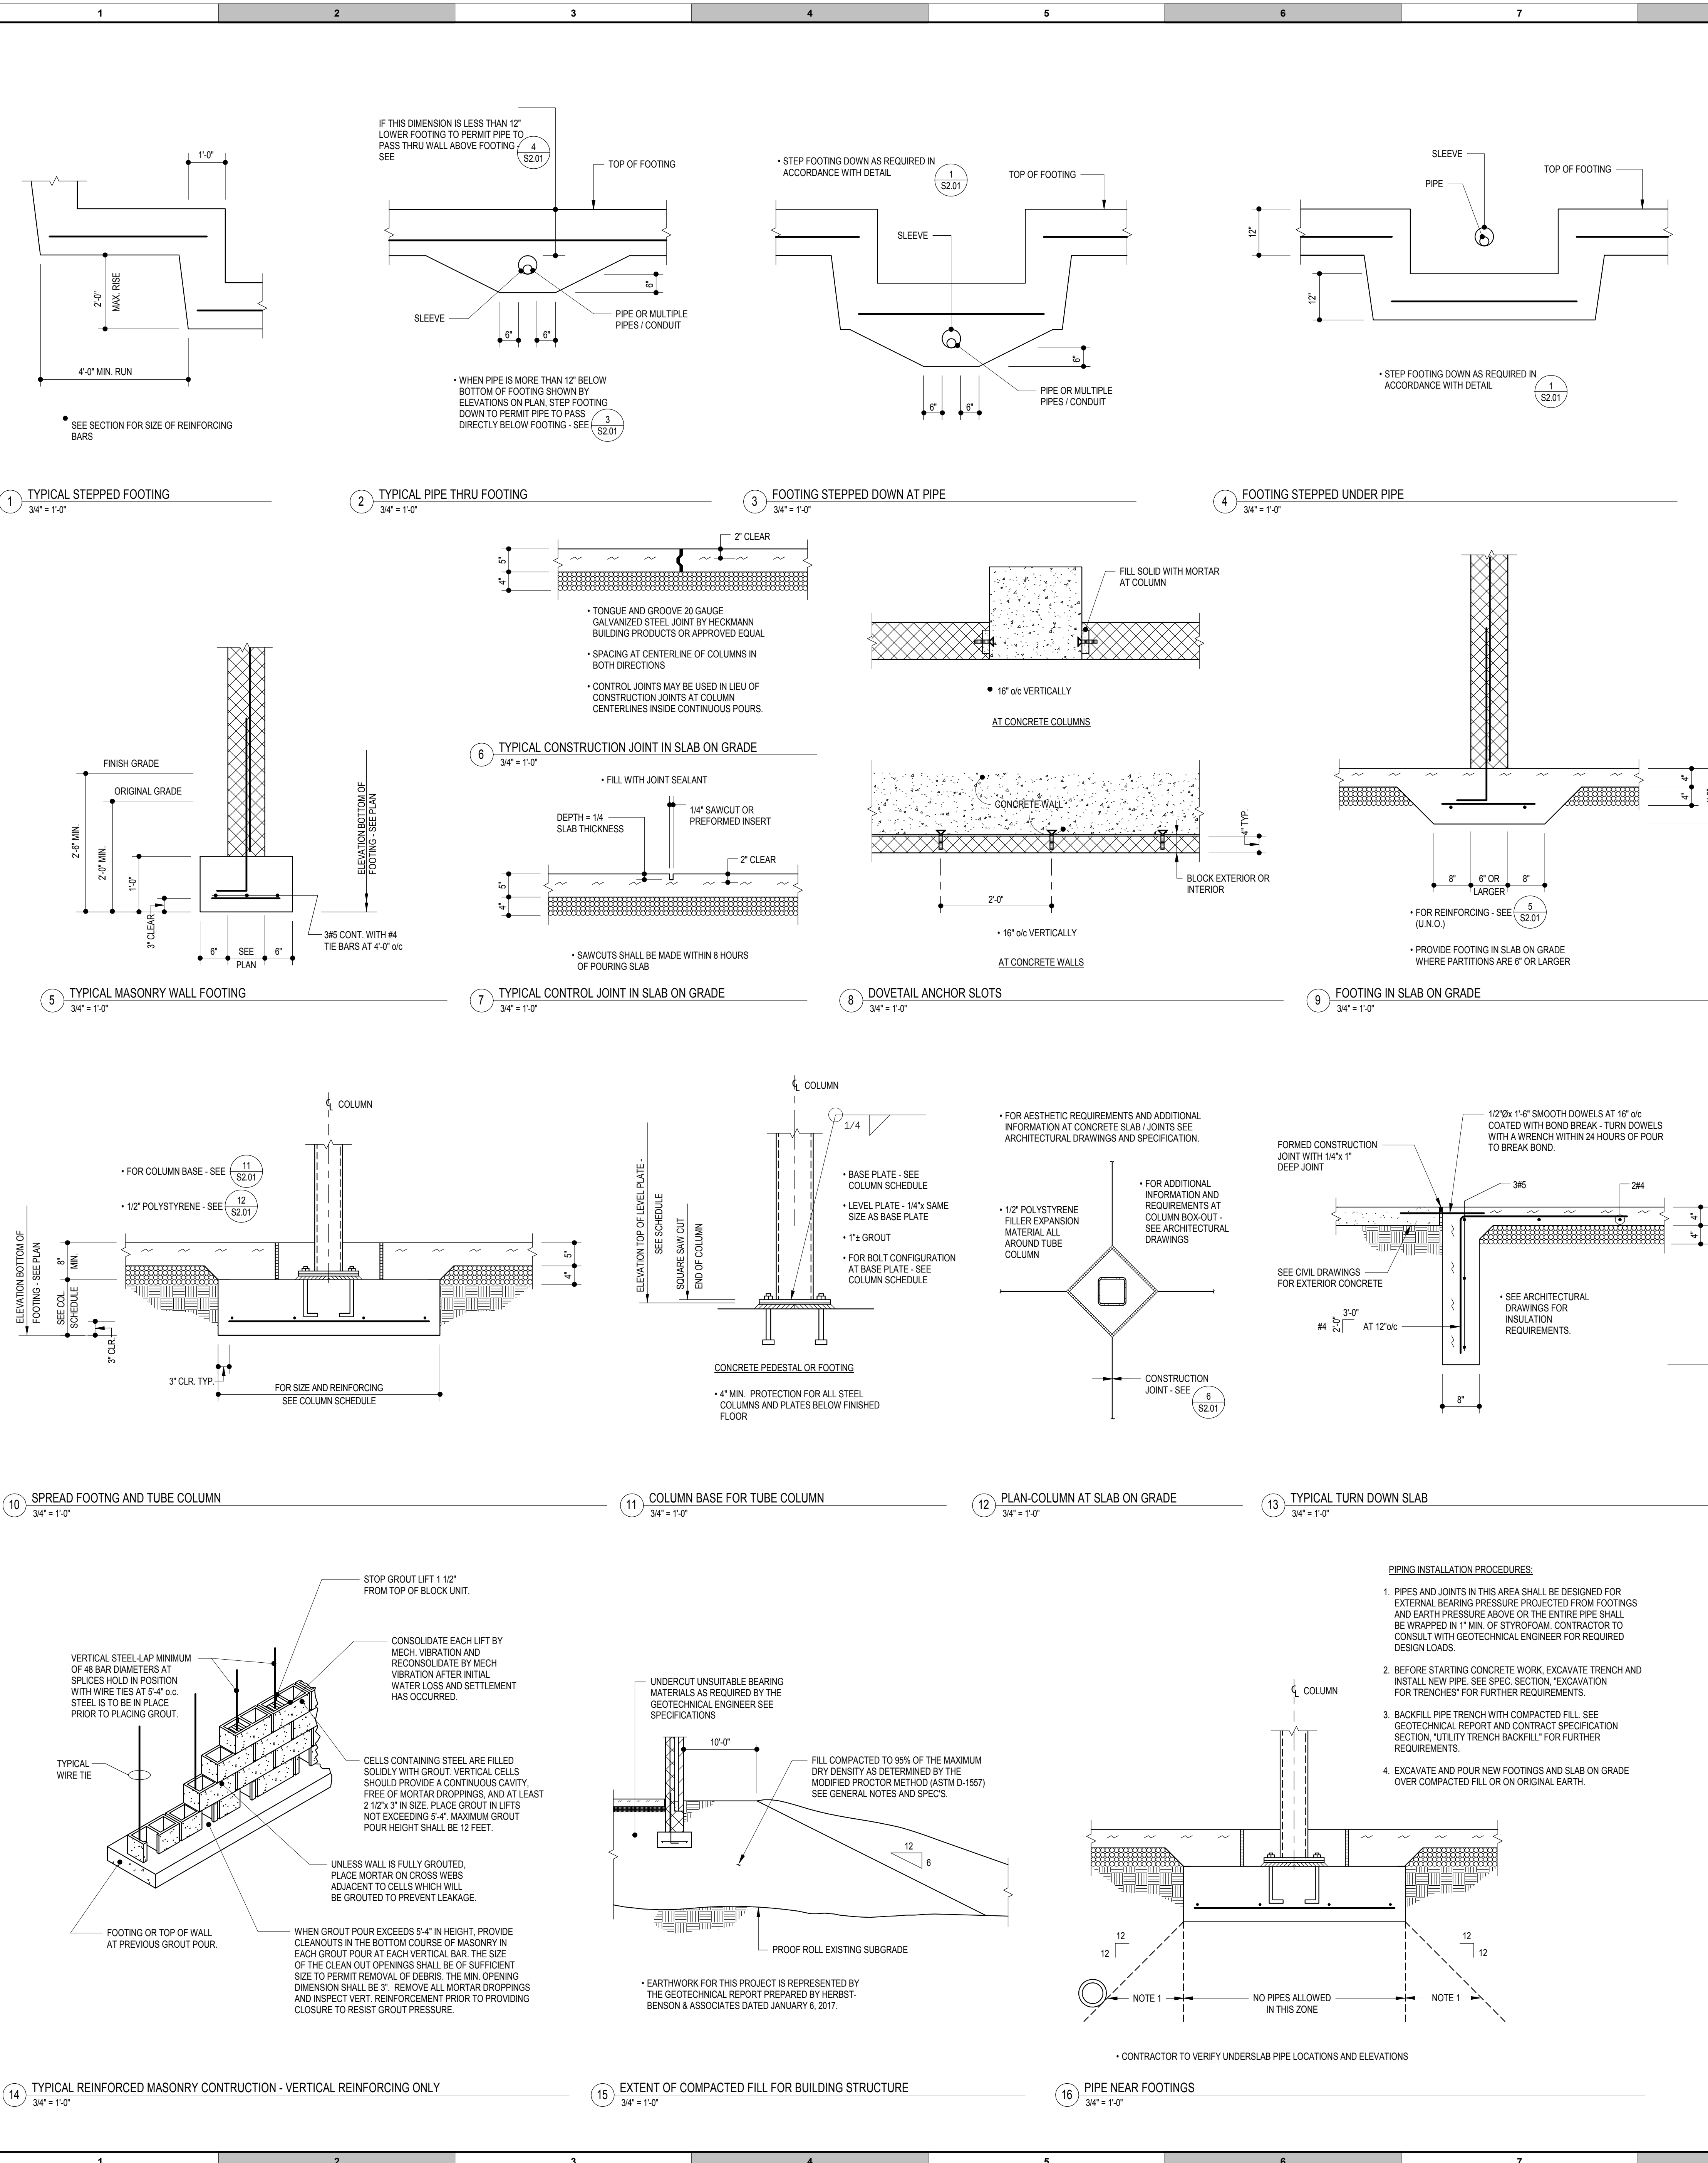
REINFORCING STEEL: REINFORCING STEEL SHALL BE DEFORMED BARS IN ACCORDANCE WITH ASTM A 603. BENDS ARE TO BE FABRICATED AS PER DETAIL. PLACE MAIN REINFORCING STEEL SO AS TO PROVIDE 3" MINIMUM COVER FOR FOUNDATIONS POURED ON EARTH; 2" MINIMUM COVER FOR BEAMS AND COLUMNS; 3/4" MINIMUM COVER FOR SLABS AND 1 1/2" FOR ALL REBAR IN EXPOSED CONCRETE. EXCEPT AS OTHERWISE DETAILLED, ALL BEAM AND SLAB STEEL SHALL HAVE A MINIMUM EXTENSION INTO THE SUPPORTS IN ACCORDANCE WITH THE LATEST ADDITION OF THE AISC CODE. PROVIDE ACCESSORIES AND BAR SUPPORTS IN ACCORDANCE WITH THE MANUAL OF STANDARD PRACTICE FOR DETAILING REINFORCED CONCRETE STRUCTURES (ACI 318-08). TOP REINFORCING IN PARKING DECKS AND ALL OTHER REINFORCING SHOWN ON THE CONTRACT DOCUMENTS SHALL BE EPOXY-COATED CONFORMING TO ASTM A 776 FOR BARS AND ASTM A 776 FOR WELDED FABRIC. WHERE REQUIRED, DAMAGED AND CUT EPOXY-COATING SHALL BE REPAIRED WITH PATCHING MATERIAL CONFORMING TO ASTM A 776. EPOXY-COATED REINFORCING BARS SHALL REST ON COATED WIRE BAR SUPPORTS MADE OF GALVANIZED MATERIAL FOR A MINIMUM DISTANCE OF 4 INCHES FROM POINT OF CONTACT WITH EPOXY-COATED REBAR. EPOXY-COATED REINFORCING BARS SHALL BE FASTENED WITH NYLON, EPOXY, OR PLASTIC-COATED WIRE. WELDED WIRE FABRIC SHALL CONFORM TO ASTM A 186, GRADE 60, UNLESS OTHERWISE NOTED. W/W REINFORCING SHALL BE PLACED AT MID-DEPTH OF SLABS ON GRADE AND DRAPED OVER SUPPORTS IN CONCRETE SLABS ON CENTERS. END LAPS OF ALL W/W REINFORCING SHALL BE LAPPED 8" MINIMUM. CONCRETE ENGINEERED REINFORCING FIBERS SHALL BE POLYPROPYLENE COLLATED, FIBRILLATED FIBERS FROM FERBERESH, INC. INSTALLED IN STRICT ACCORDANCE WITH THE MANUFACTURER'S RECOMMENDATIONS.

STRUCTURAL STEEL: STRUCTURAL STEEL PLATES, ANGLES, CHANNELS, BARS, AND ROLLED S, M, AND HP SHAPES SHALL CONFORM TO ASTM A 36, ROLLED WIDE FLANGE SHAPES SHALL CONFORM TO ASTM A 992, GRADE 50. ASTM A 572, GRADE 50. ASTM A 588, GRADE 50. STRUCTURAL STEEL TUBULAR SHAPES SHALL CONFORM TO ASTM A 500, GRADE B (F460NS) AND STRUCTURAL STEEL PIPES SHALL CONFORM TO ASTM A 53, TYPES A OR S, GRADE B (F483NS). ANCHOR BOLTS SHALL CONFORM TO ASTM F1554, GRADE 36. ALL CONNECTIONS WITH SLOTTED AND OVERSIZE HOLES SHALL HAVE SLIP CRITICAL CONNECTIONS. ALL OTHER CONNECTIONS MAY BE BEARING TYPE CONNECTIONS. ALL BOLTS SHALL CONFORM TO ASTM A 325. WELDS SHALL CONFORM TO ALL THE PROVISIONS OF THE STRUCTURAL WELDING CODE, AWS D1.1:2002 OF THE AMERICAN WELDING SOCIETY EXCEPT SECTIONS 2.3, 2.4, 2.5, 8.13, 1.2 AND 9. HEADED STUD TYPE SHEAR CONNECTORS SHALL BE COLD FINISHED CARBON STEEL COMPLYING WITH ASTM A 308, GRADE 105 OR 109, WITH DIMENSIONS COMPLYING WITH AISC SPECIFICATIONS. NO OPENINGS IN BEAMS OTHER THAN SHOWN ON THE STRUCTURAL DRAWINGS SHALL BE PERMITTED WITHOUT WRITTEN APPROVAL FROM THE STRUCTURAL ENGINEER. PROVIDE 3 MILS OF ONE OF THE FOLLOWING SHOP PAINTS: NO. 789 GREY PRIMER MANUFACTURED BY RUST-OLEUM CORPORATION; NO. 789 GREY PRIMER MANUFACTURED BY TRINEX COMPANY AND WET-SLACK PRIMER MANUFACTURED BY FARBOL COMPANY. PROVIDE SHOP AND FIELD INSPECTION OF ALL STRUCTURAL STEEL BY A TESTING LABORATORY APPROVED BY THE STRUCTURAL ENGINEER.

MASONRY: SOLID MASONRY SHALL BE GRADE N1 IN ACCORDANCE WITH ASTM C 90 AND MAY BE 75% SOLID UNLESS OTHERWISE NOTED. HOLLOW MASONRY UNITS SHALL BE GRADE N1 CONFORMING TO ASTM C 90. MASONRY UNITS SHALL HAVE A MINIMUM COMPRESSIVE STRENGTH OF 1900 PSI BASED ON THE NET CROSS SECTIONAL AREA OF THE INDIVIDUAL BLOCK UNITS. ALL MORTAR SHALL BE TYPE "S" CONFORMING TO ASTM C 270 WITH MINIMUM COMPRESSIVE STRENGTH OF 1800 PSI AT 28 DAYS. PROVIDE A MINIMUM OF 3 COURSES OF SOLID BRICK OR ONE COURSE OF 100% SOLID BLOCK PER COURSE ON ALL WALLS AND SLABS. THE FULL WIDTH OF THE WALL, UNLESS NOTED, IN BEARING WALLS, PROVIDE SOLID BRICK OR 100% BLOCK EXTENDING 6" BEYOND WALL ORNINGS THE FULL WALL THICKNESS DOWN TO THE FINISHED FLOOR, UNLESS NOTED. ALL PORTIONS OF EXTERIOR WALLS SHALL HAVE A HORIZONTAL SECTION OF 4.50 FT. OR LESS SHALL BE OF SOLID MASONRY DOWN TO FINISHED FLOOR, UNLESS NOTED. ALL MASONRY WALLS SHALL HAVE CONTROL JOINTS AT 40'-0" MAXIMUM. SEE ARCHITECTURAL DRAWINGS FOR LOCATIONS. ALL MORTAR JOINTS IN MASONRY WALLS (HORIZONTAL AND VERTICAL) SHALL BE FILLED 100% WITH MORTAR. USE BUCKETS TO MEASURE MATERIALS FOR MIXING MORTAR.

PIPE INSTALLATION PROCEDURES: 1. PIPES AND JOINTS IN THIS AREA SHALL BE DESIGNED FOR EXTERNAL BEARING PRESSURE PROJECTED FROM FOOTINGS AND EARTH PRESSURE ABOVE OR THE ENTIRE PIPE SHALL BE WRAPPED IN 1" MIN. OF STYROFOAM. CONTRACTOR TO CONSULT WITH GEOTECHNICAL ENGINEER FOR REQUIRED DESIGN LOADS. 2. BEFORE STARTING CONCRETE WORK, EXCAVATE TRENCH AND INSTALL NEW PIPE, SEE SPEC. SECTION "EXCAVATION FOR TRENCHES" FOR FURTHER REQUIREMENTS. 3. BACKFILL PIPE TRENCH WITH COMPACTED FILL. SEE GEOTECHNICAL REPORT AND CONTRACT SPECIFICATION SECTION "UTILITY TRENCH BACKFILL" FOR FURTHER REQUIREMENTS. 4. EXCAVATE AND POUR NEW FOOTINGS AND SLAB ON GRADE OVER COMPACTED FILL OR ON ORIGINAL EARTH.

PIPE NEAR FOOTINGS: NO PIPES ALLOWED IN THIS ZONE.



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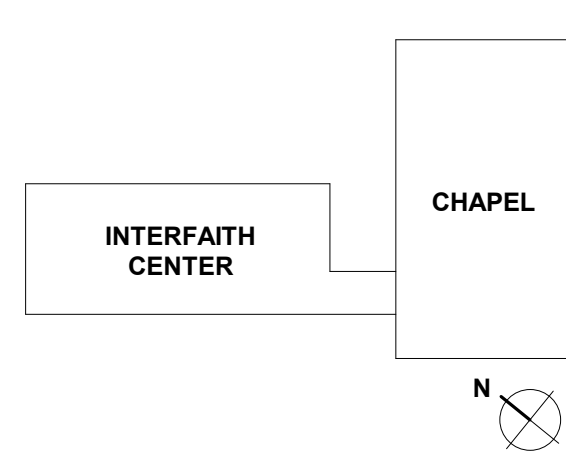
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REVISIONS

REV. #	DESCRIPTION	DATE
1	Revision 1	Date 1

KEY PLAN



ARCHITECTS + PLANNERS

NOT FOR CONSTRUCTION

DRAWING INFORMATION	
ISSUE DATE:	04/28/17
SCALE:	3/4" = 1'-0"
JOB NO.:	16072
DRAWN BY:	CRS

PROJECT DESIGN PHASE


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DRAWING NAME

FOUNDATION DETAILS




DRAWING NUMBER

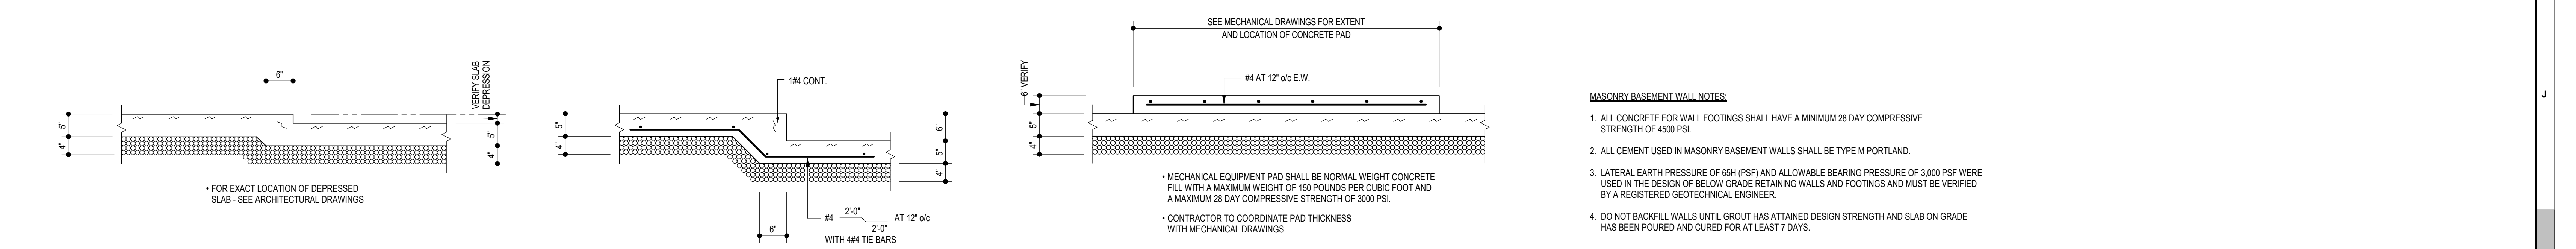S2.02



MASONRY BASEMENT WALL NOTES:

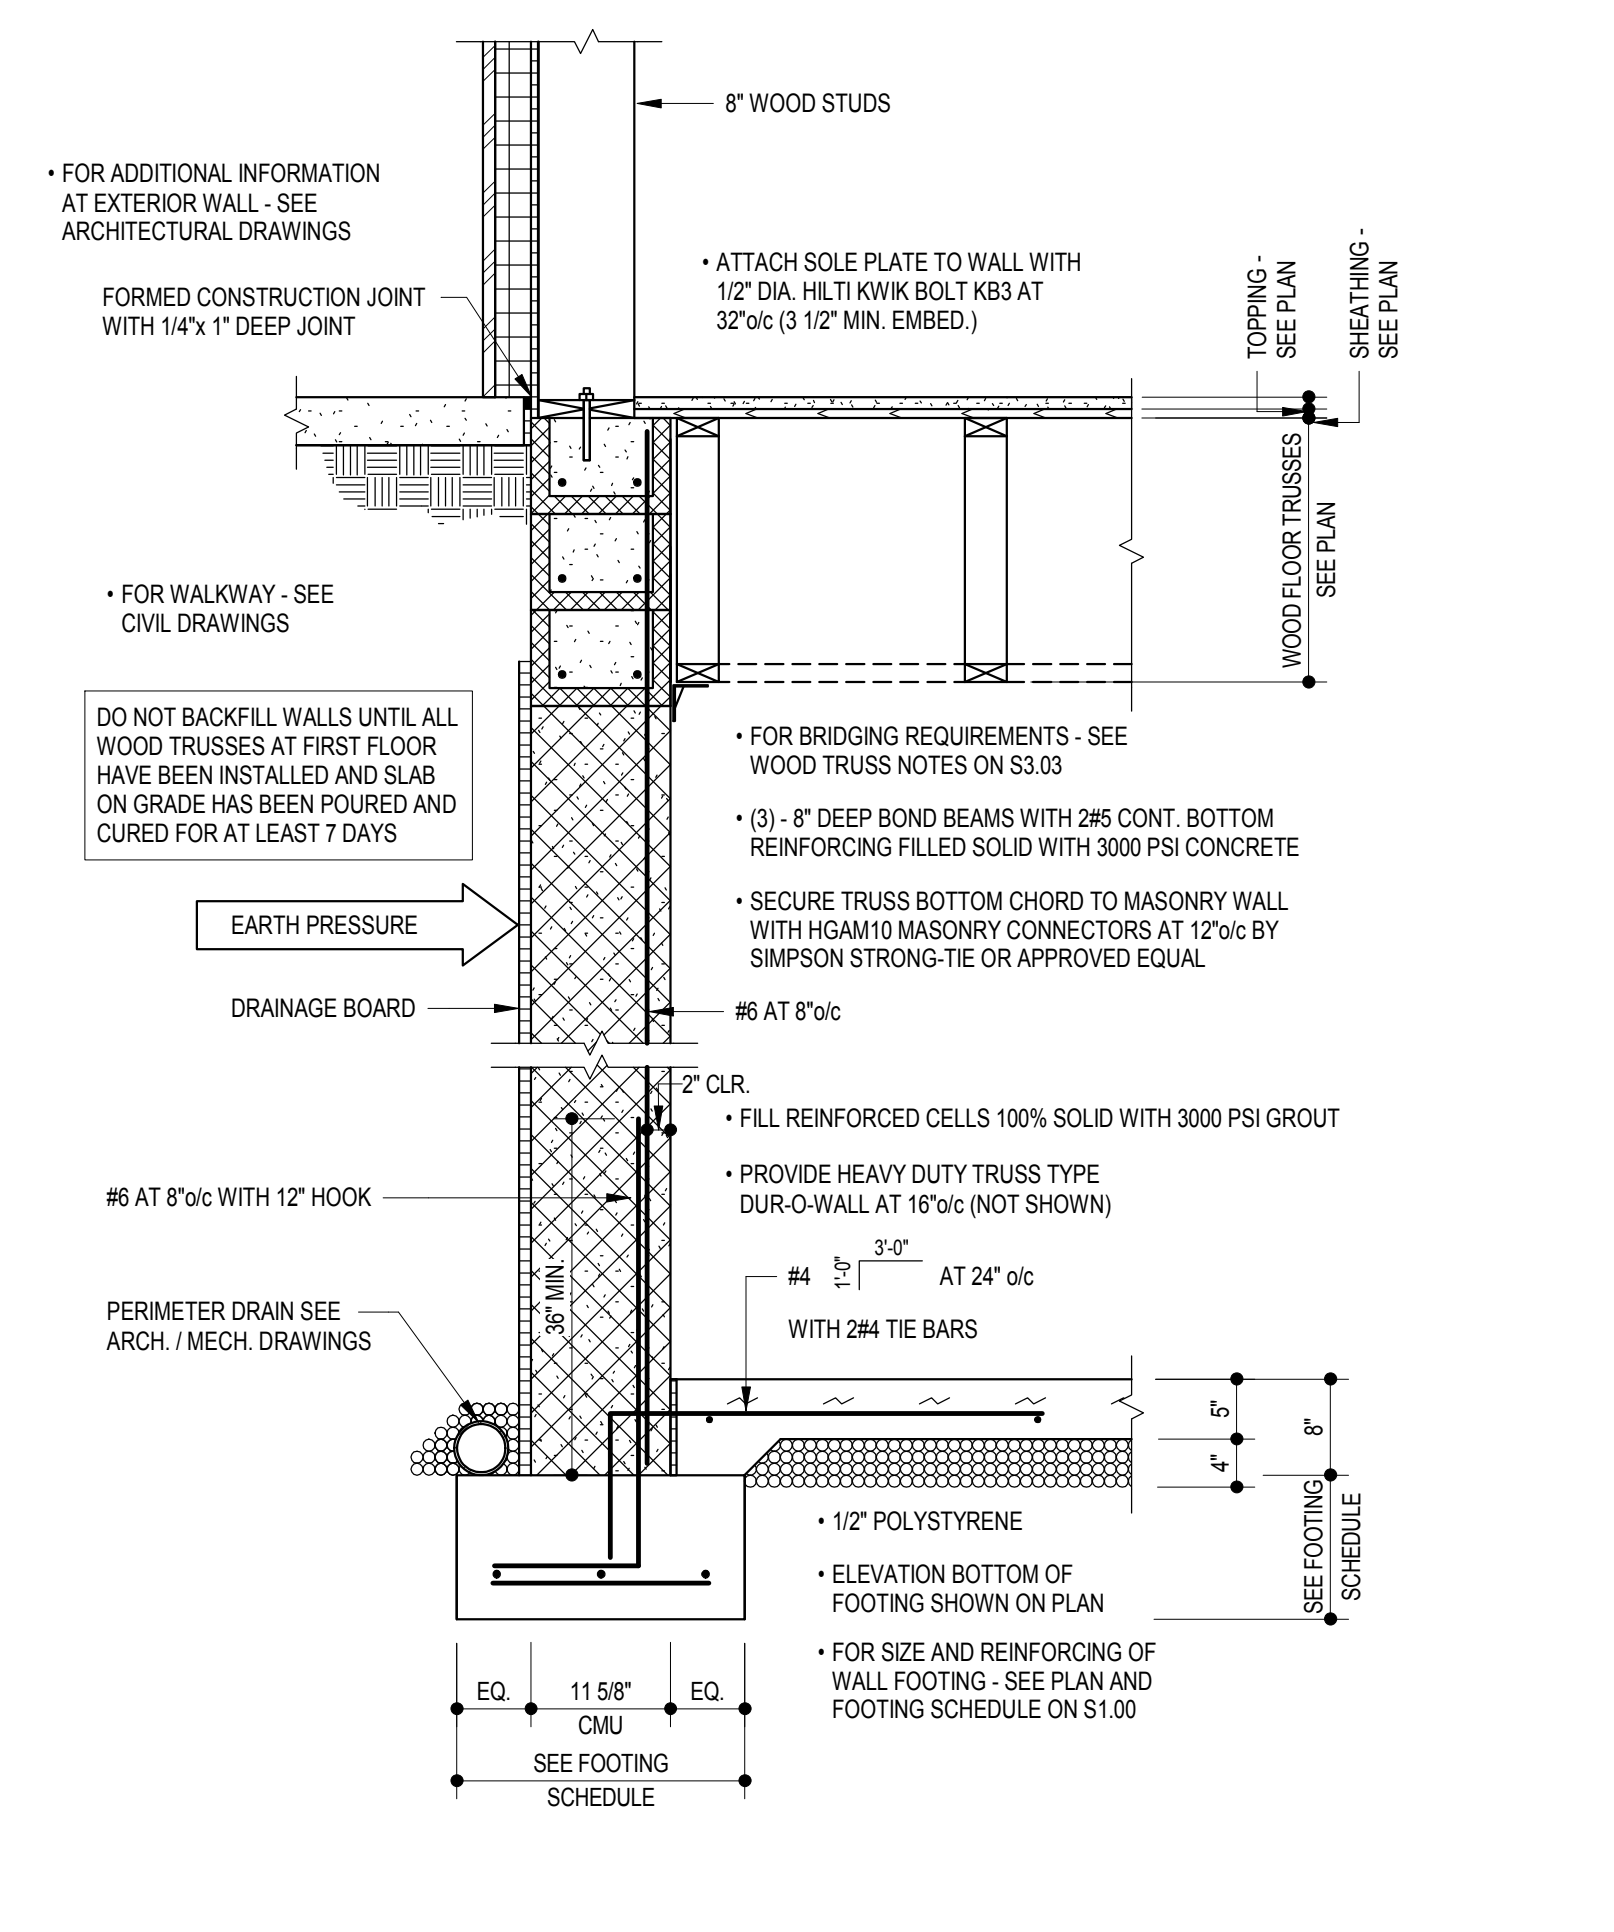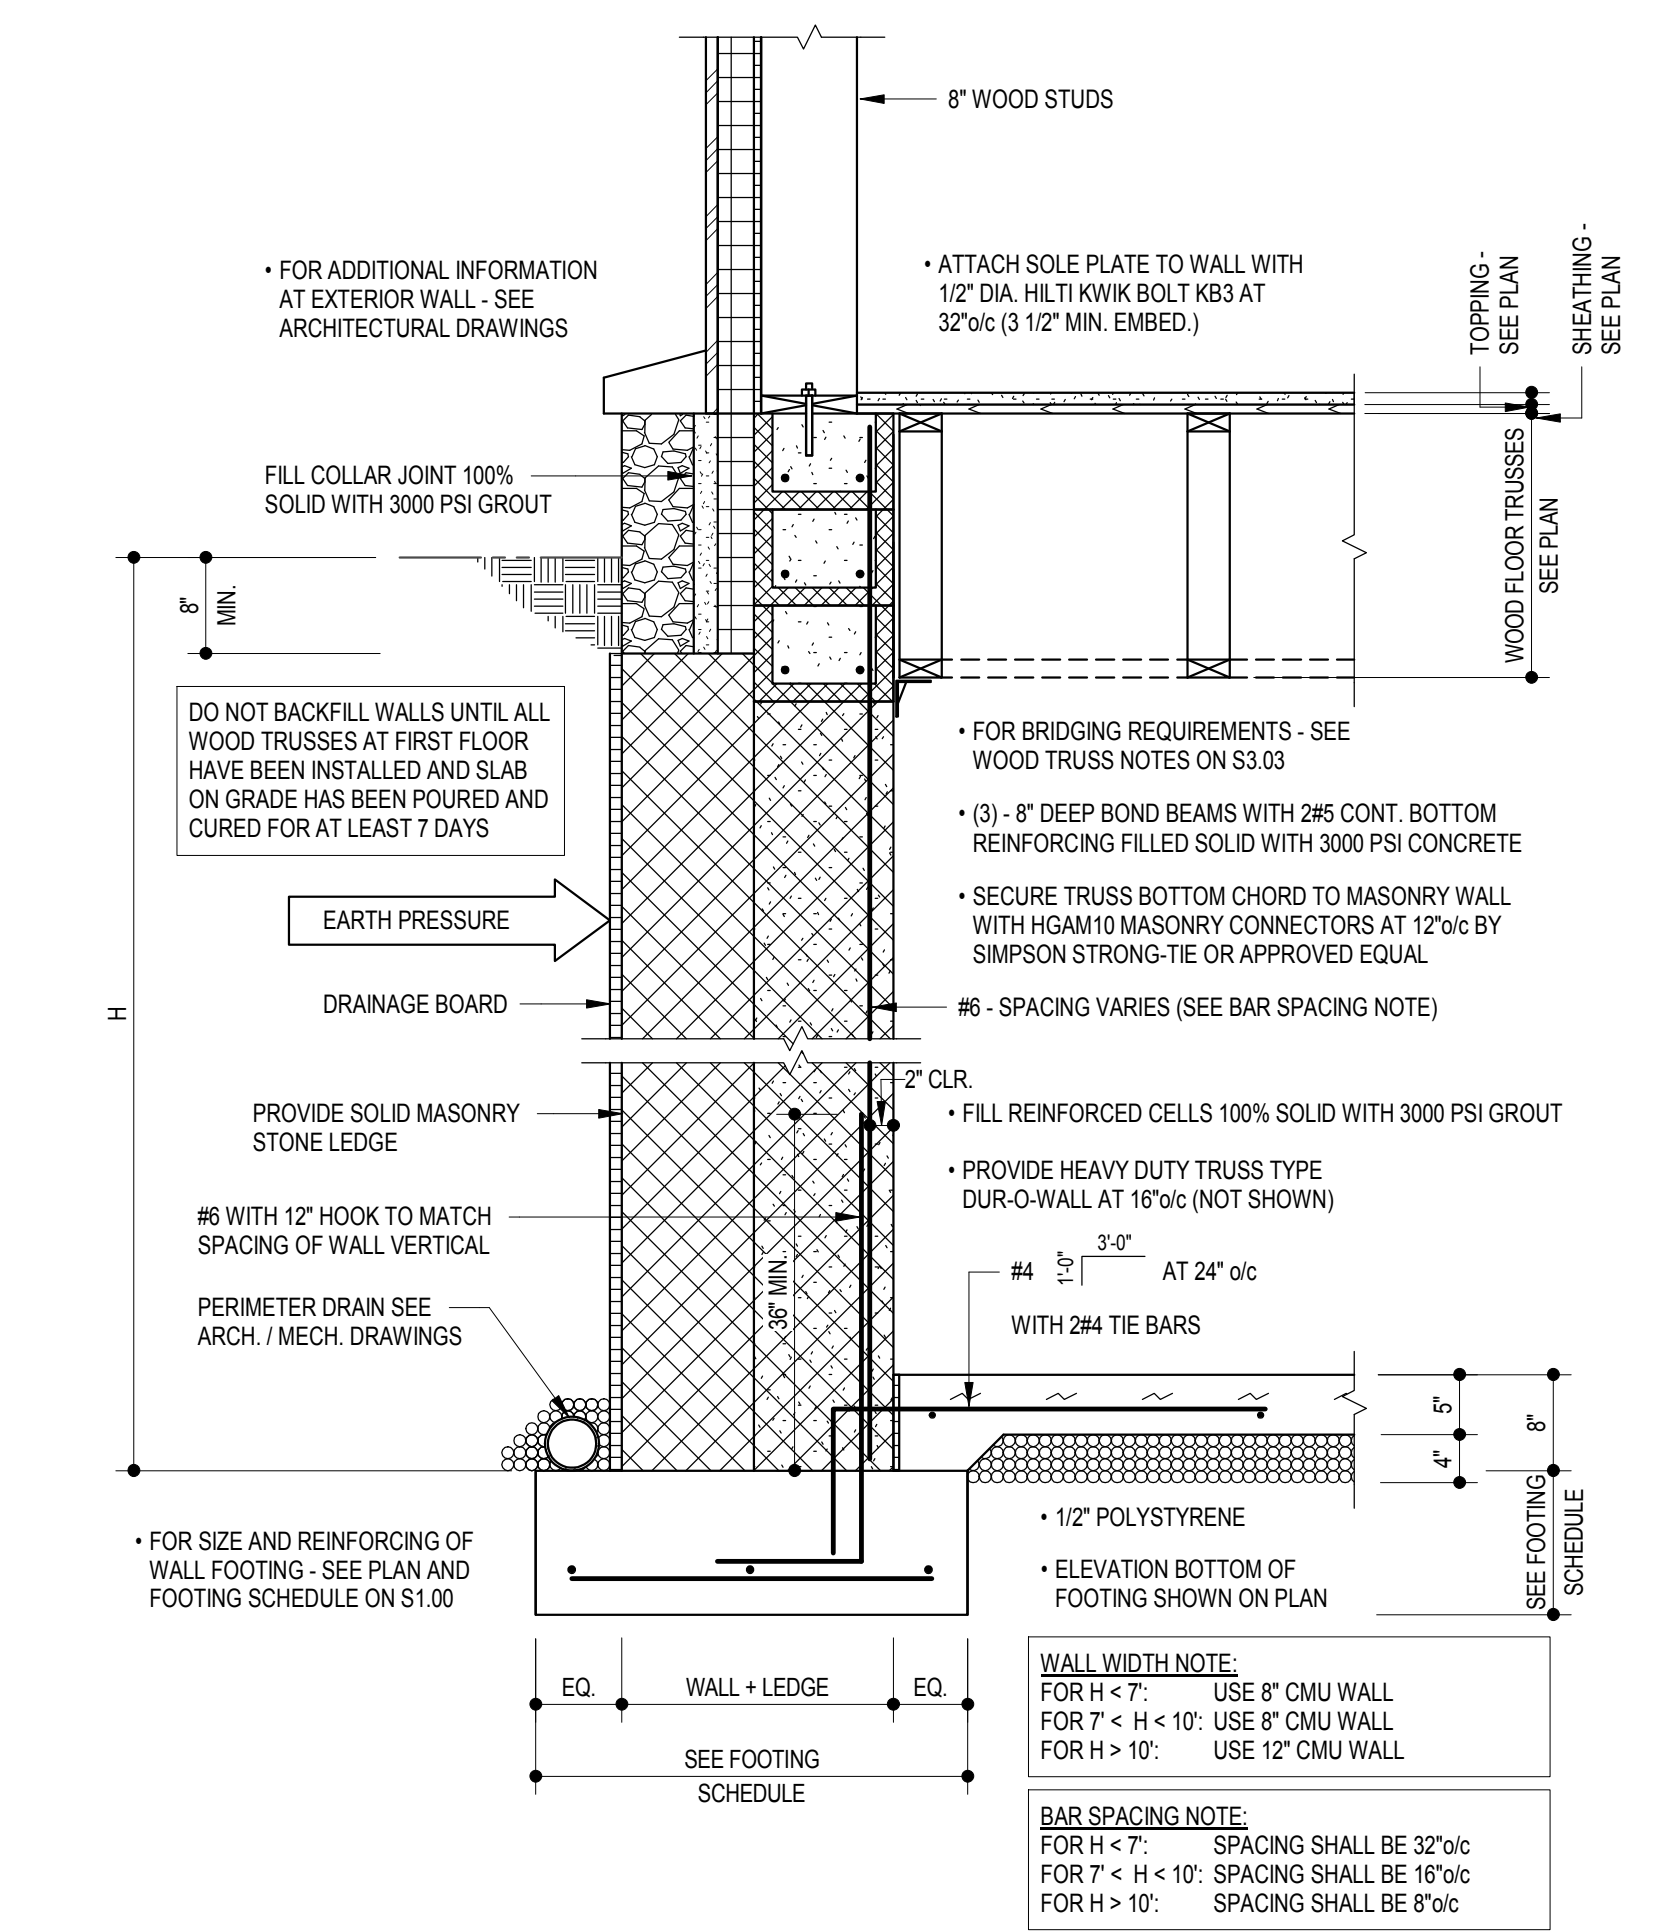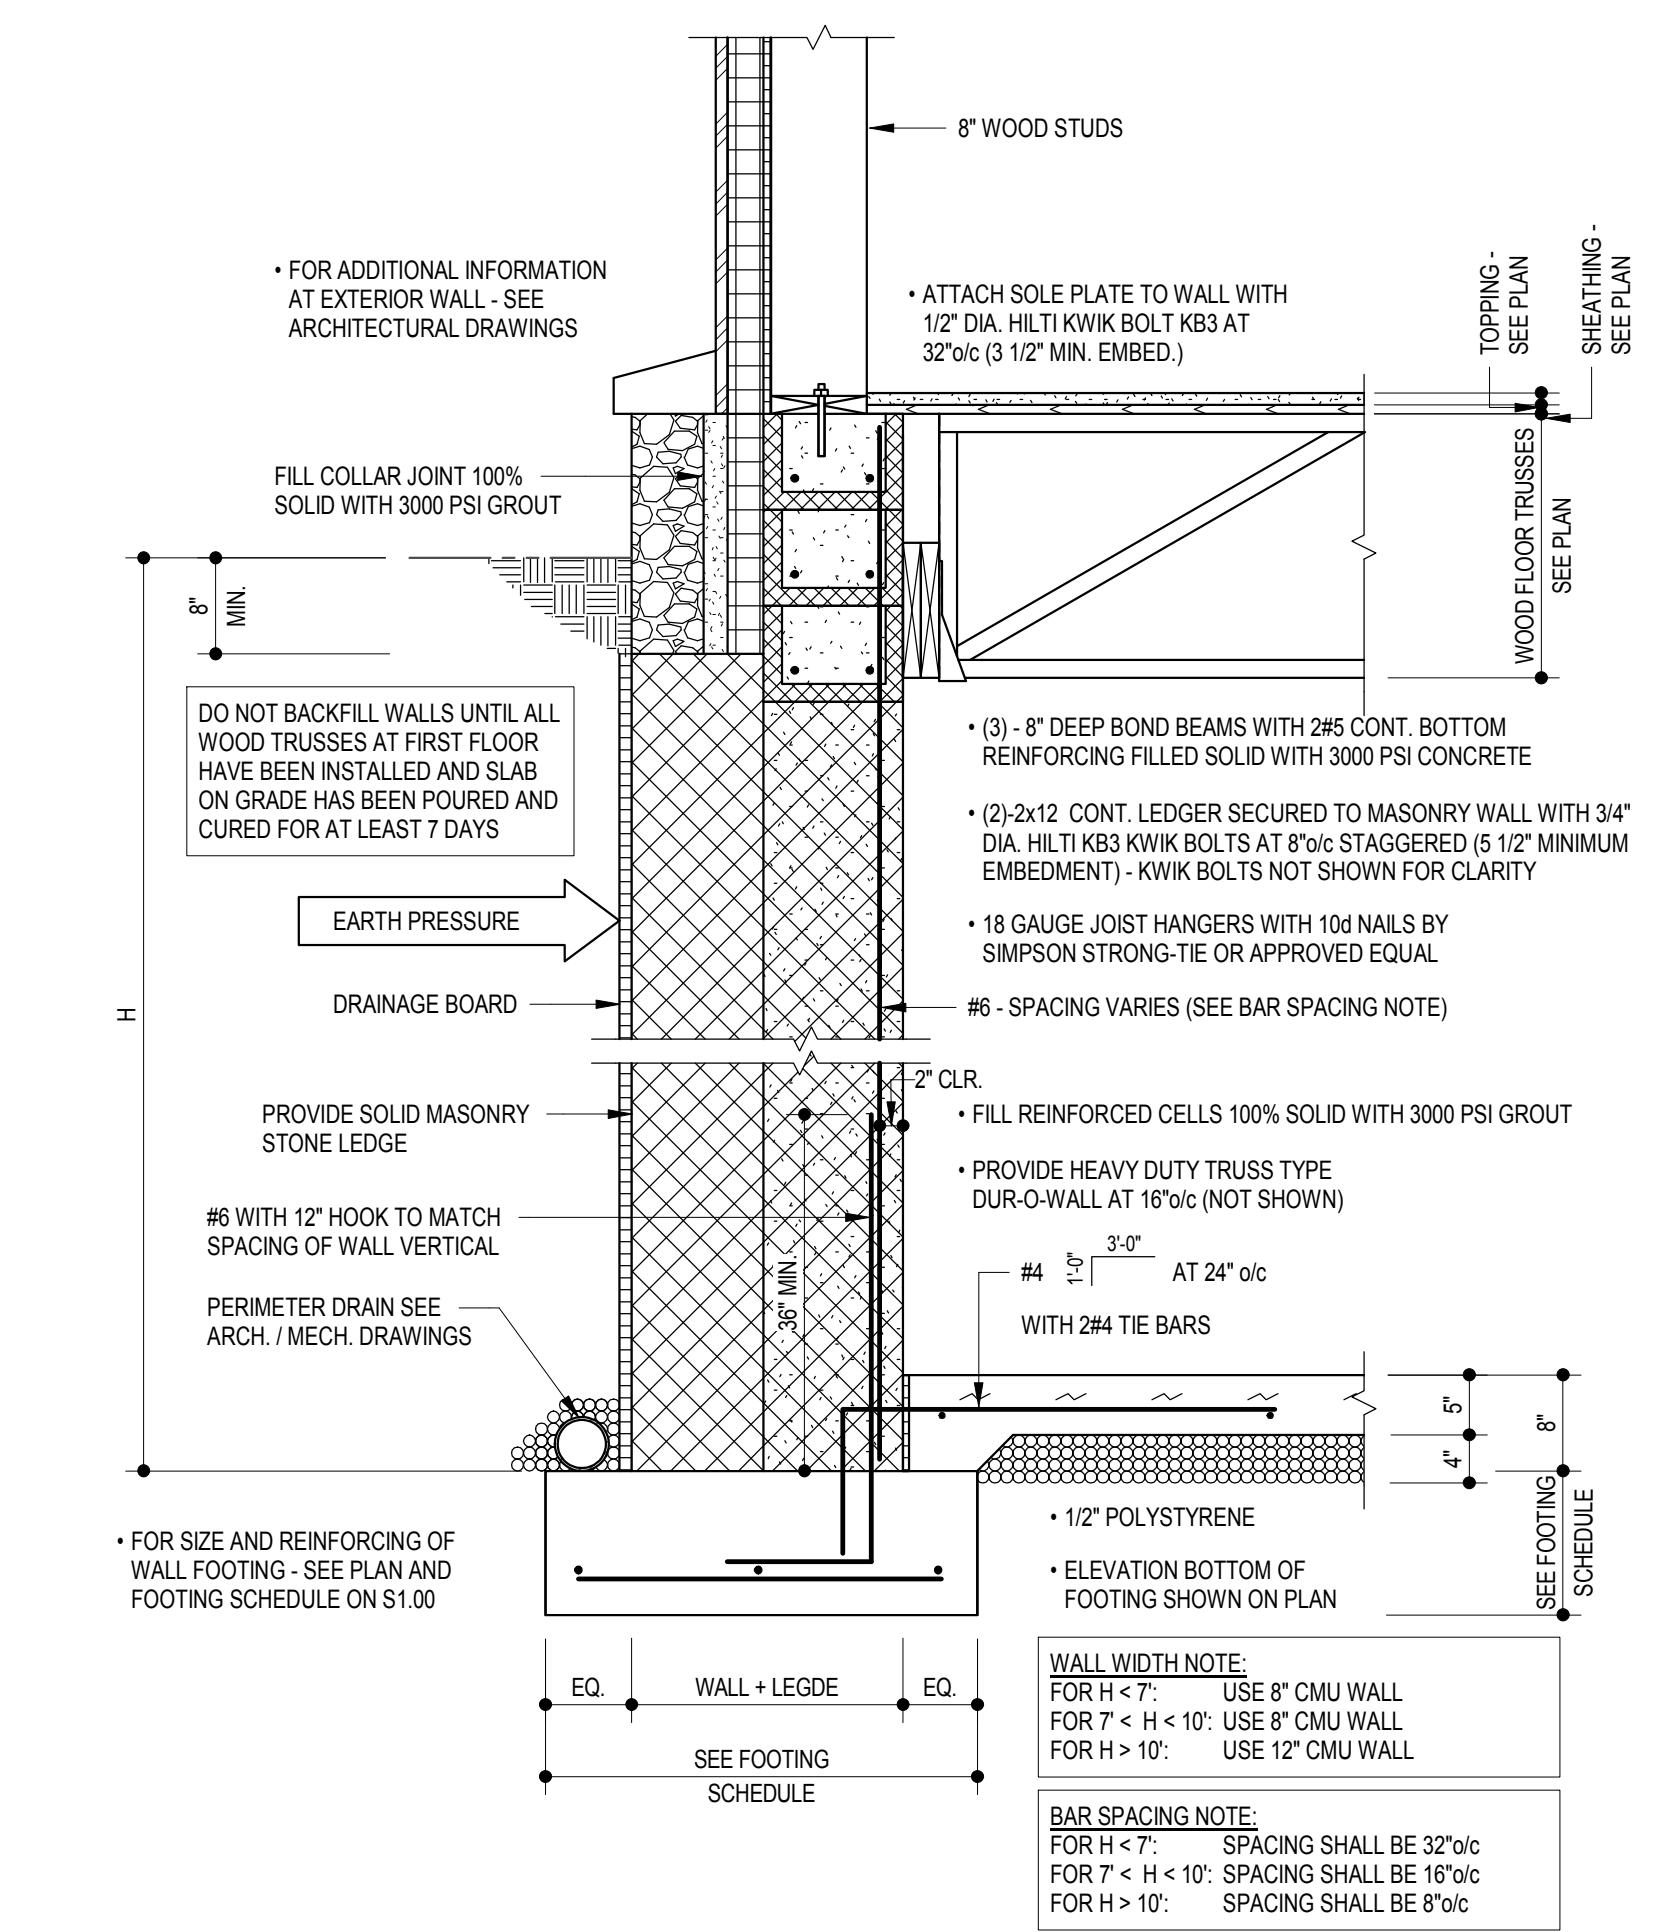1. ALL CONCRETE FOR WALL FOOTINGS SHALL HAVE A MINIMUM 28 DAY COMPRESSIVE STRENGTH OF 4500 PSI.
2. ALL CEMENT USED IN MASONRY BASEMENT WALLS SHALL BE TYPE M PORTLAND.
3. LATERAL EARTH PRESSURE OF 65H (PSF) AND ALLOWABLE BEARING PRESSURE OF 3,000 PSF WERE USED IN THE DESIGN OF BELOW GRADE RETAINING WALLS AND FOOTINGS AND MUST BE VERIFIED BY A REGISTERED GEOTECHNICAL ENGINEER.
4. DO NOT BACKFILL WALLS UNTIL GROUT HAS ATTAINED DESIGN STRENGTH AND SLAB ON GRADE HAS BEEN POURED AND CURED FOR AT LEAST 7 DAYS.




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REVISIONS		
REV. #	DESCRIPTION	DATE
1	Revision 1	Date 1

KEY PLAN



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ISSUE DATE:	04/28/17
SCALE:	3/4" = 1'-0"
JOB NO.:	16072
DRAWN BY:	CRS

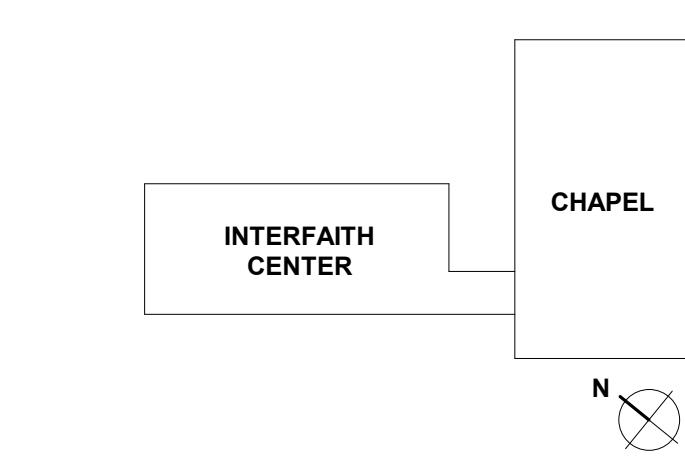PROJECT DESIGN PHASE


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DRAWING NAME

FOUNDATION DETAILS

DRAWING NUMBER

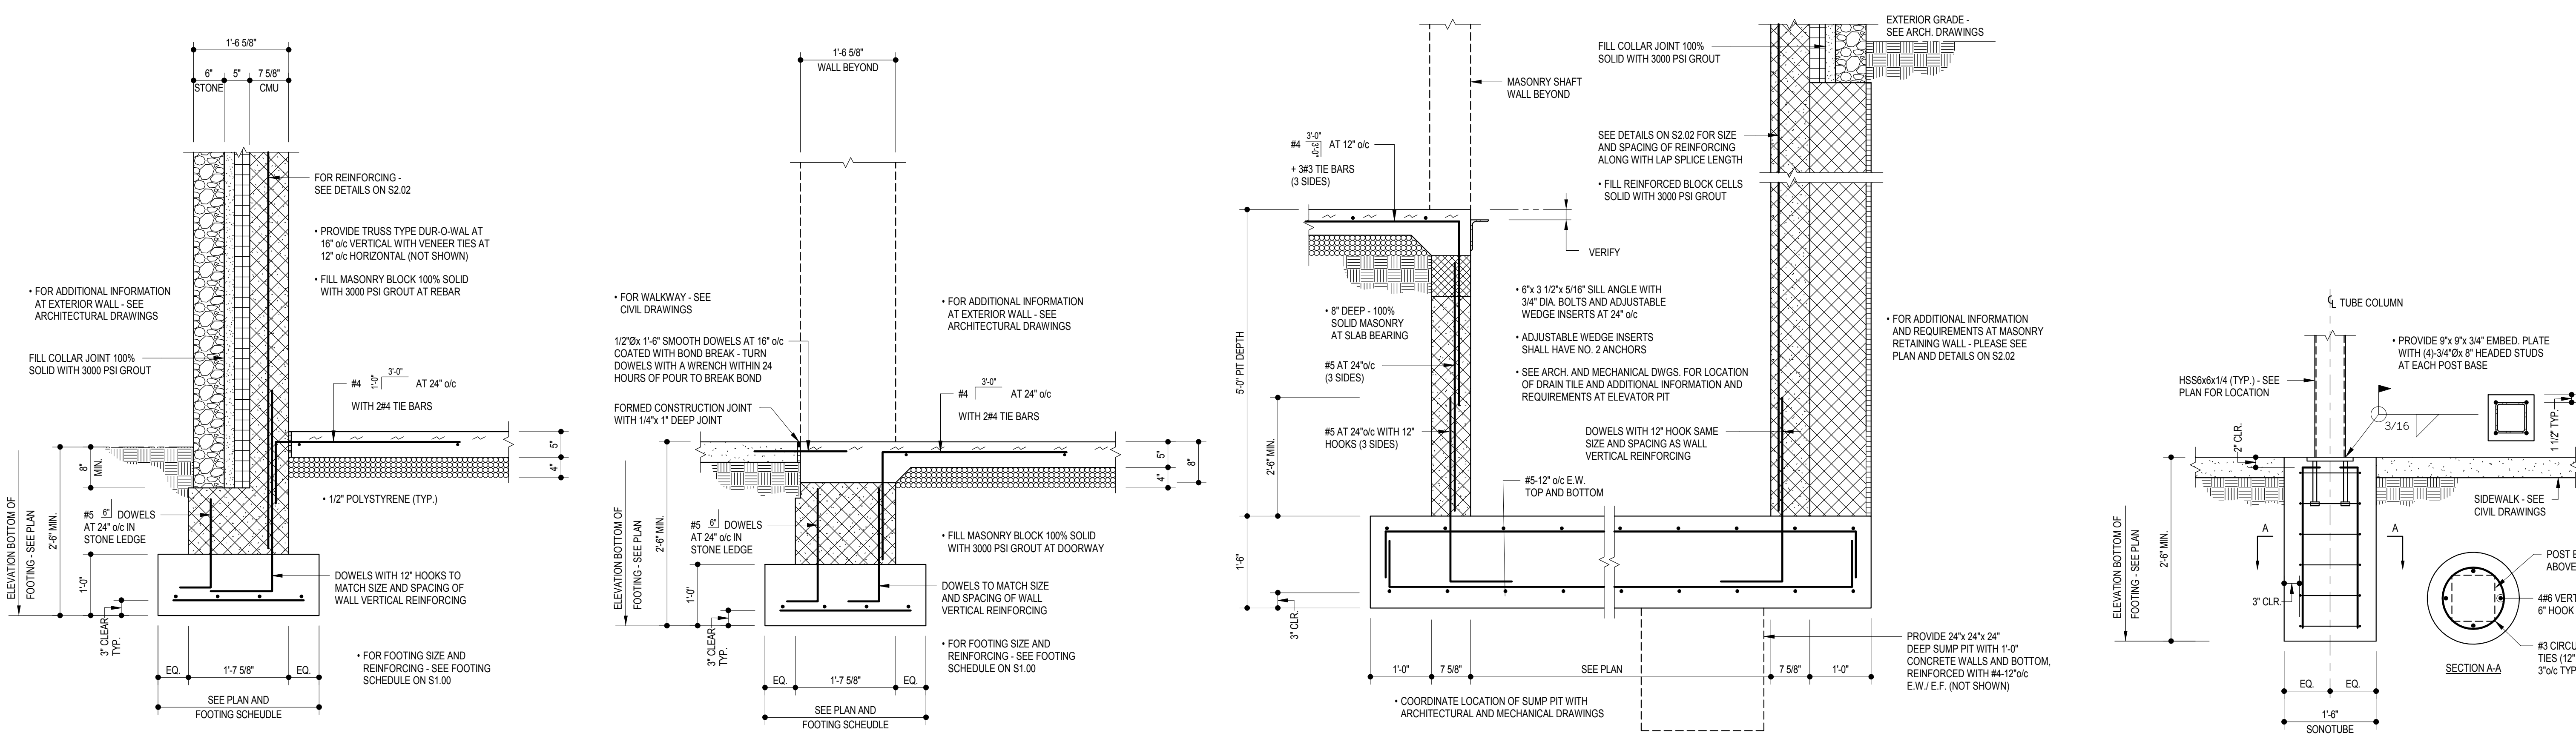S2.03



1 EXTERIOR 8" MASONRY WALL AT FOUNDATION 3/4" = 1'-0"

2 EXTERIOR 8" MASONRY WALL AT FOUNDATION AT ENTRANCE / WINDOW 3/4" = 1'-0"

3 ELEVATOR PIT 3/4" = 1'-0"

4 SONOTUBE AT PERGOLA COLUMN 3/4" = 1'-0"

STAPLE EDGE

STAPLE EDGE

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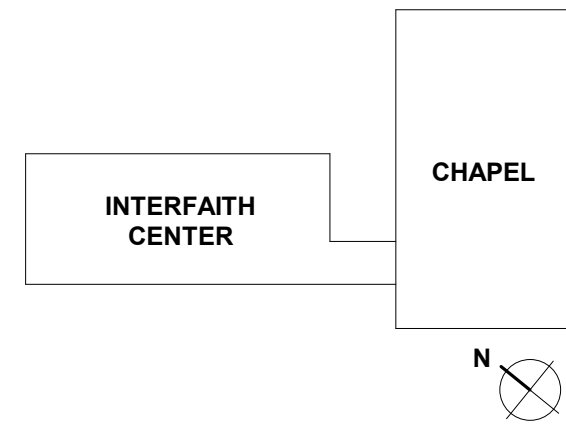
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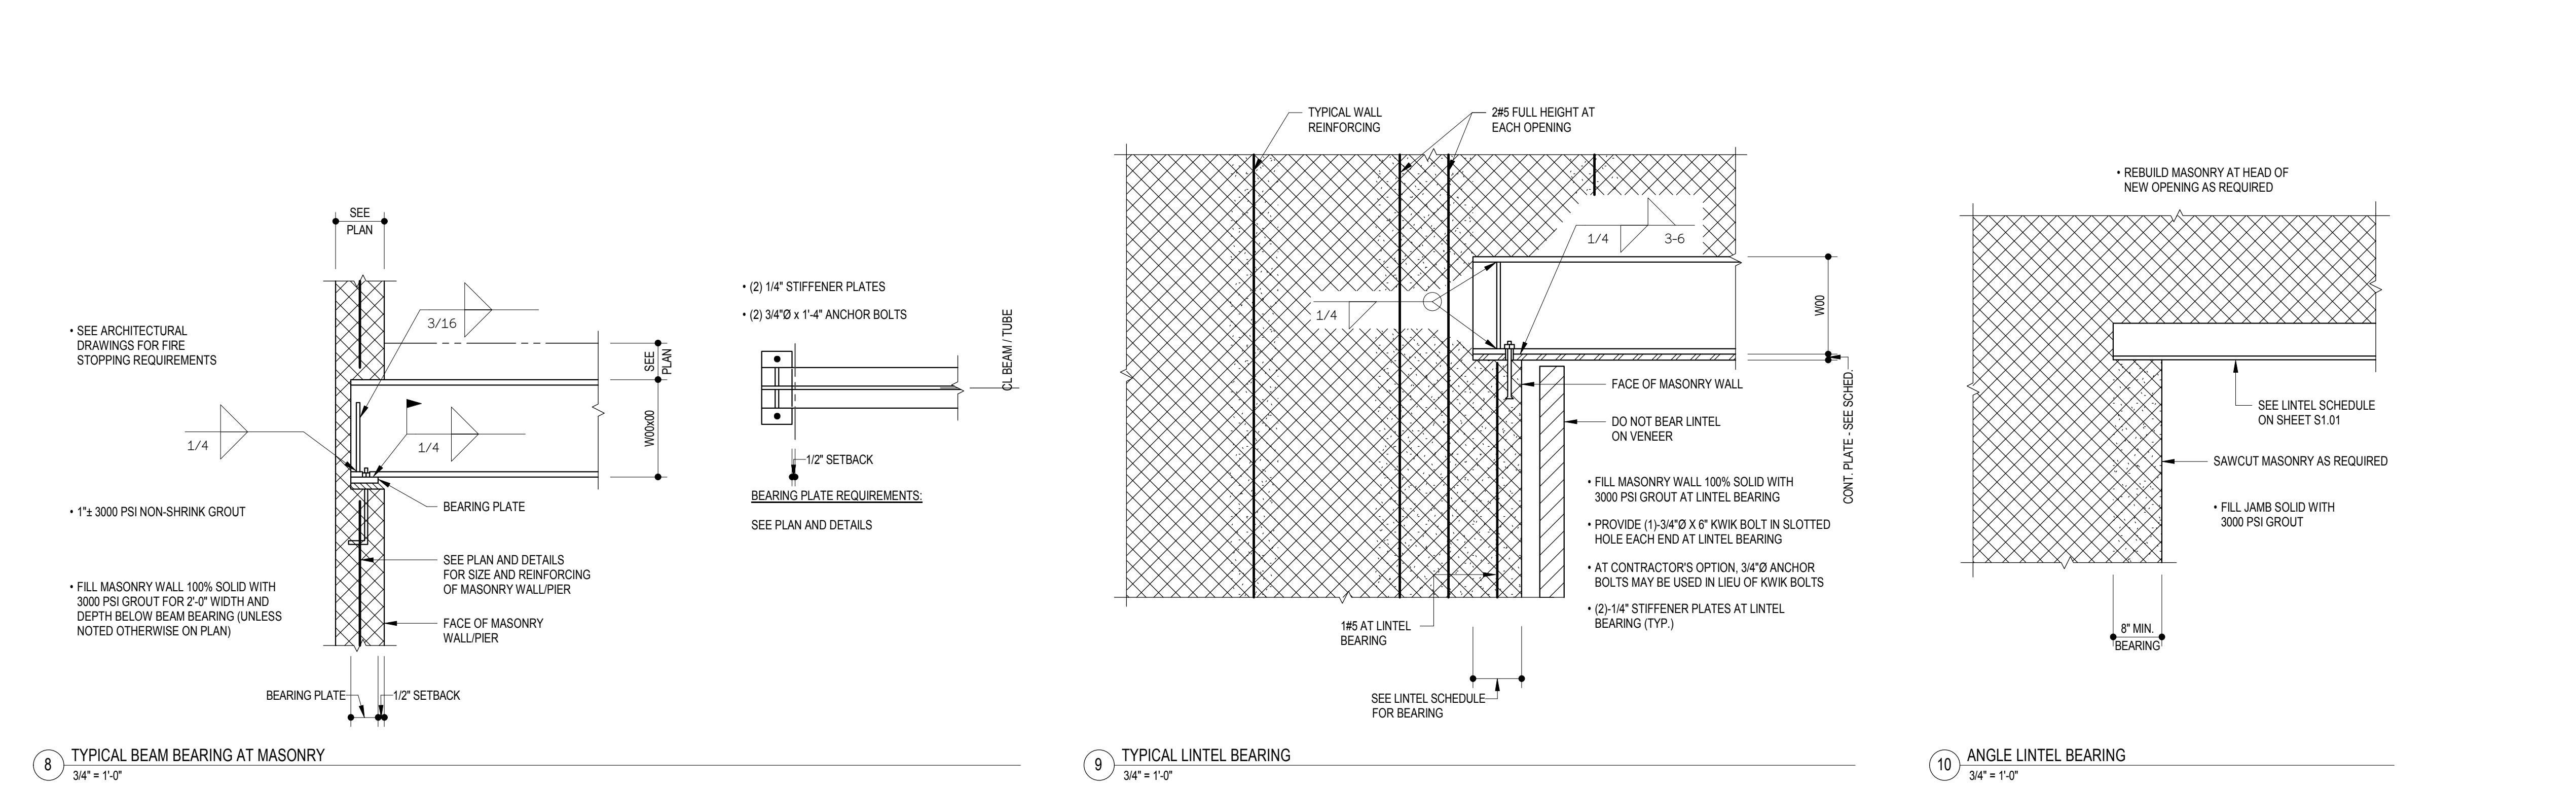
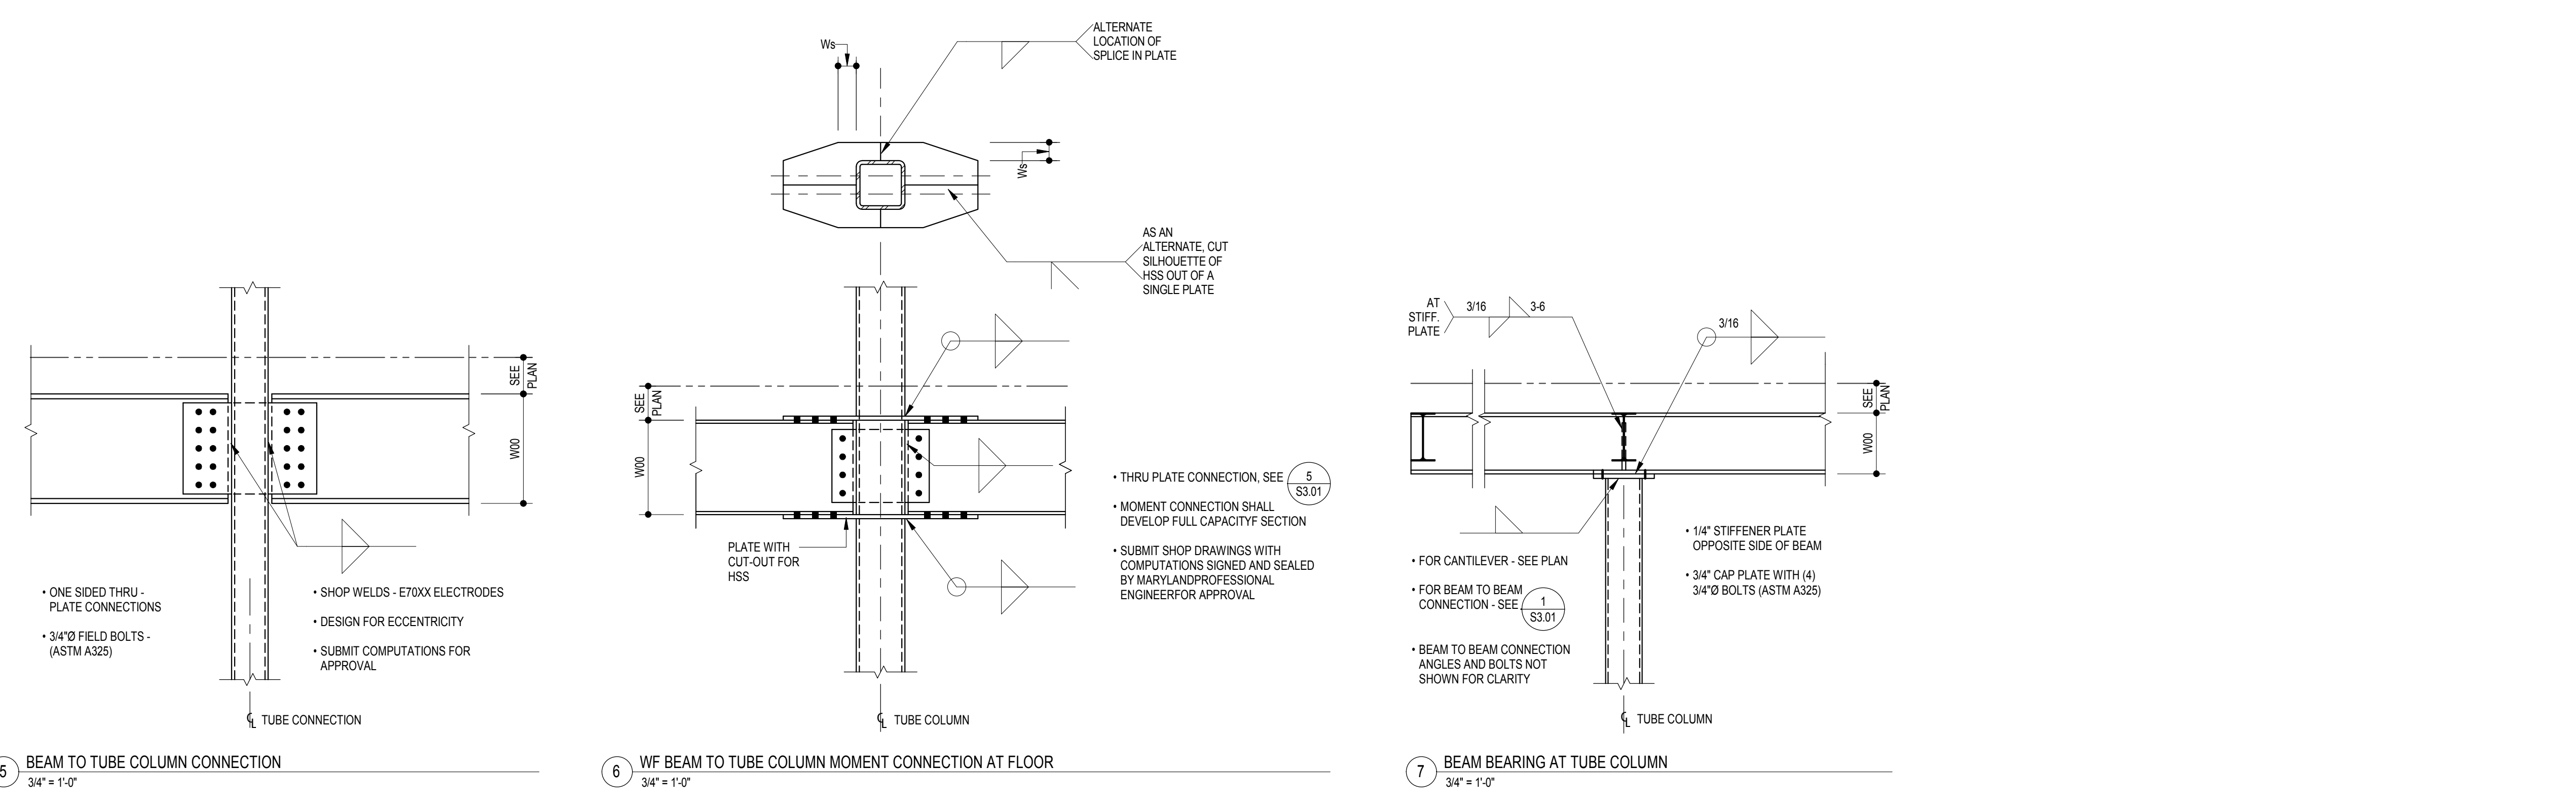
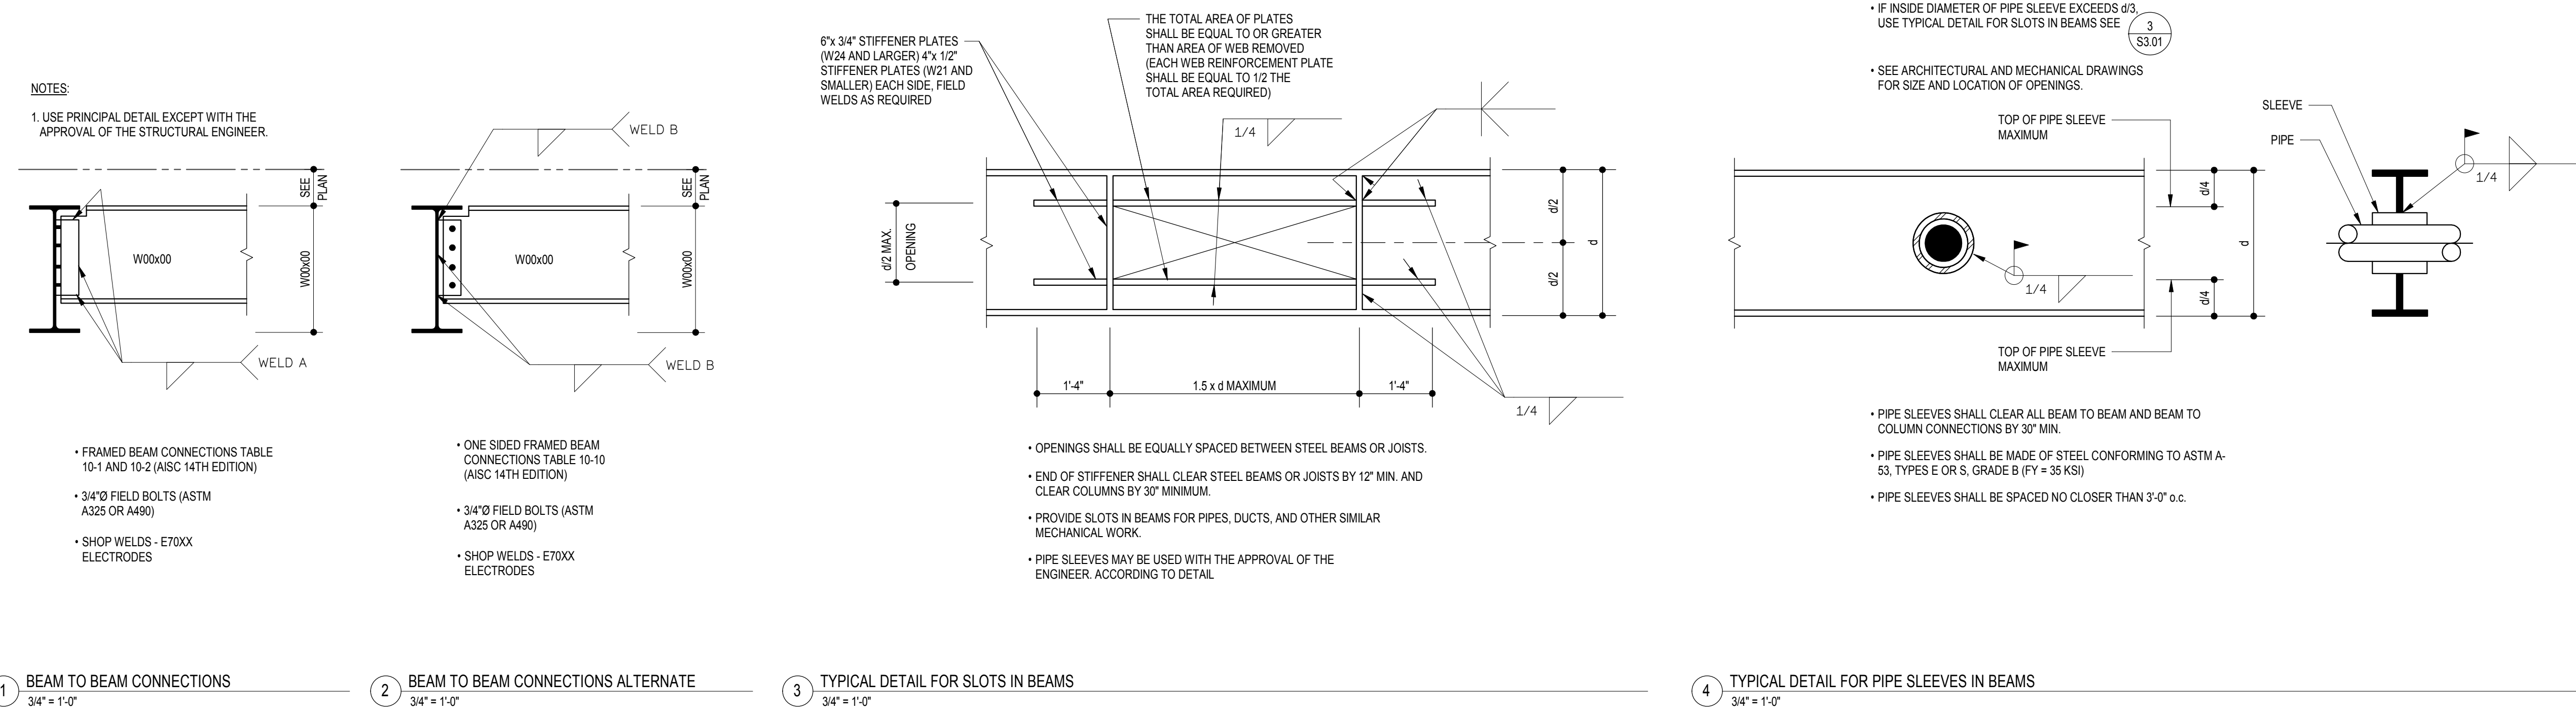
PROJECT DESIGN PHASE

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TYPICAL STEEL DETAILS

DRAWING NUMBER	
S3.01	



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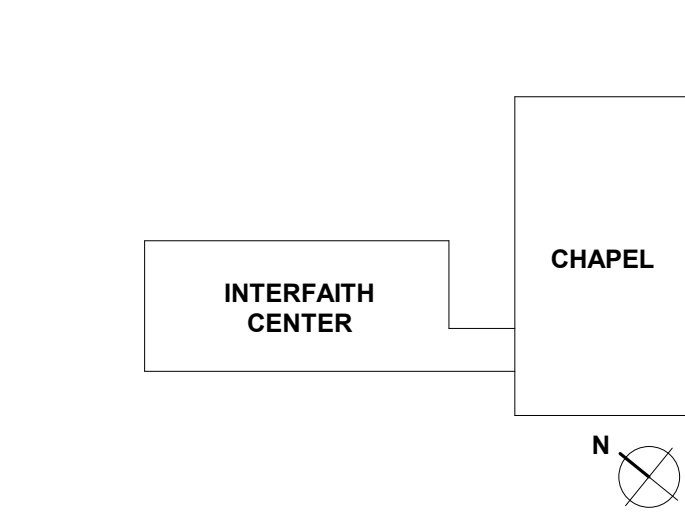
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Table with 3 columns: REV. #, DESCRIPTION, DATE. Multiple empty rows for revisions.

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Table with 2 columns: ISSUE DATE, SCALE, JOB NO., DRAWN BY. Values: 04/28/17, As indicated, 16072, CRS.

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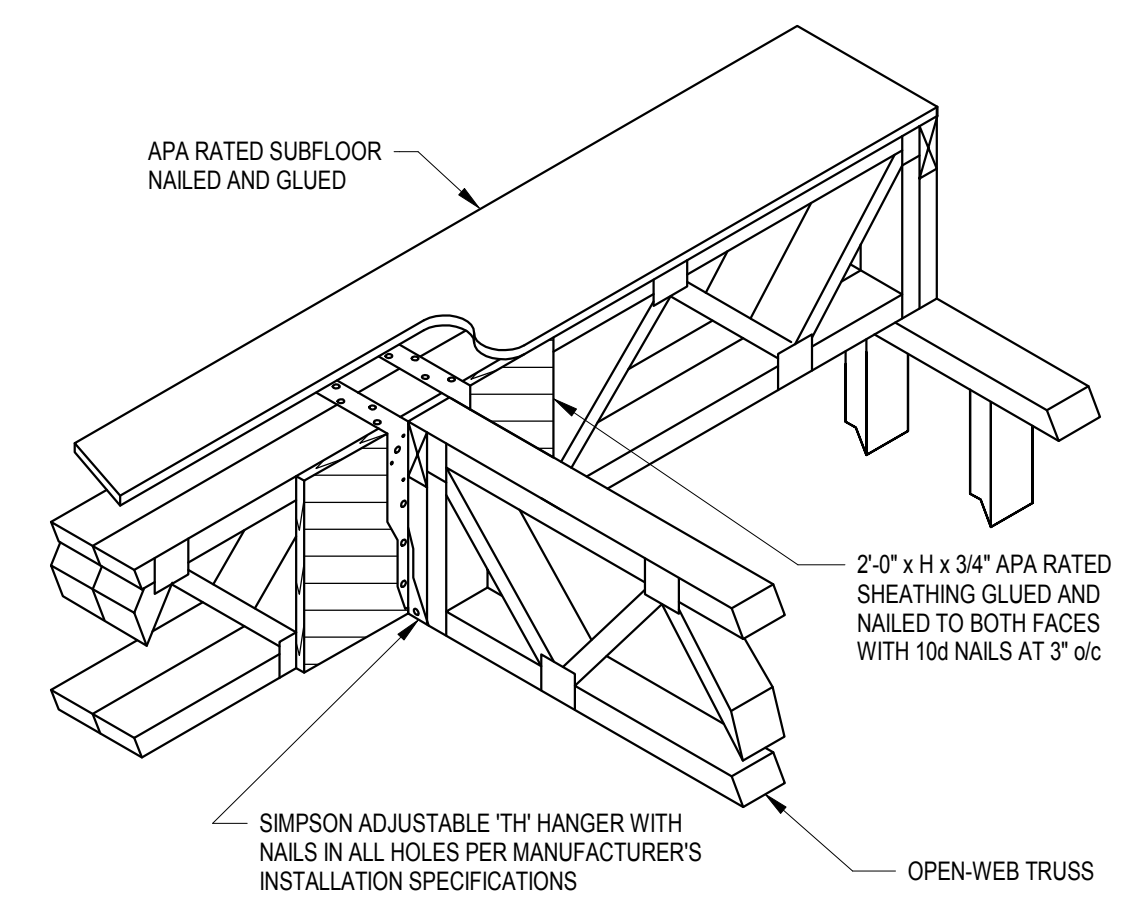
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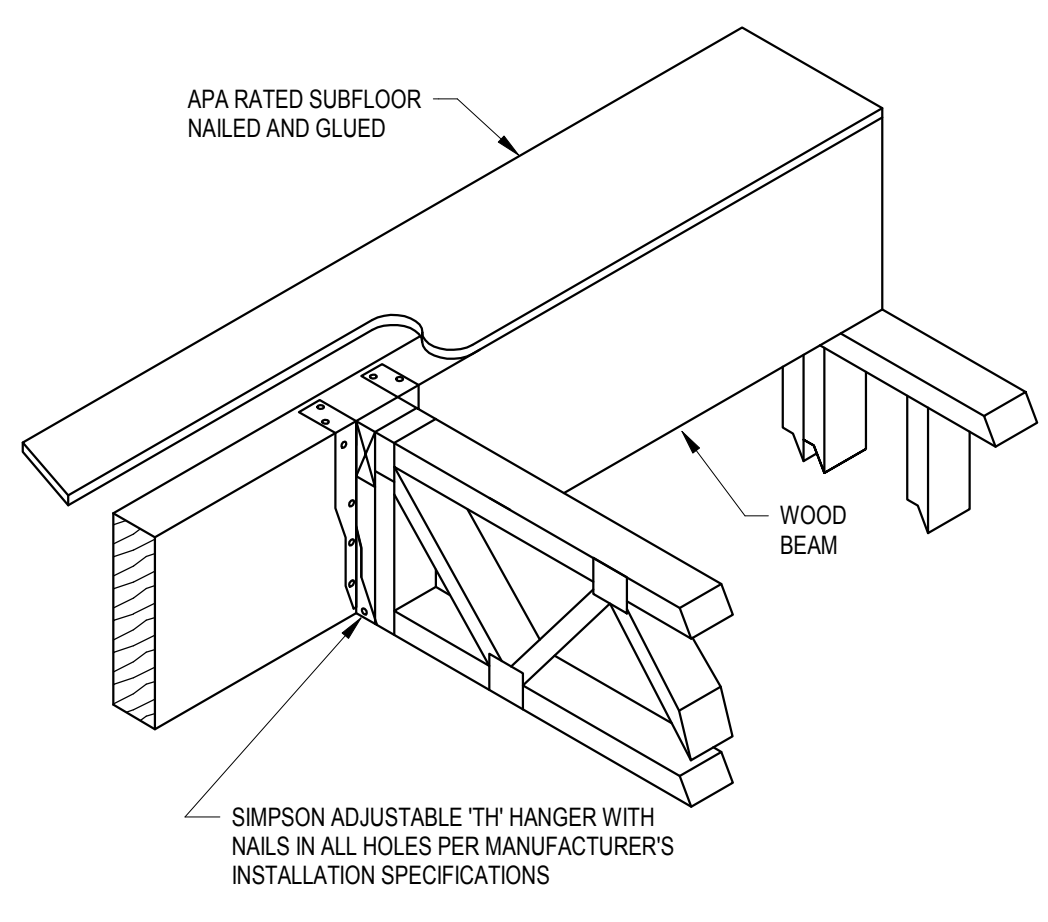
TYPICAL WOOD FRAMING DETAILS

DRAWING NUMBER

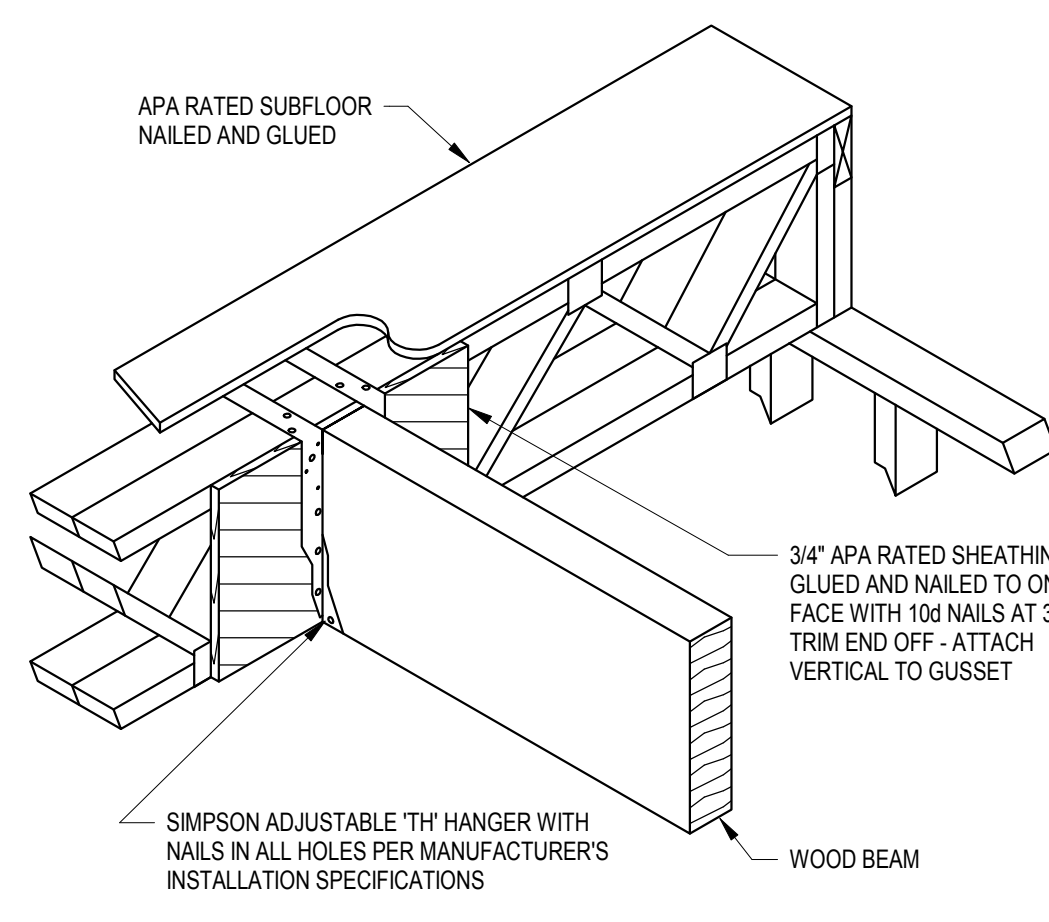
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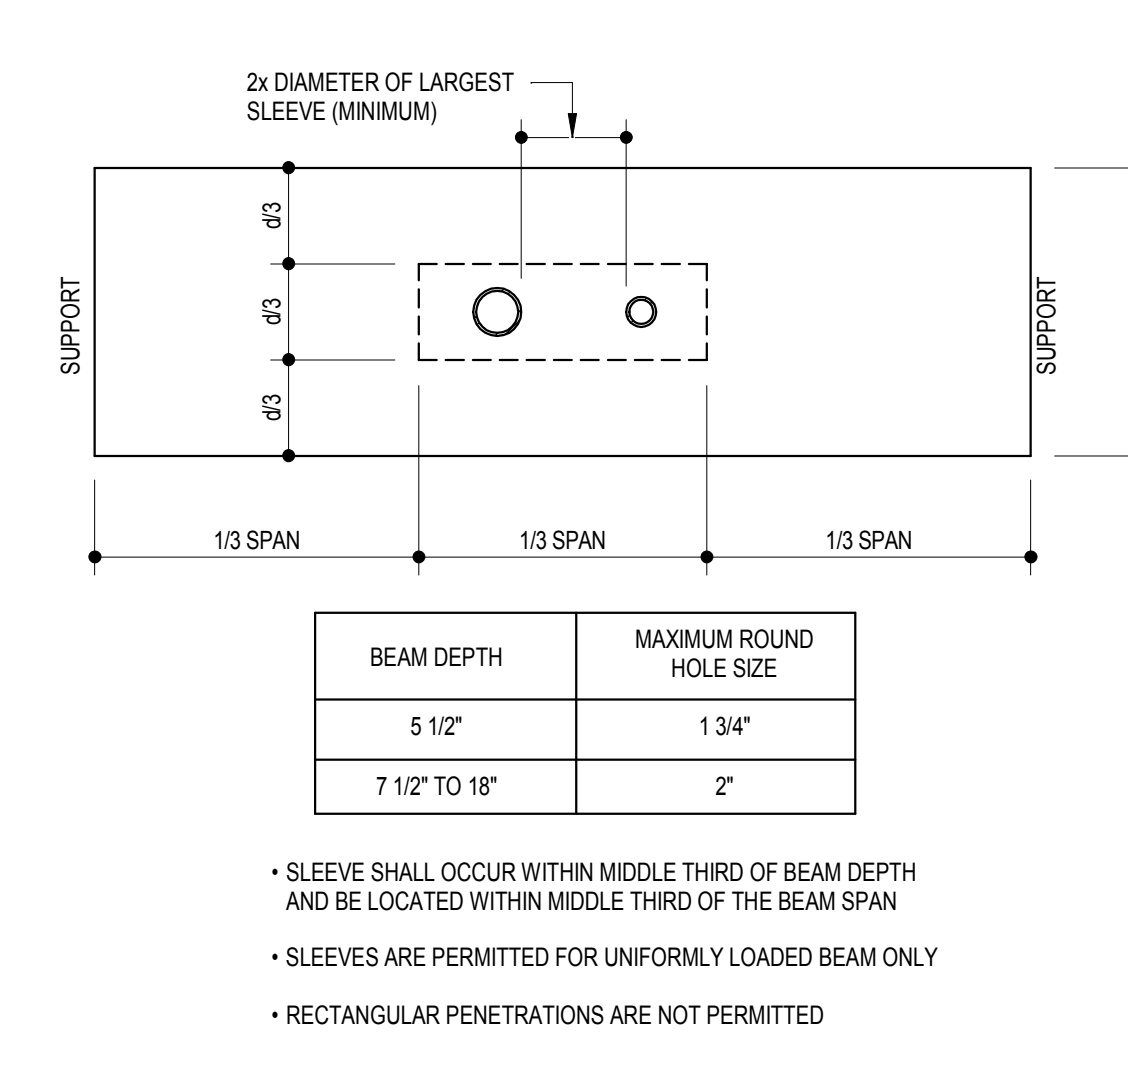
1 TYPICAL WOOD TRUSS TO WOOD TRUSS CONNECTION
3/4" x 1'-0"




2 TYPICAL WOOD TRUSS TO WOOD BEAM CONNECTION
3/4" x 1'-0"




3 TYPICAL WOOD BEAM TO WOOD TRUSS CONNECTION
3/4" x 1'-0"



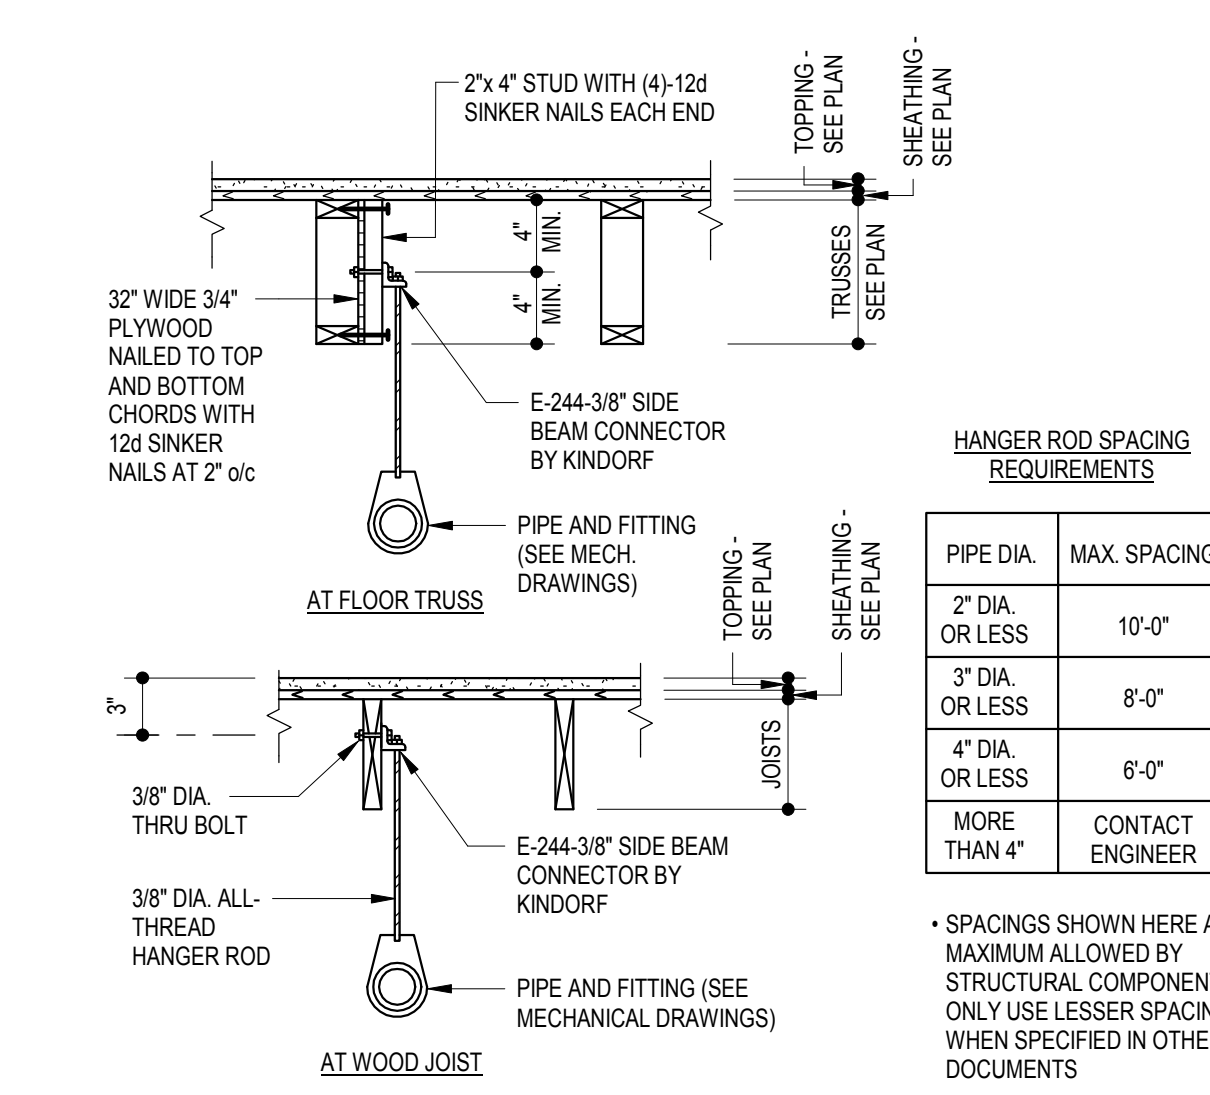
4 PIPE SLEEVES IN WOOD BEAMS
3/4" x 1'-0"




5 PIPE HANGER DETAILS
3/4" x 1'-0"

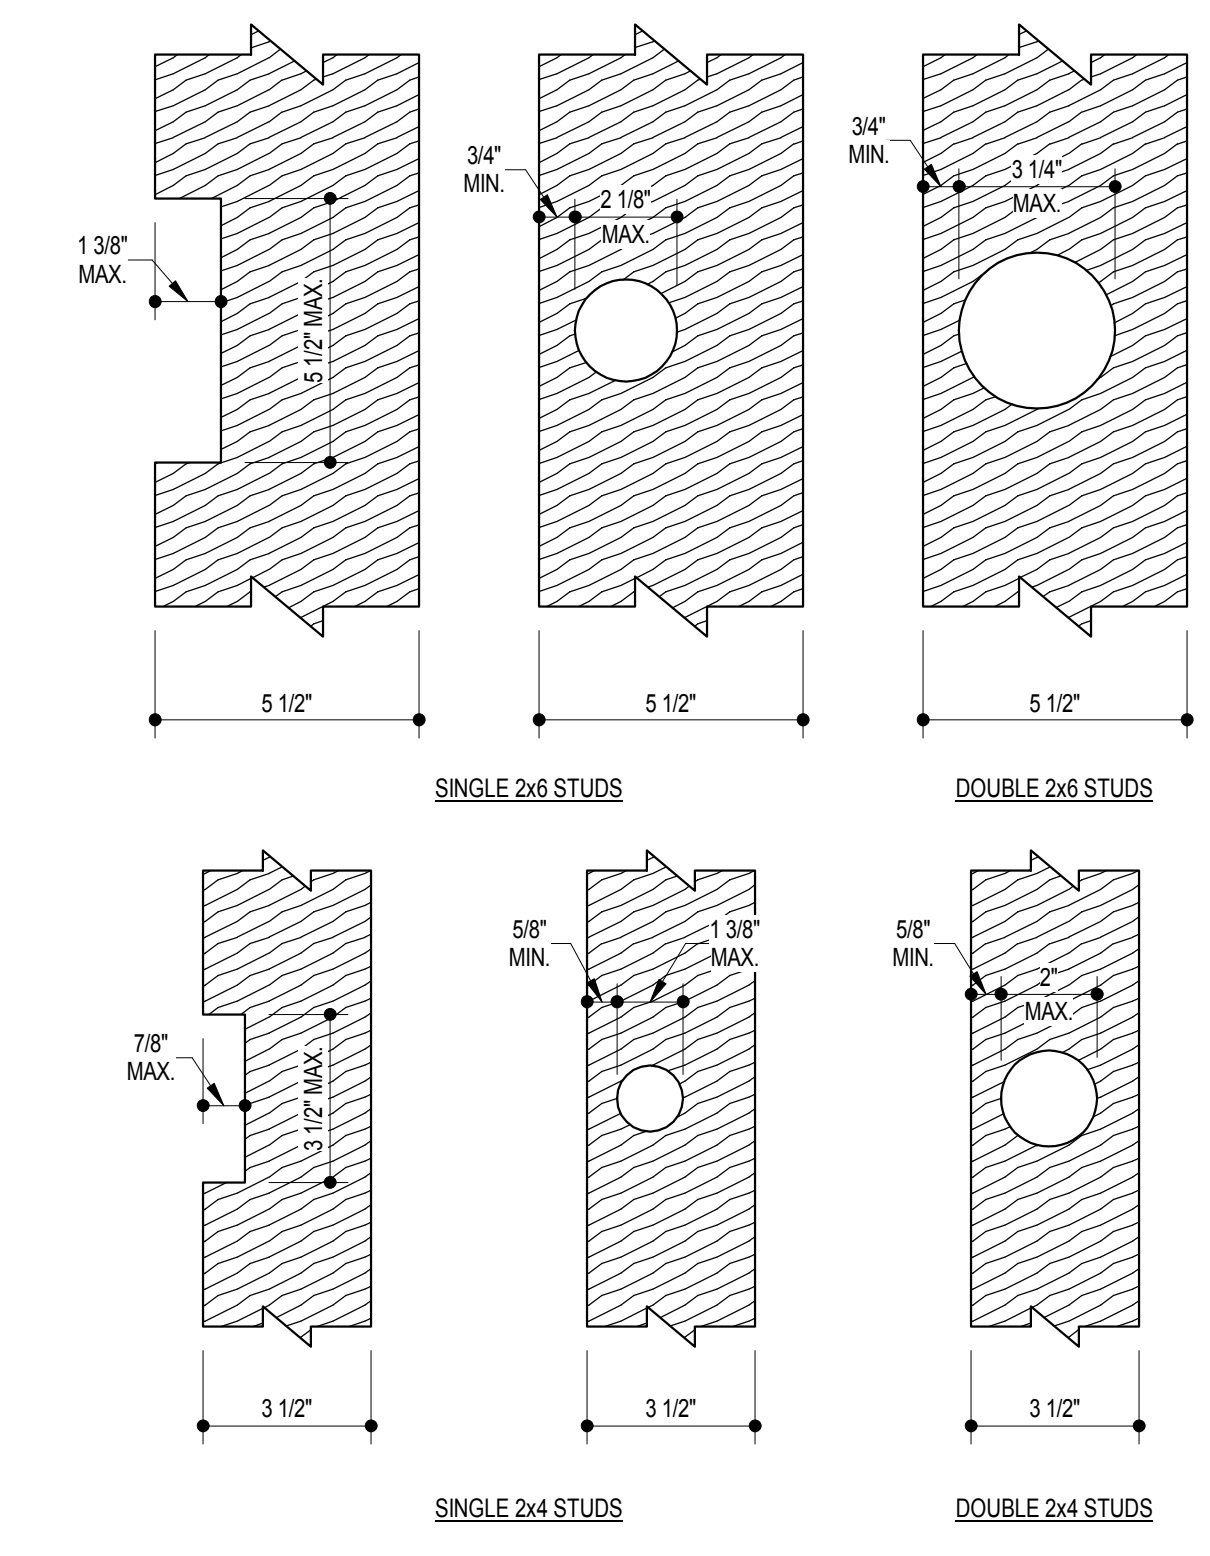

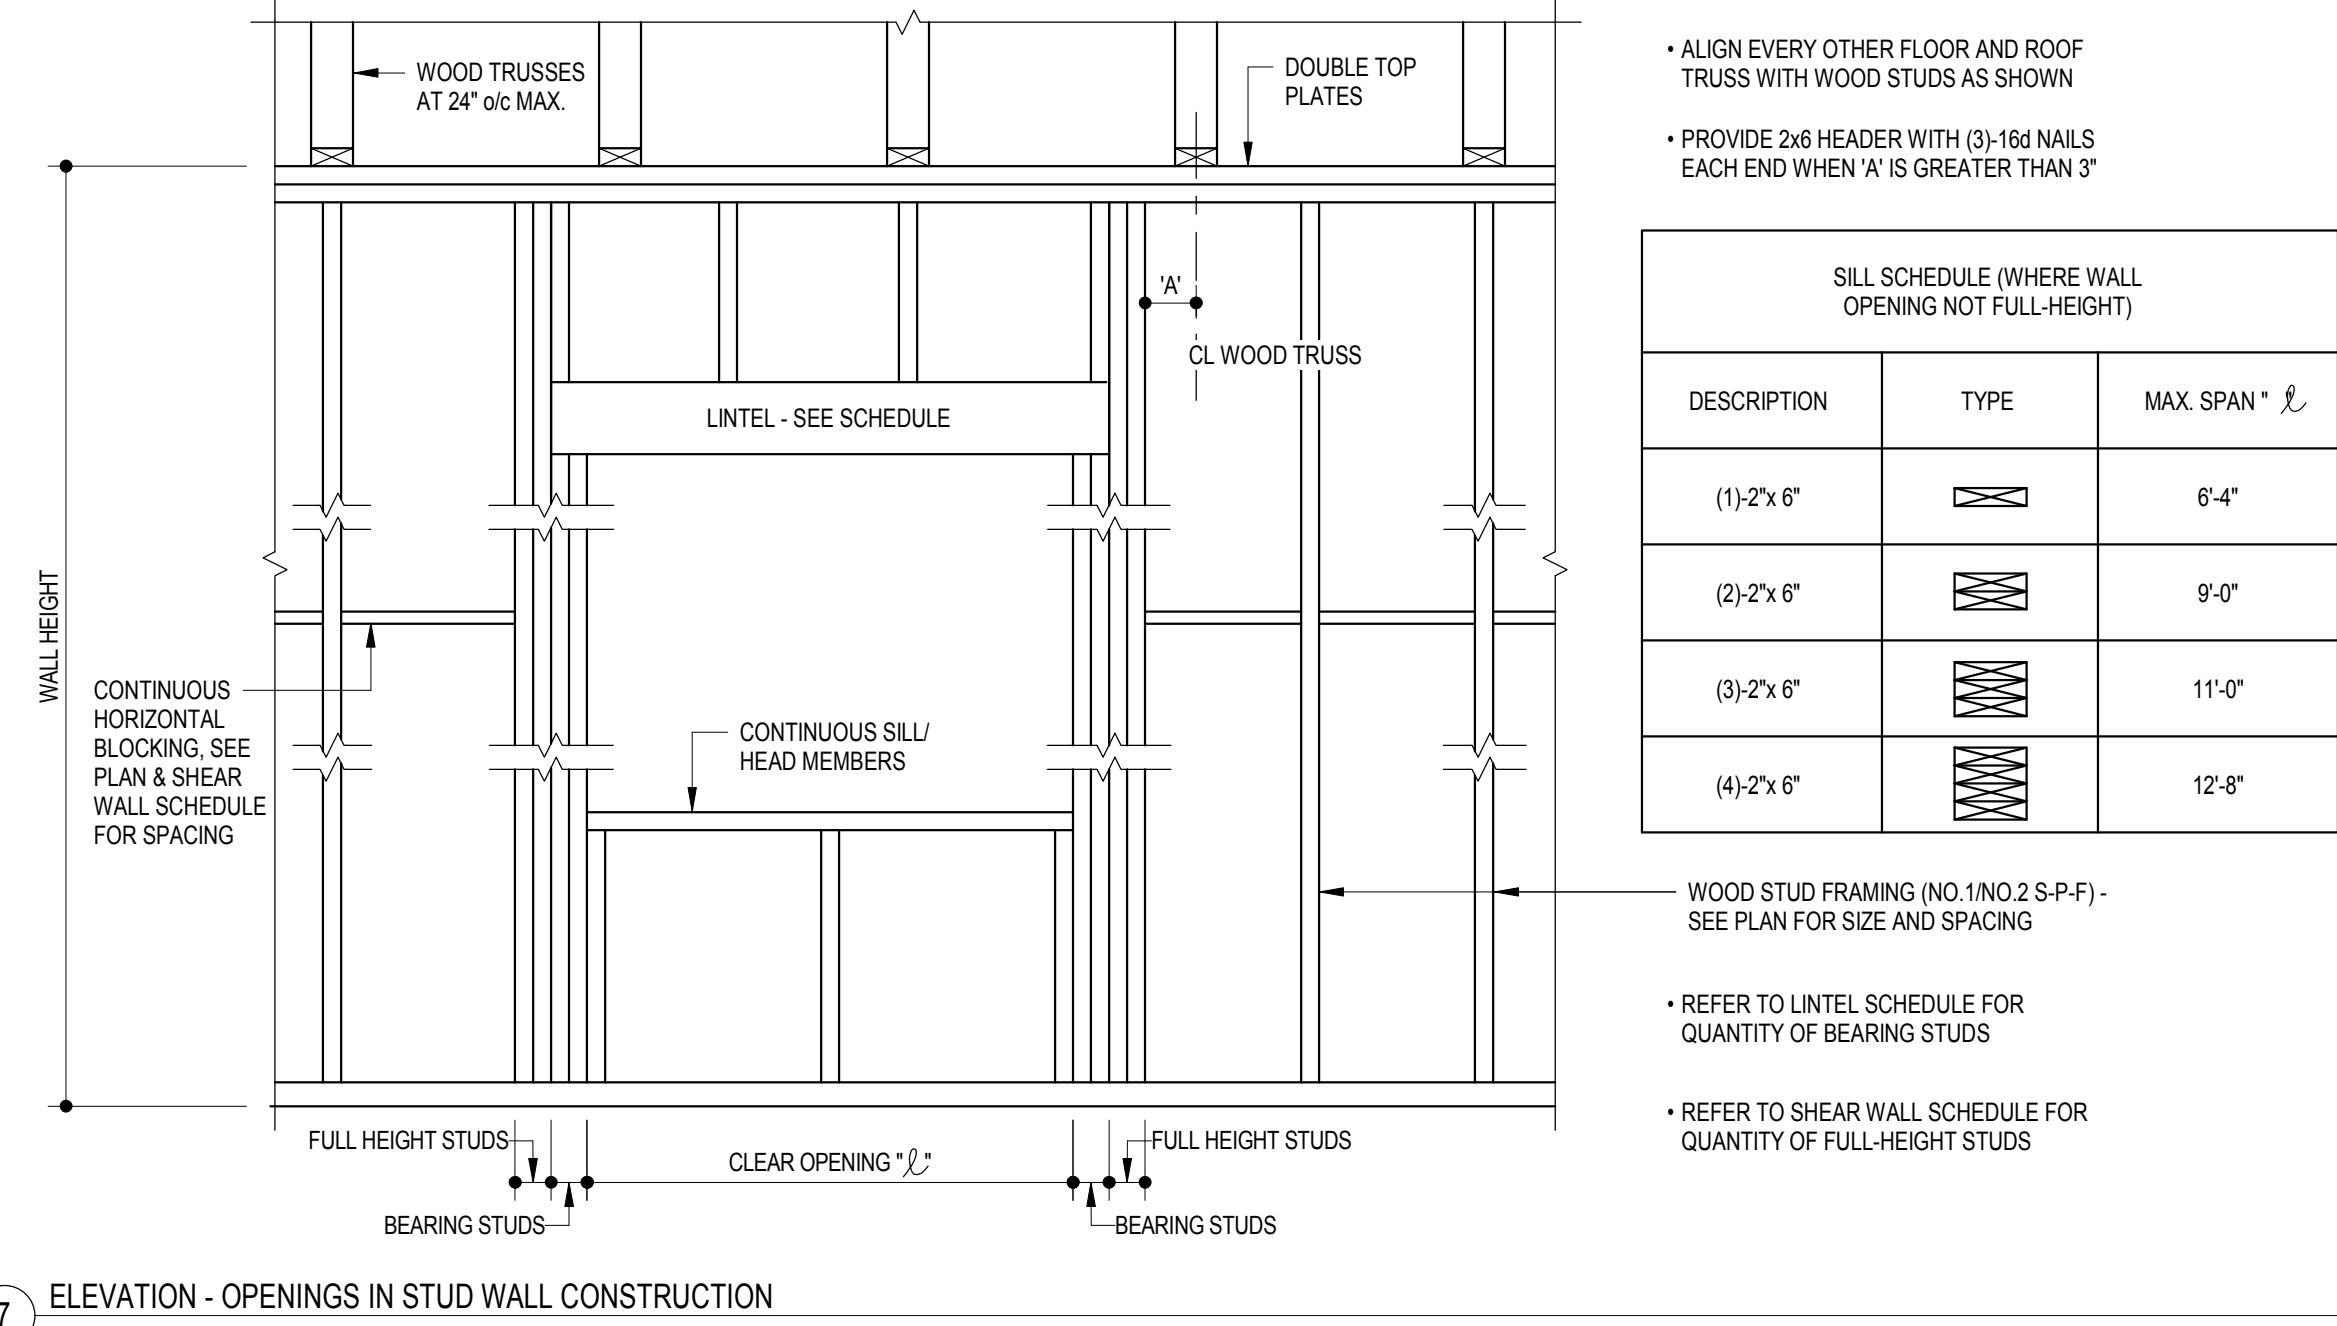
6 ALLOWABLE STUD NOTCH AND BORINGS
NOT TO SCALE



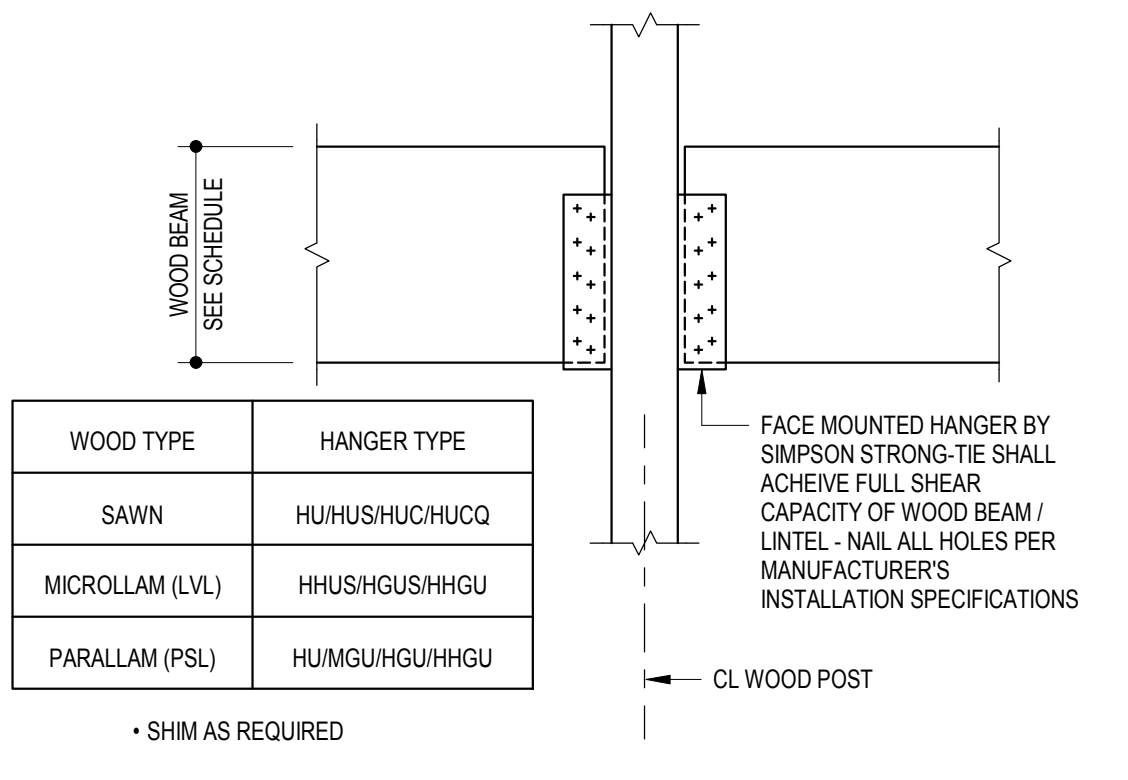
7 ELEVATION - OPENINGS IN STUD WALL CONSTRUCTION
3/4" x 1'-0"



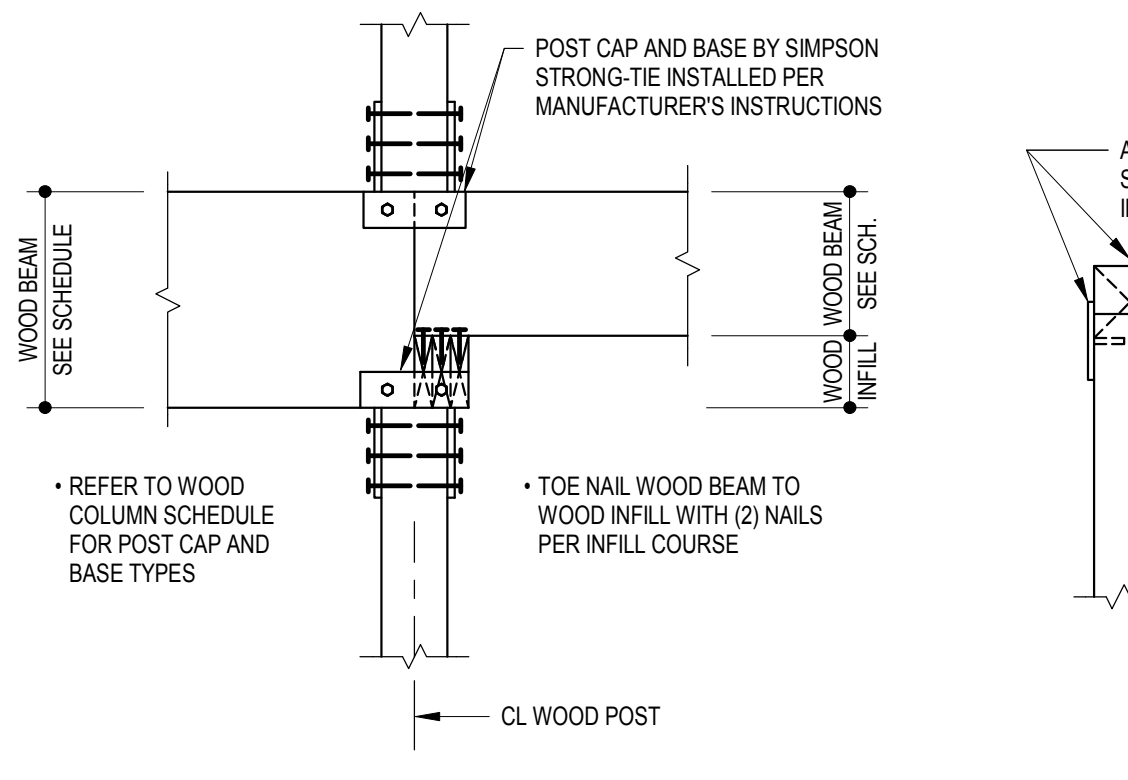
8 WOOD BEAM AT CONTINUOUS WOOD POST
3/4" x 1'-0"



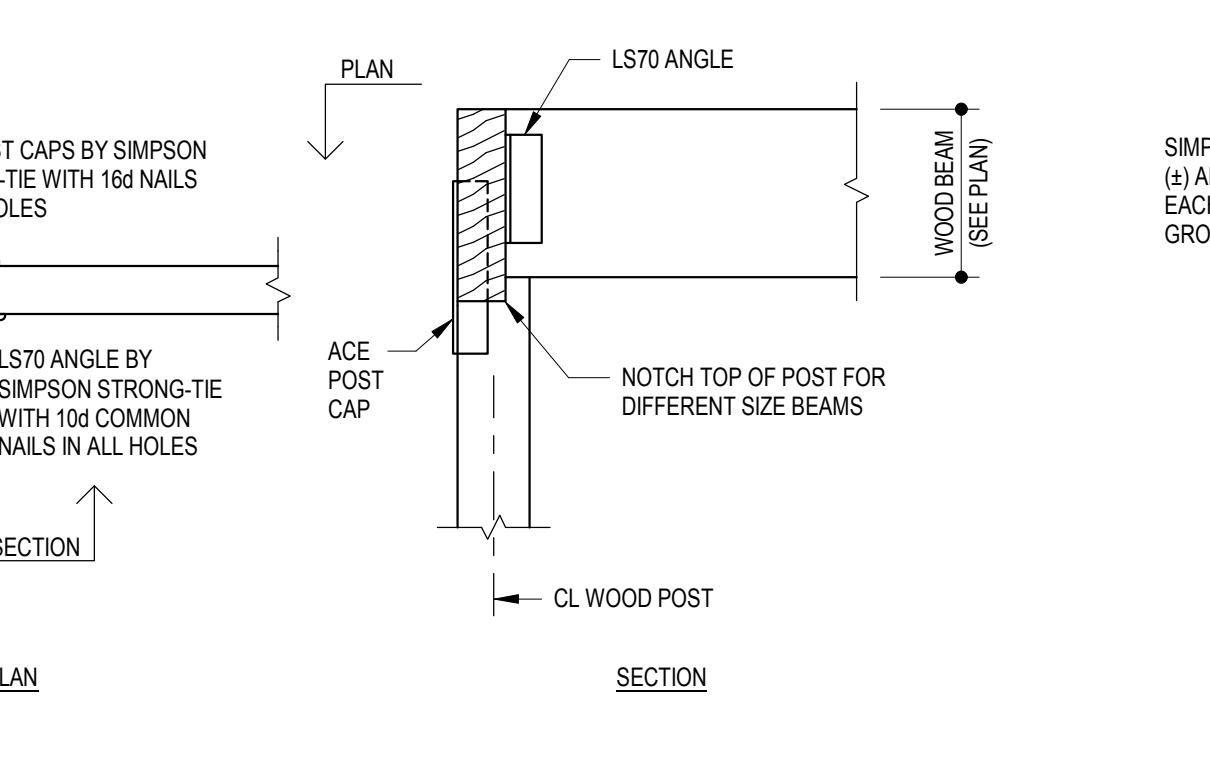
9 WOOD BEAM AT DISCONTINUOUS WOOD POST
3/4" x 1'-0"



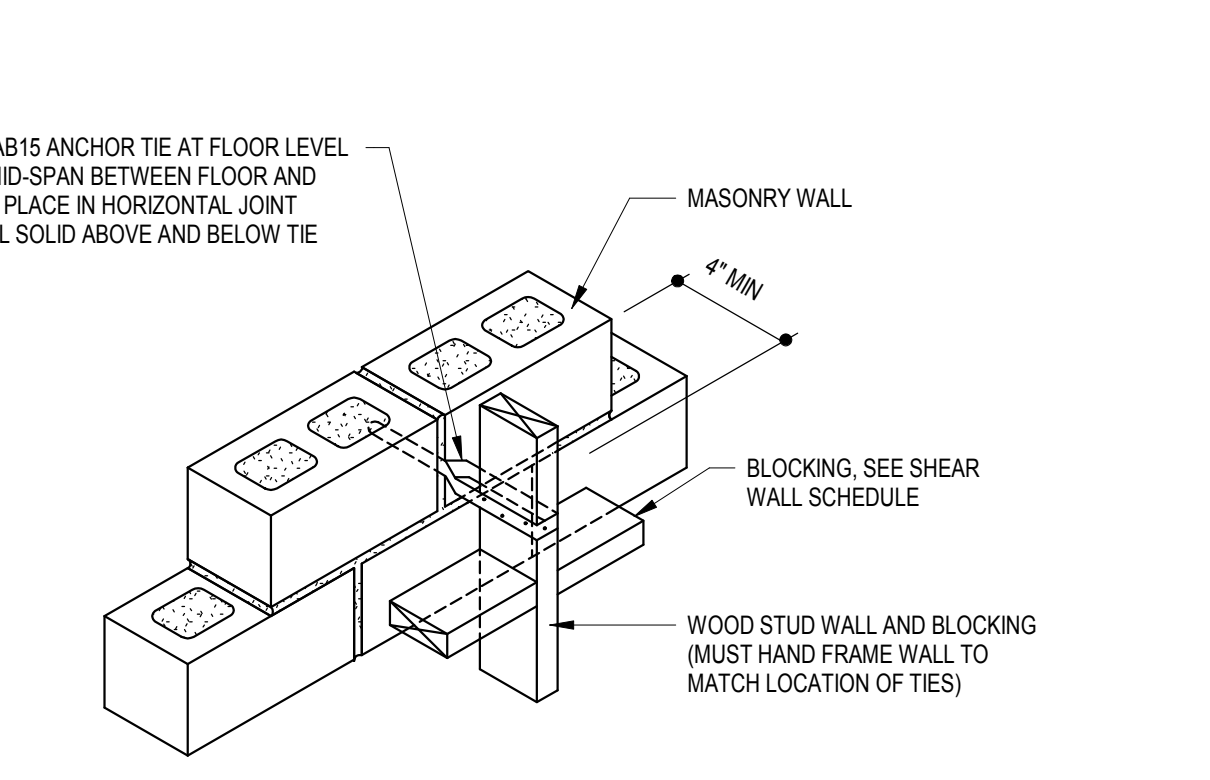
10 WOOD BEAMS AT CORNER WOOD POST
3/4" x 1'-0"



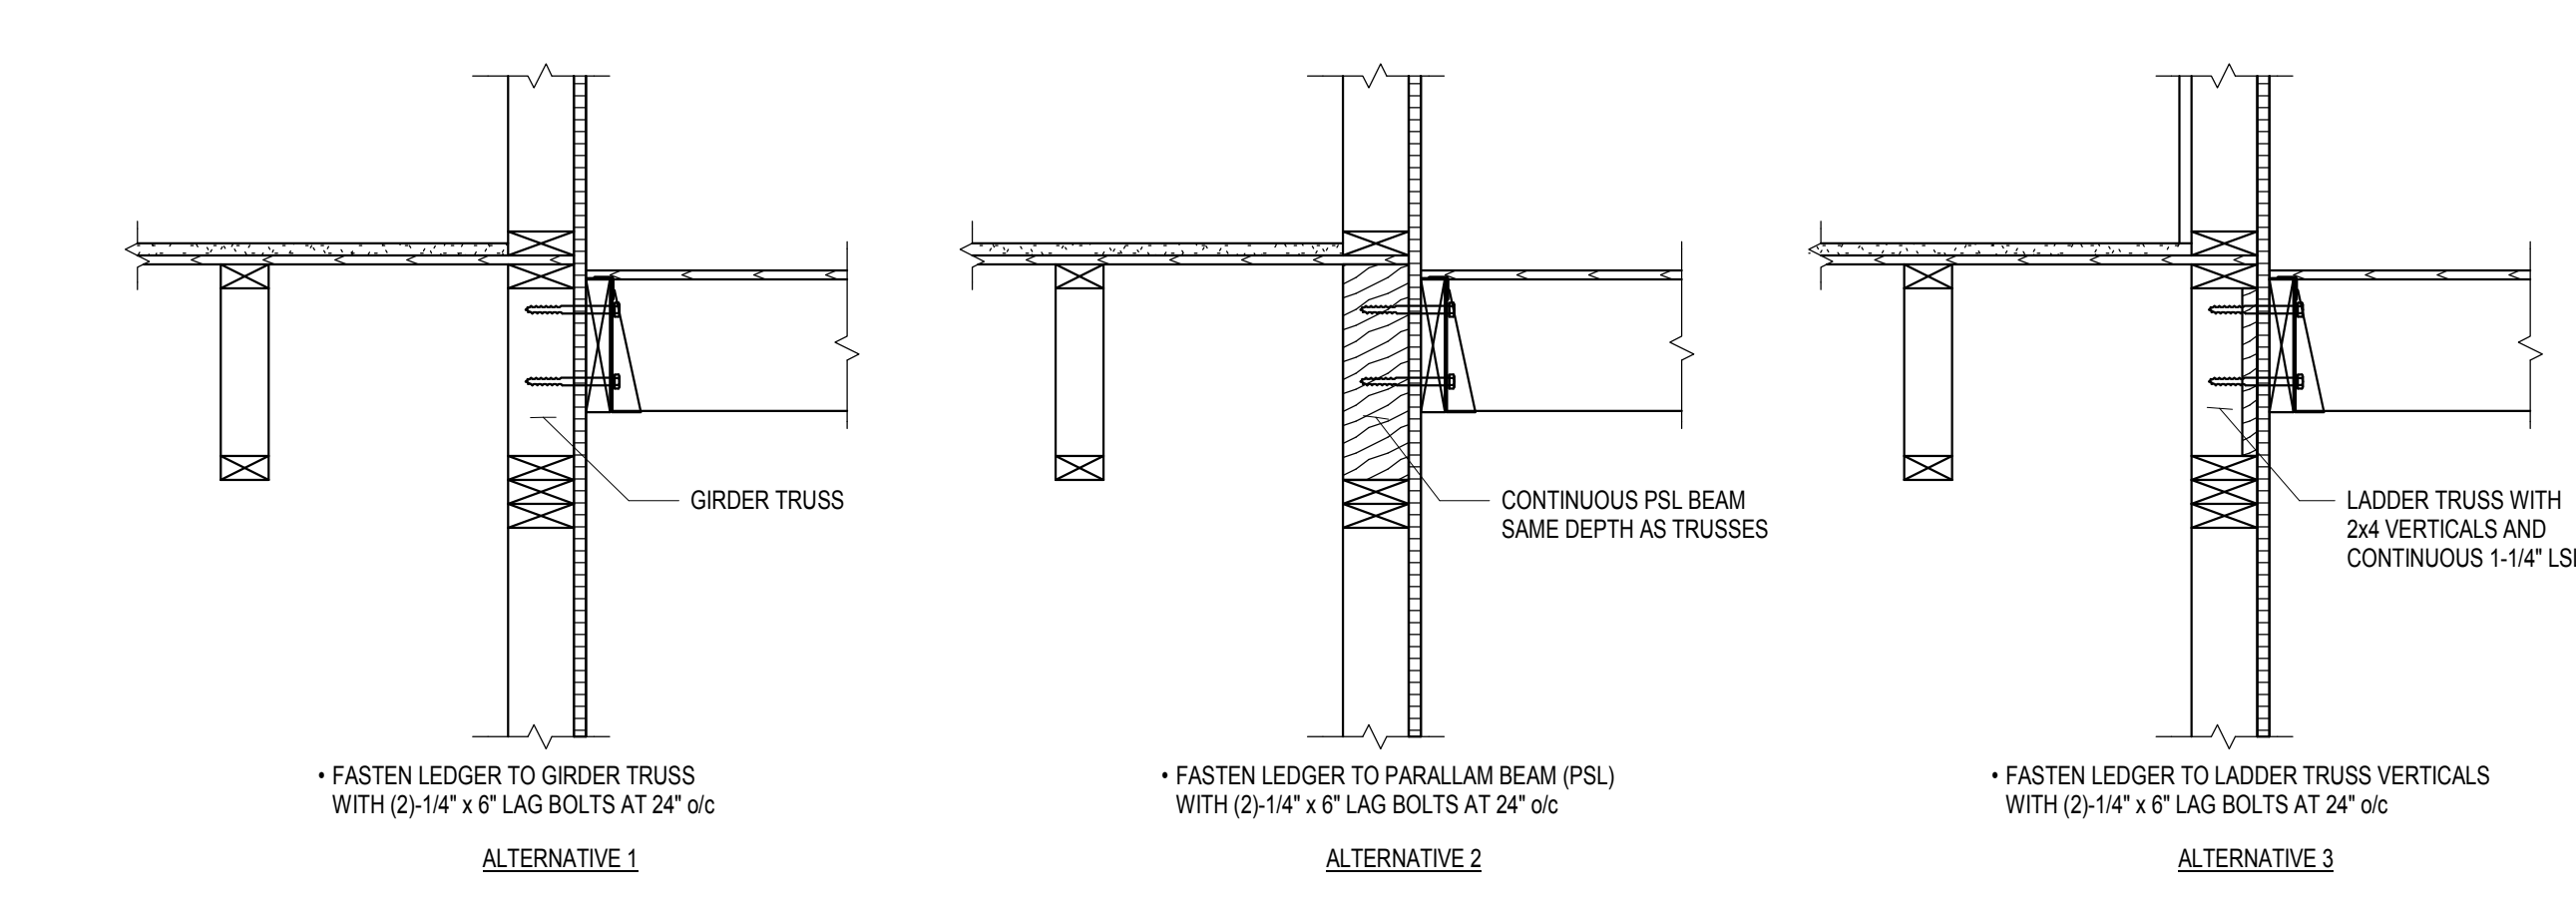
11 STUD WALL ANCHORAGE AT MASONRY WALL
3/4" x 1'-0"



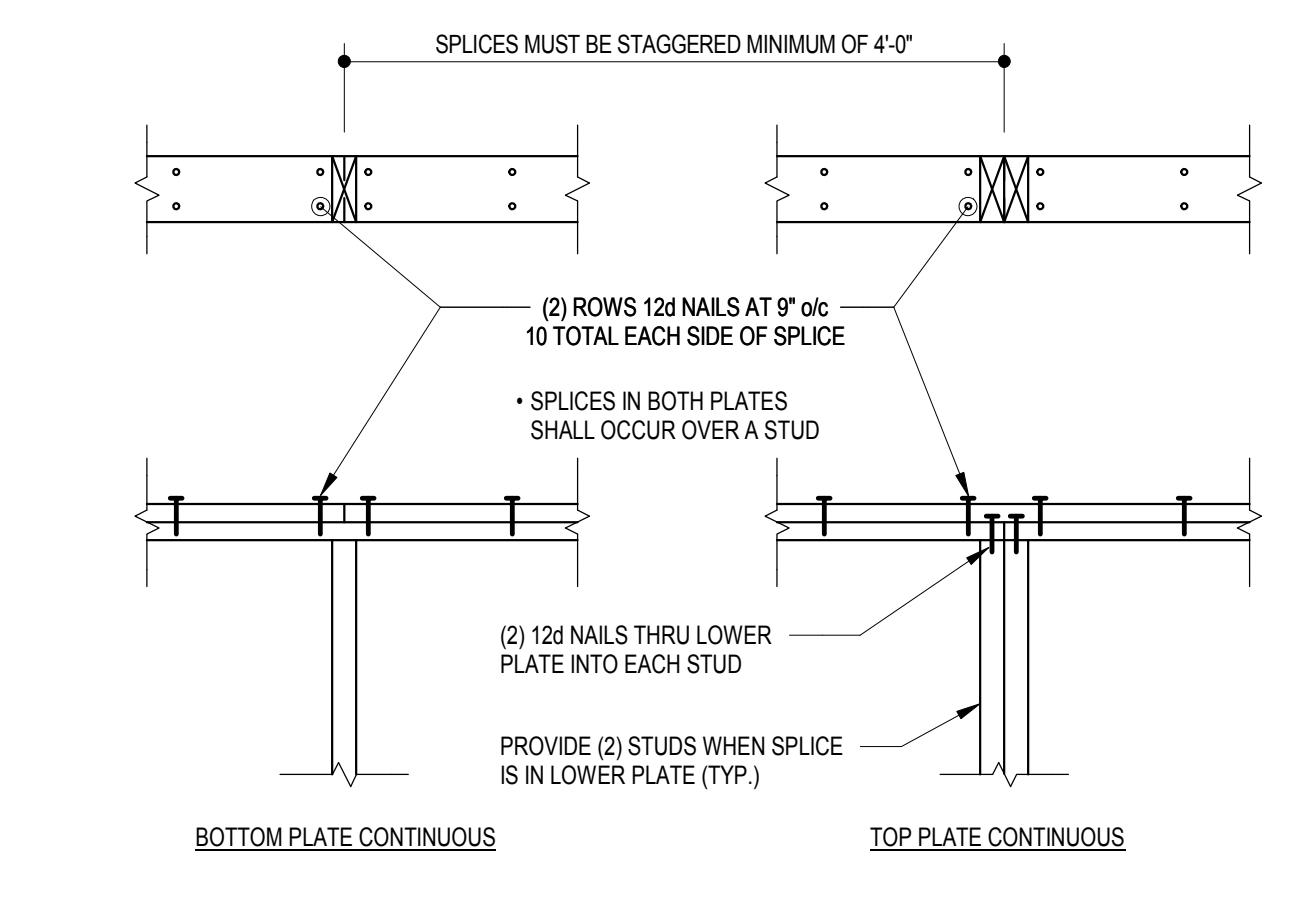12 TYPICAL LEDGER CONNECTIONS
3/4" x 1'-0"



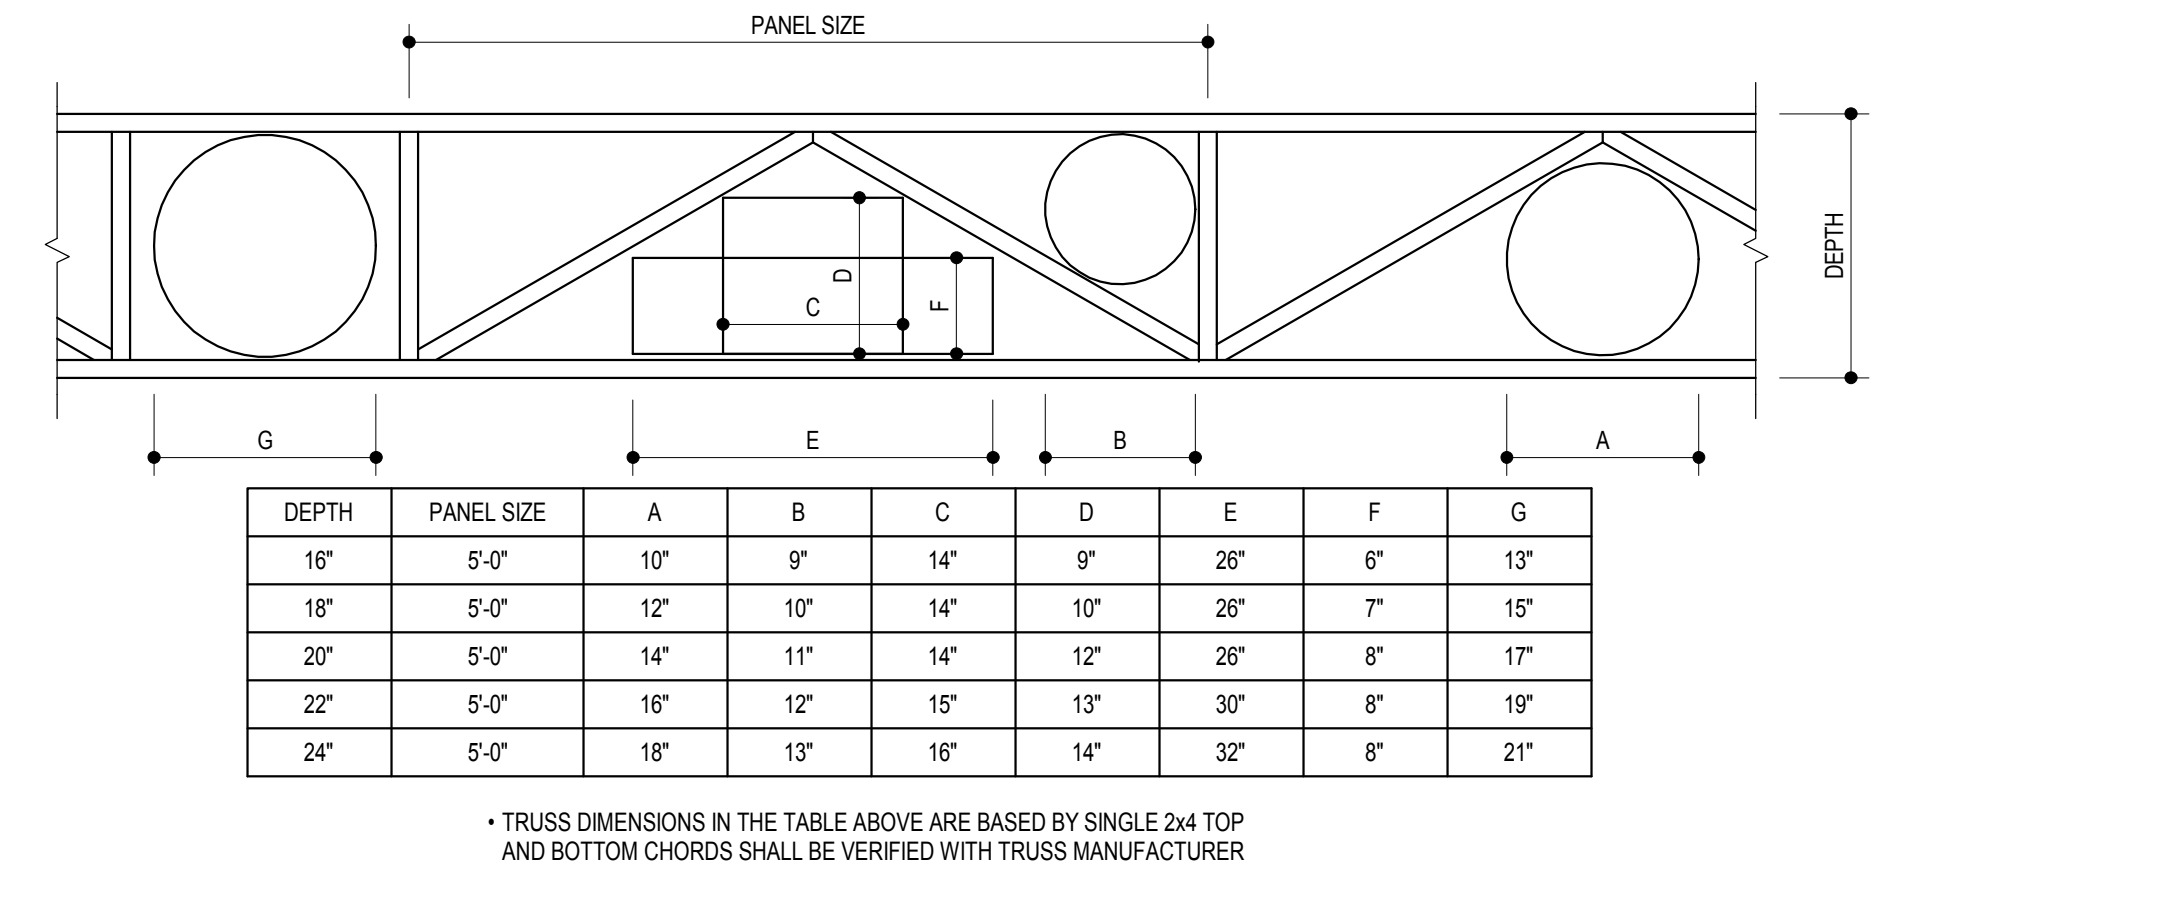13 TYPICAL TOP PLATE SPLICE
3/4" x 1'-0"



14 TYPICAL DUCT SIZES BETWEEN TRUSS OPENINGS
3/4" x 1'-0"

2012 INTERNATIONAL BUILDING CODE
SECTION 2308.9.10 - CUTTING AND NOTCHING
SECTION 2309.11 - BORED HOLES

Table with 2 columns: WOOD TYPE, HANGER TYPE. Values: SAWN, HUHUSHOCHUCU; MICROLAM (LVL), HHUHHUHHU; PARALLAM (PSL), HHUHHUHHU.


WOOD STUD FRAMING (NO. 1 AND 2 S-P-F) - SEE PLAN FOR SIZE AND SPACING
REFER TO LINTEL SCHEDULE FOR QUANTITY OF BEARING STUDS
REFER TO SHEAR WALL SCHEDULE FOR QUANTITY OF FULL-HEIGHT STUDS

WOOD TRUSSES NOT SHOWN FOR CLARITY
REFER TO LINTEL SCHEDULE FOR ADDITIONAL INFORMATION
TOE NAIL AT EACH JACK STUD
FULL HEIGHT STUDS - SEE LINTEL SCHEDULE
FASTEN FULL HEIGHT STUDS TO LINTEL END WITH (3) PENNY NAILS (MIN.)
DISCONTINUOUS DOUBLE TOP PLATES
NAIL MULTIPLE PLYS TOGETHER - SEE SCHEDULE

PROJECT TEAM
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CIVIL ENGINEER: WBCM
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Table with 3 columns: REV.#, DESCRIPTION, DATE. Contains revision entries.

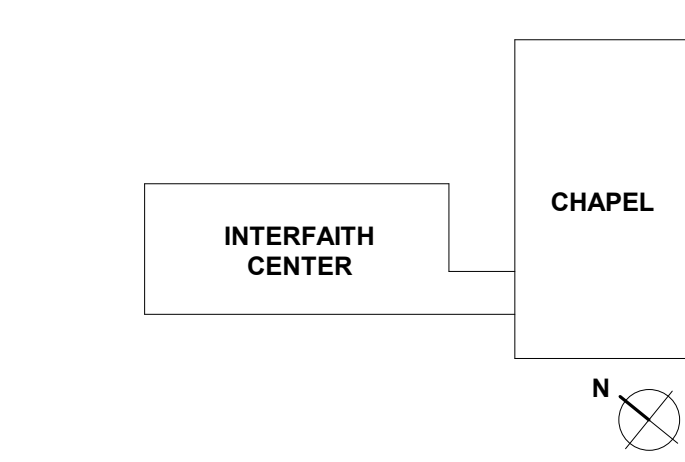KEY PLAN



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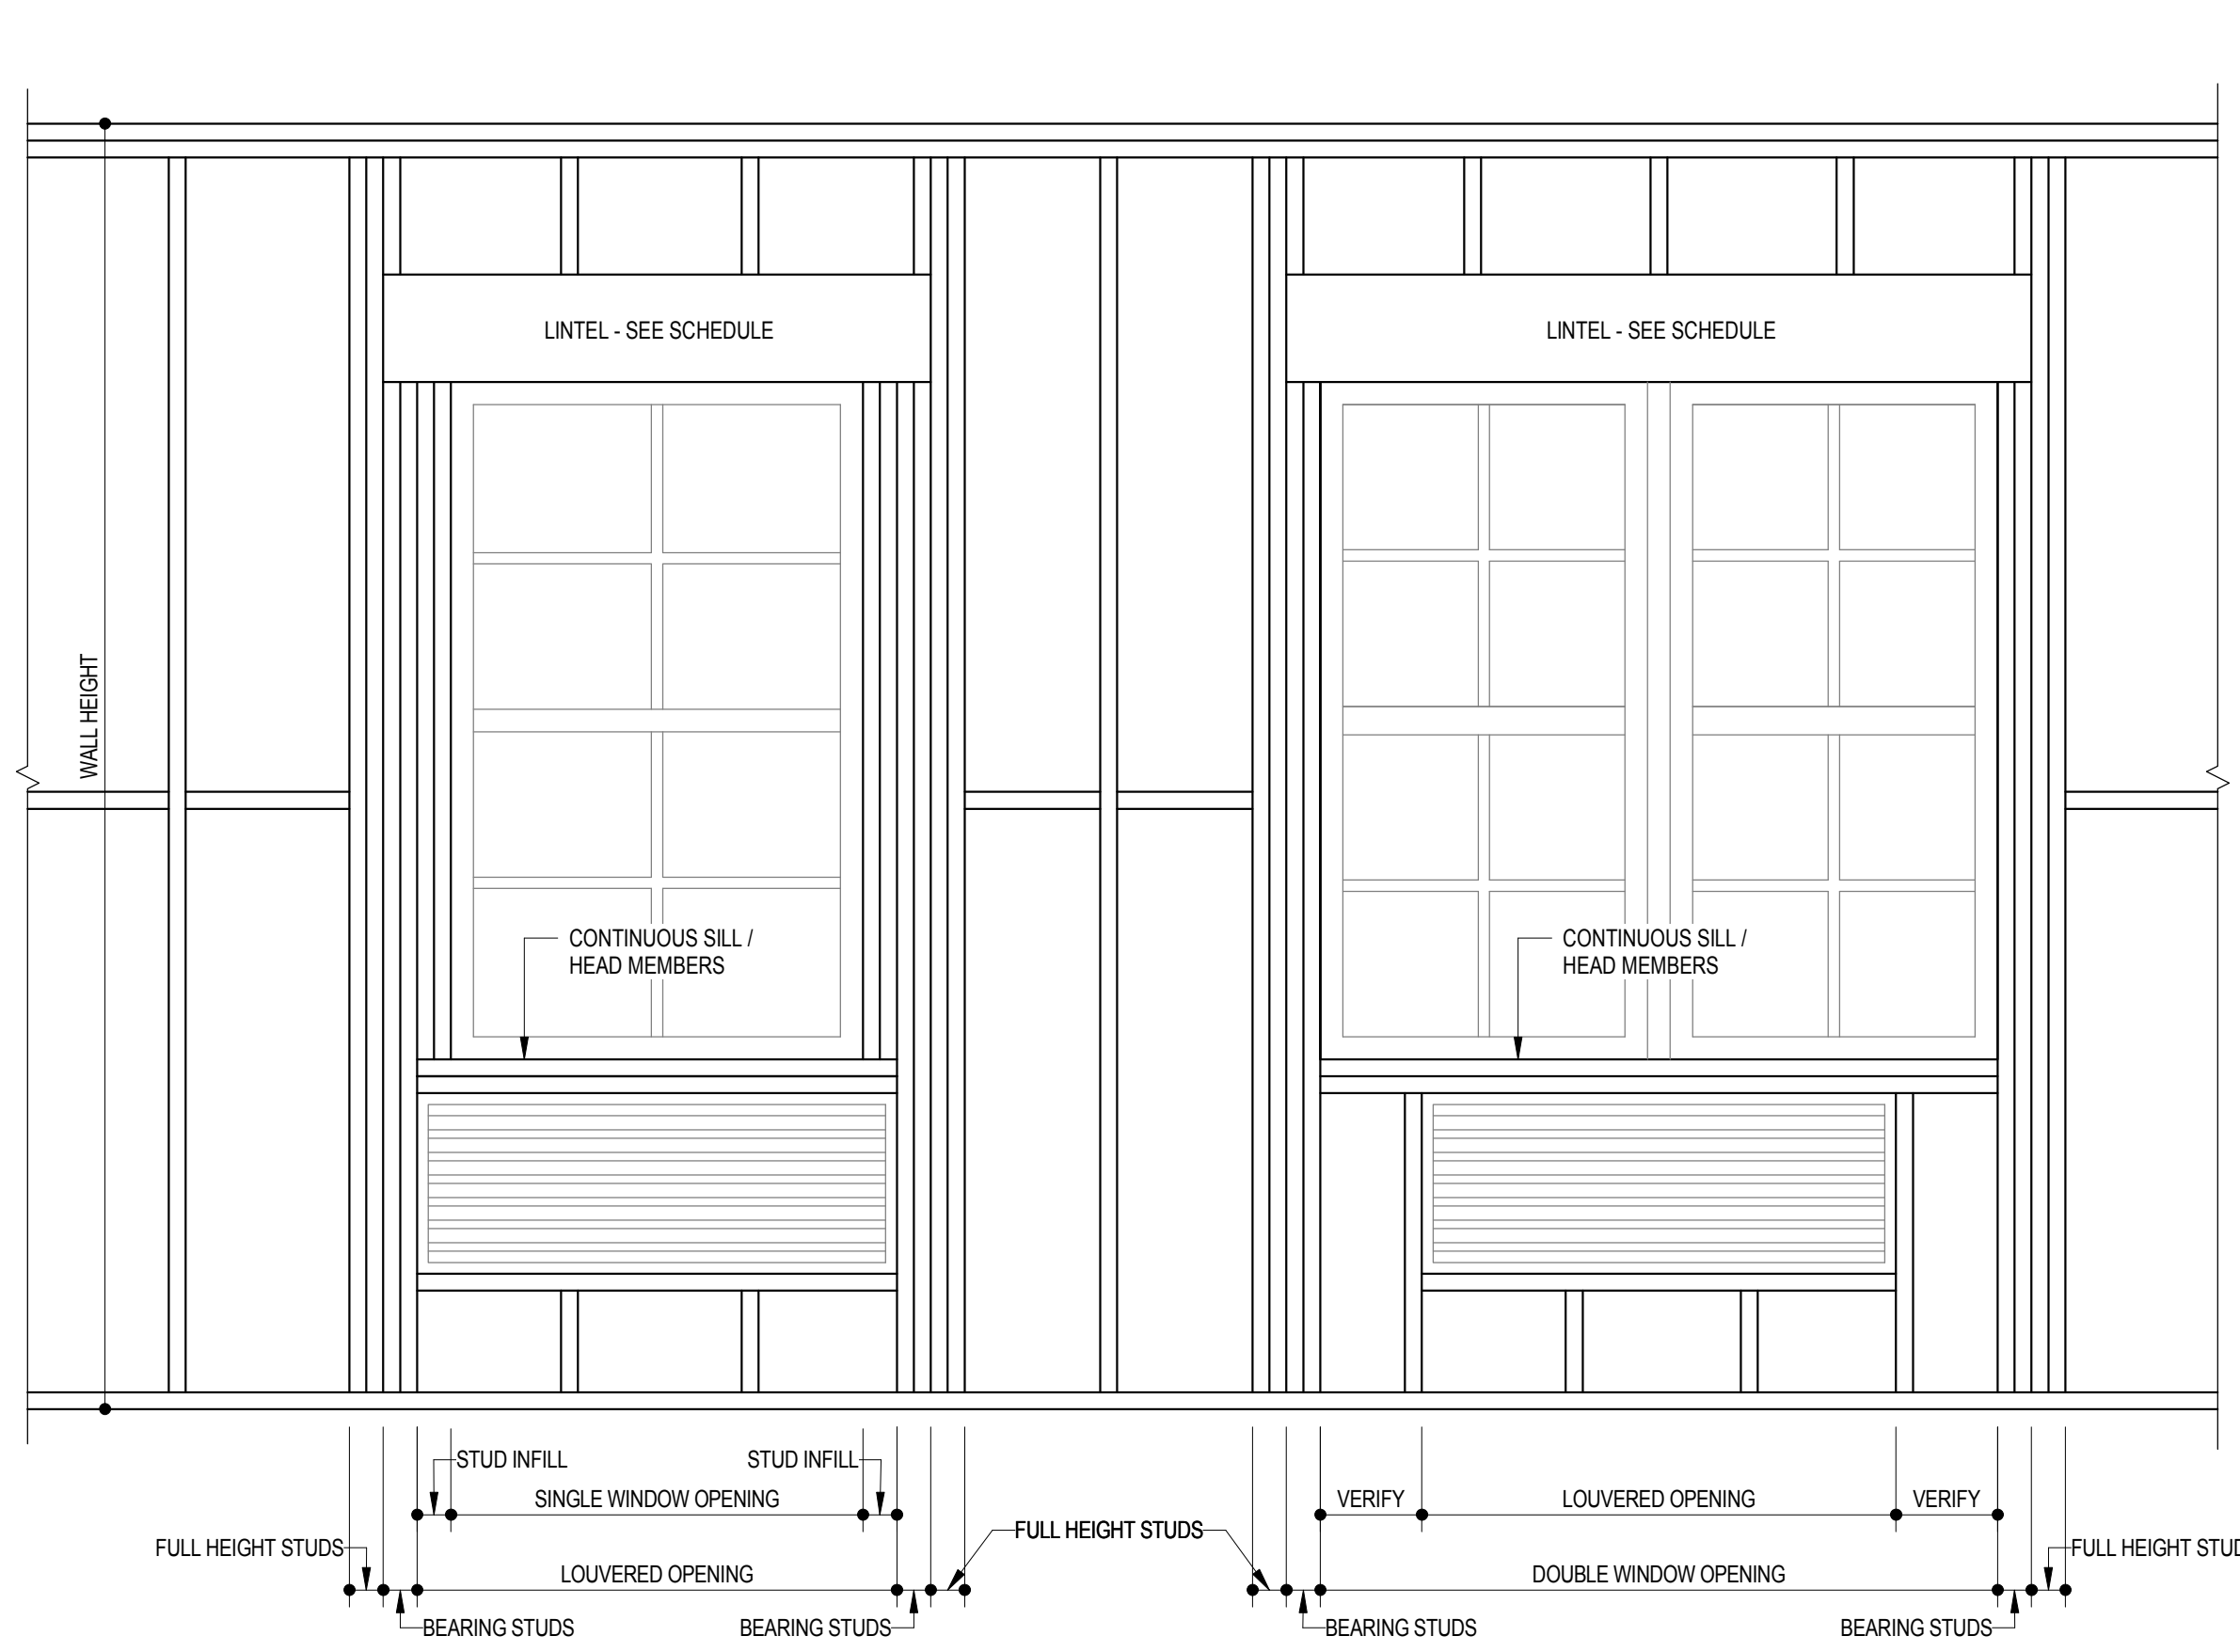
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PROJECT DESIGN PHASE


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DRAWING NAME: TYPICAL WOOD FRAMING DETAILS


DRAWING NUMBER: S3.03



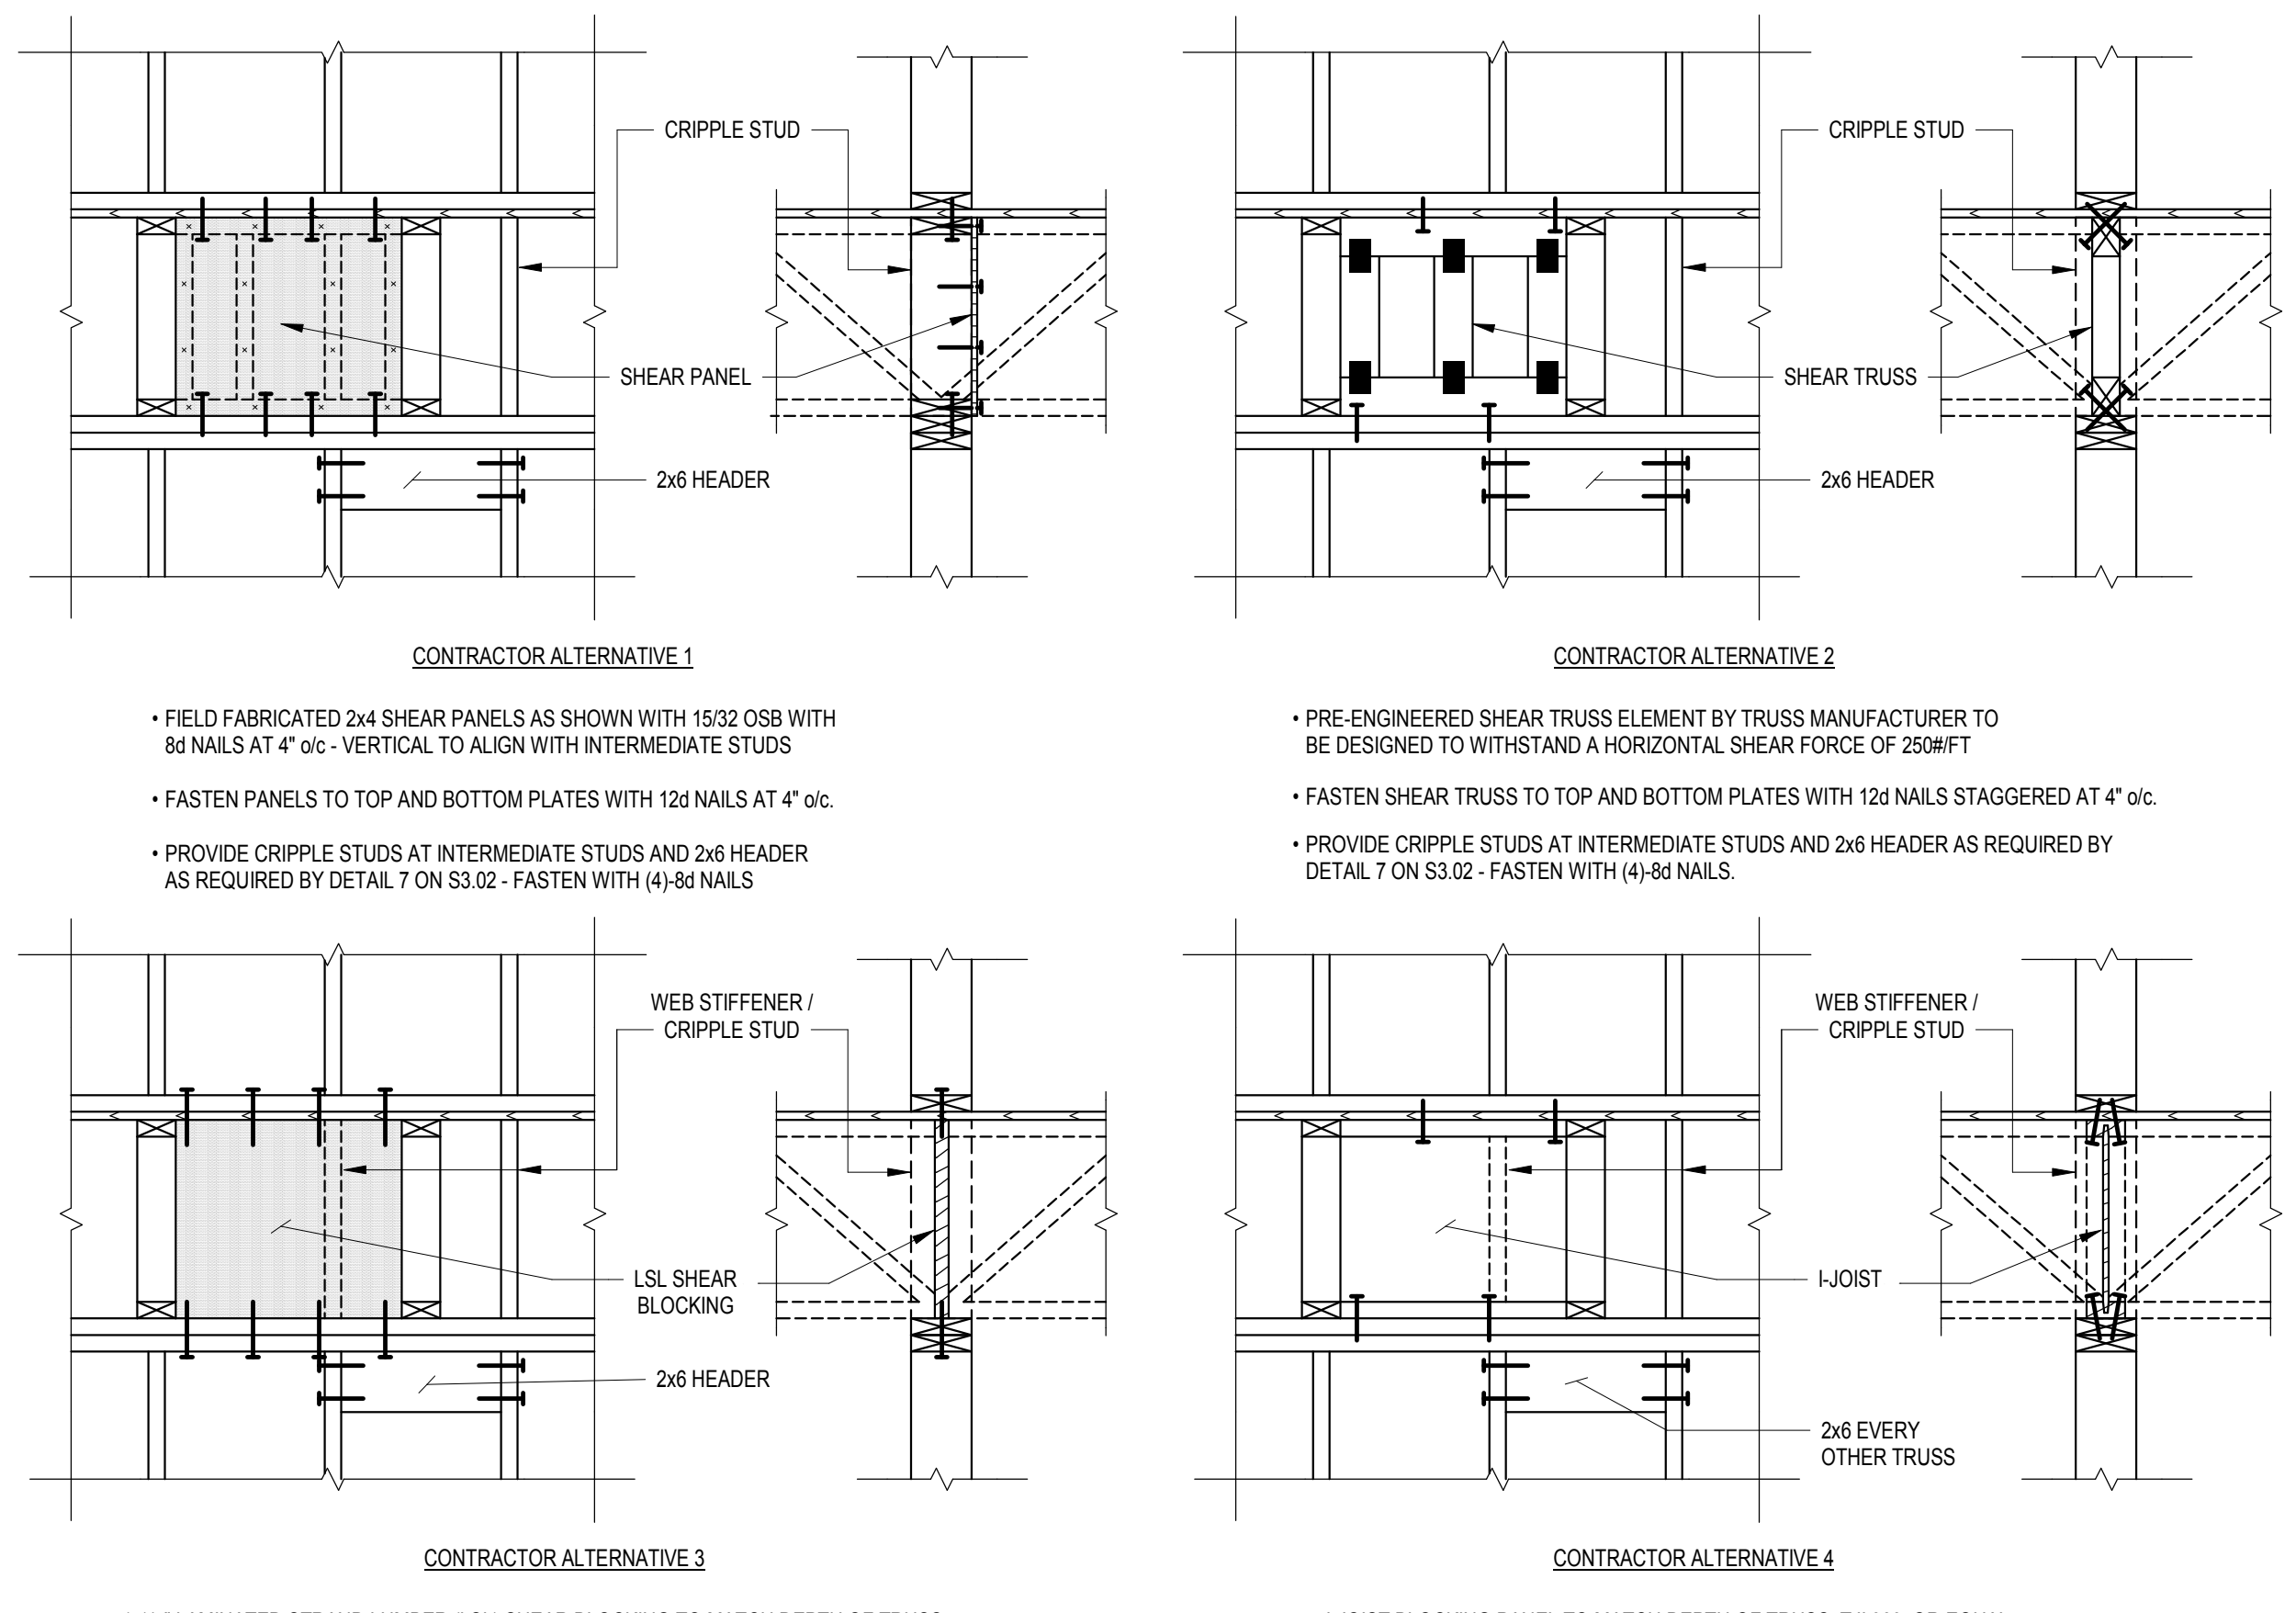
1 LOUVERED OPENINGS IN EXTERIOR WALL 3/4" x 1'-0"



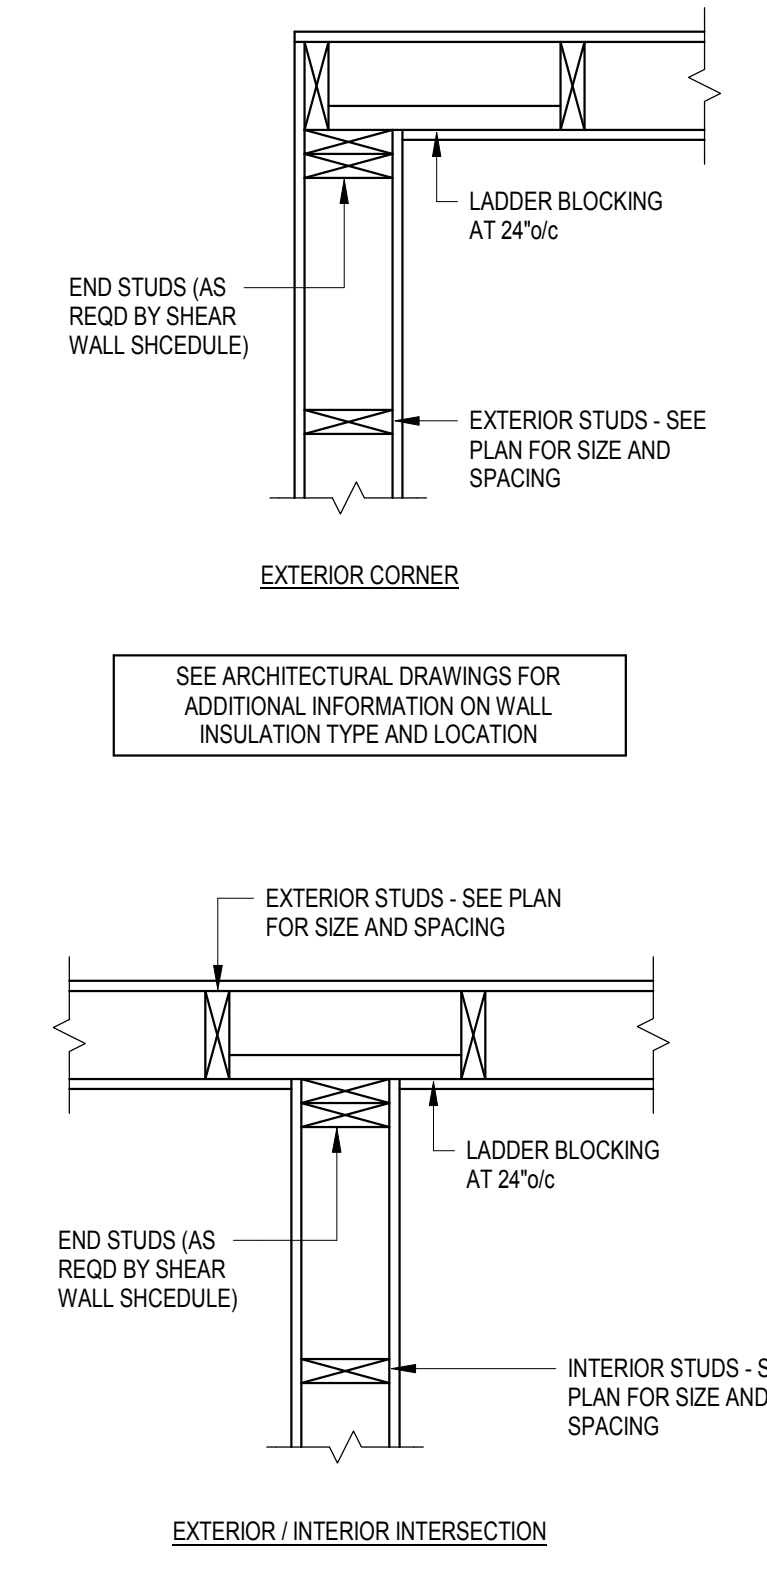2 TYPICAL SHEAR PANELING AT TRUSS BEARING CONDITIONS 3/4" x 1'-0"




3 INSULATED STUD CORNERS 1" x 1'-0"

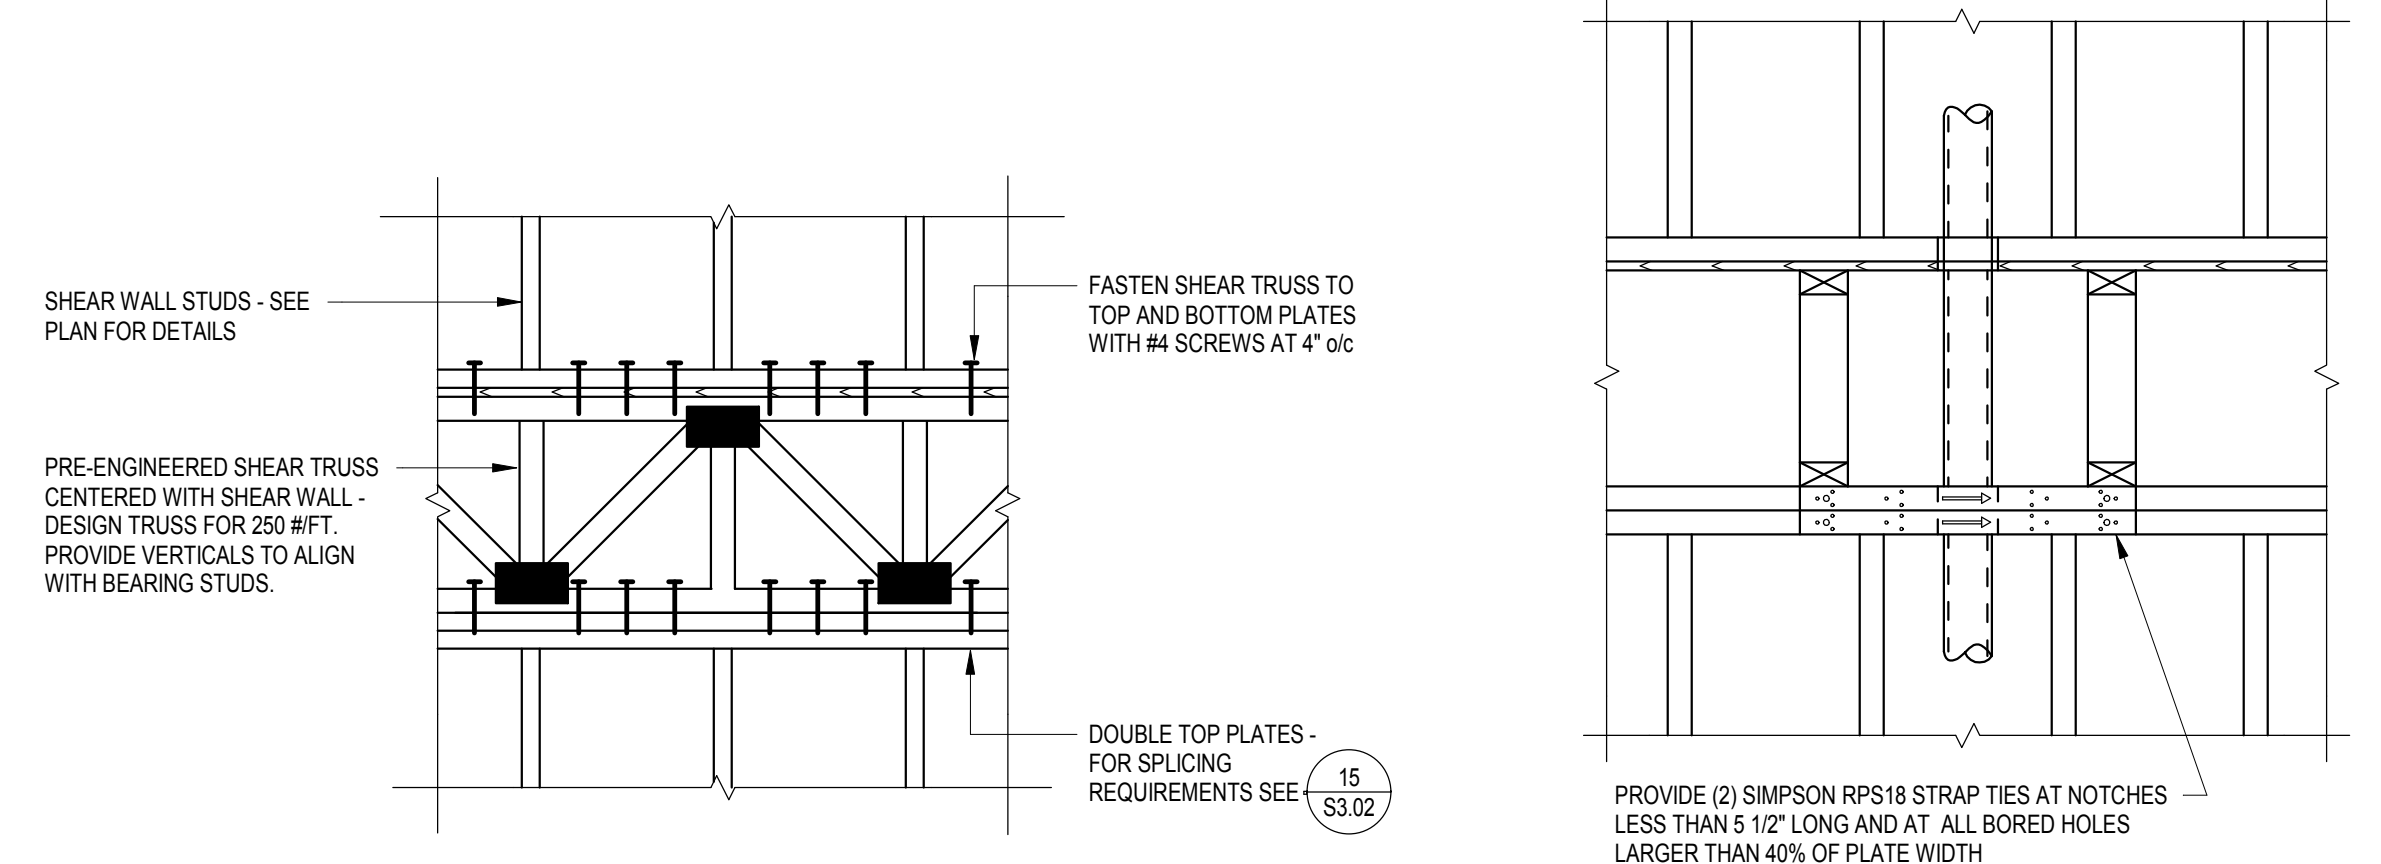


4 CONTINUOUS SHEAR TRUSS 3/4" x 1'-0"

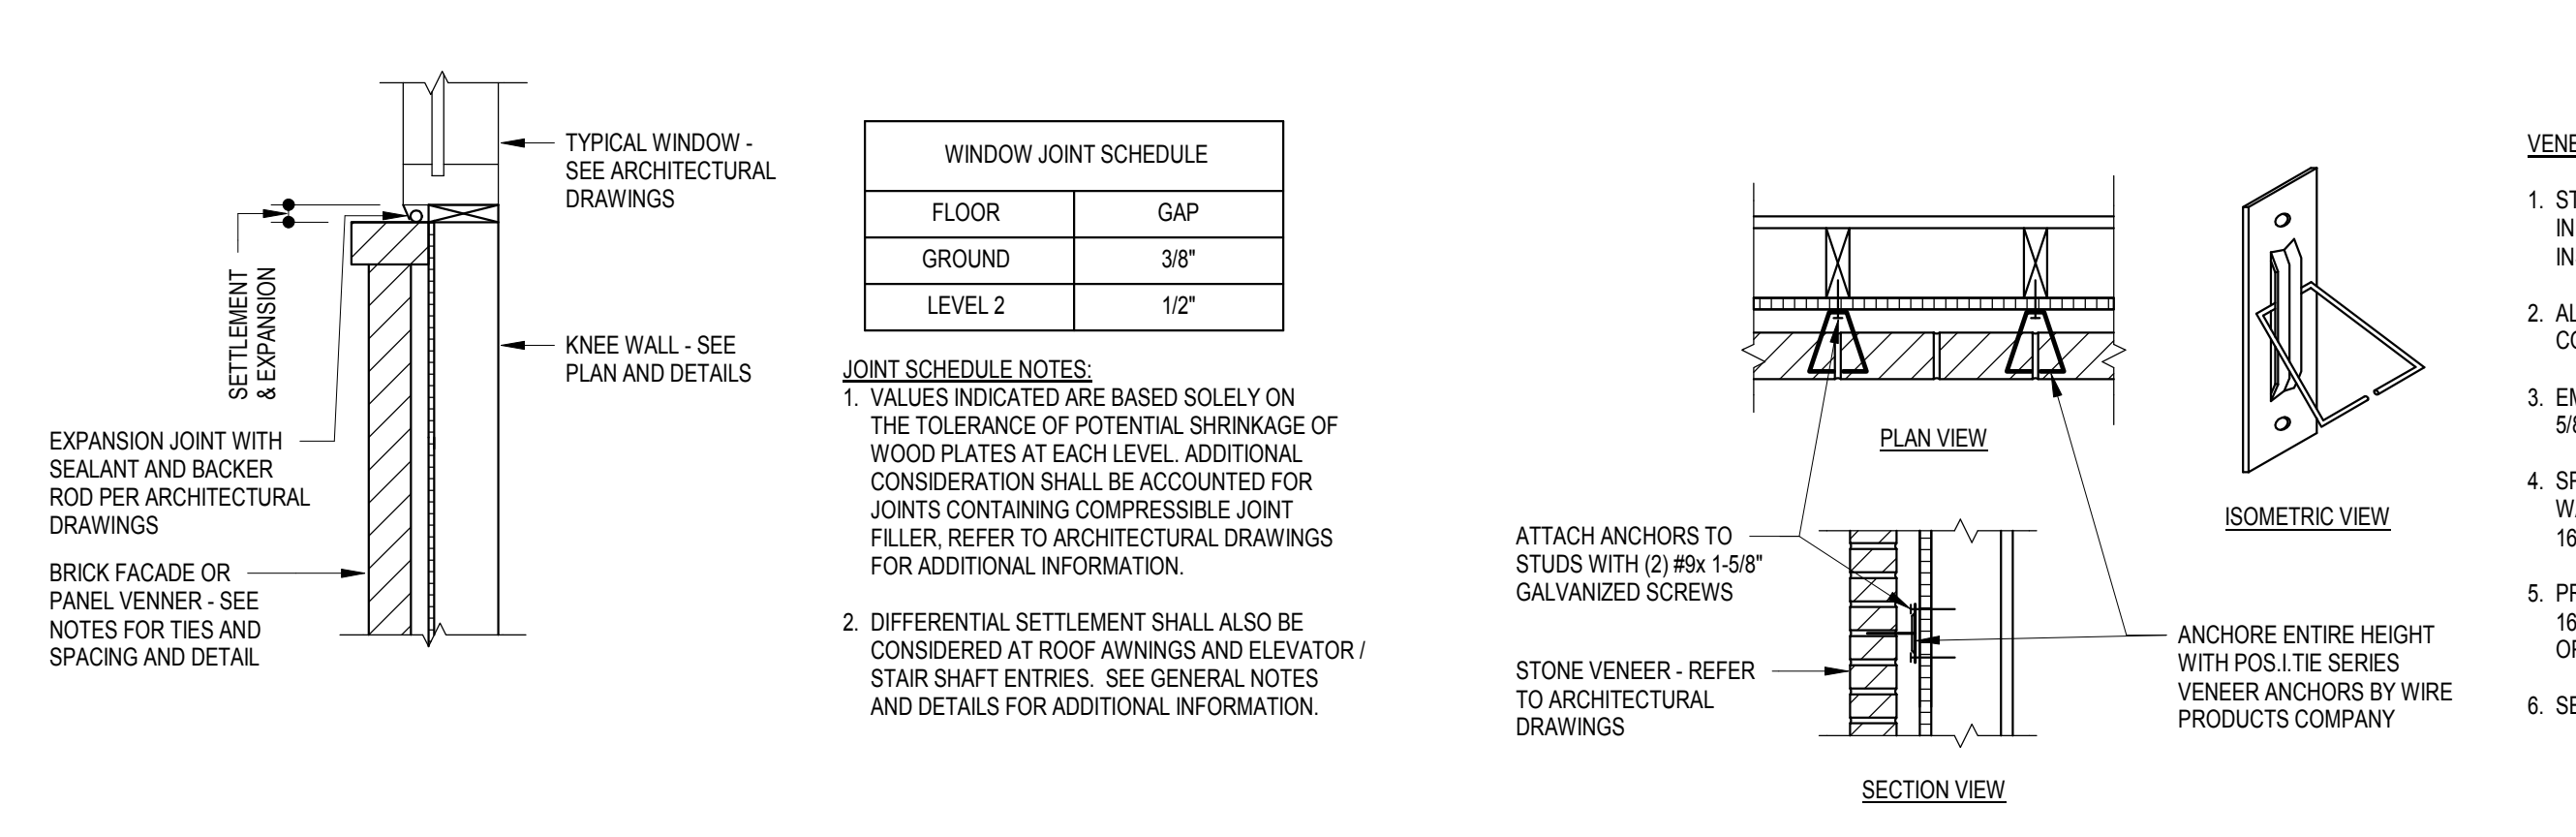5 TOP PLATE PENETRATIONS 3/4" x 1'-0"



6 TYPICAL EXPANSION JOINT AT WINDOW SILL 3/4" x 1'-0"

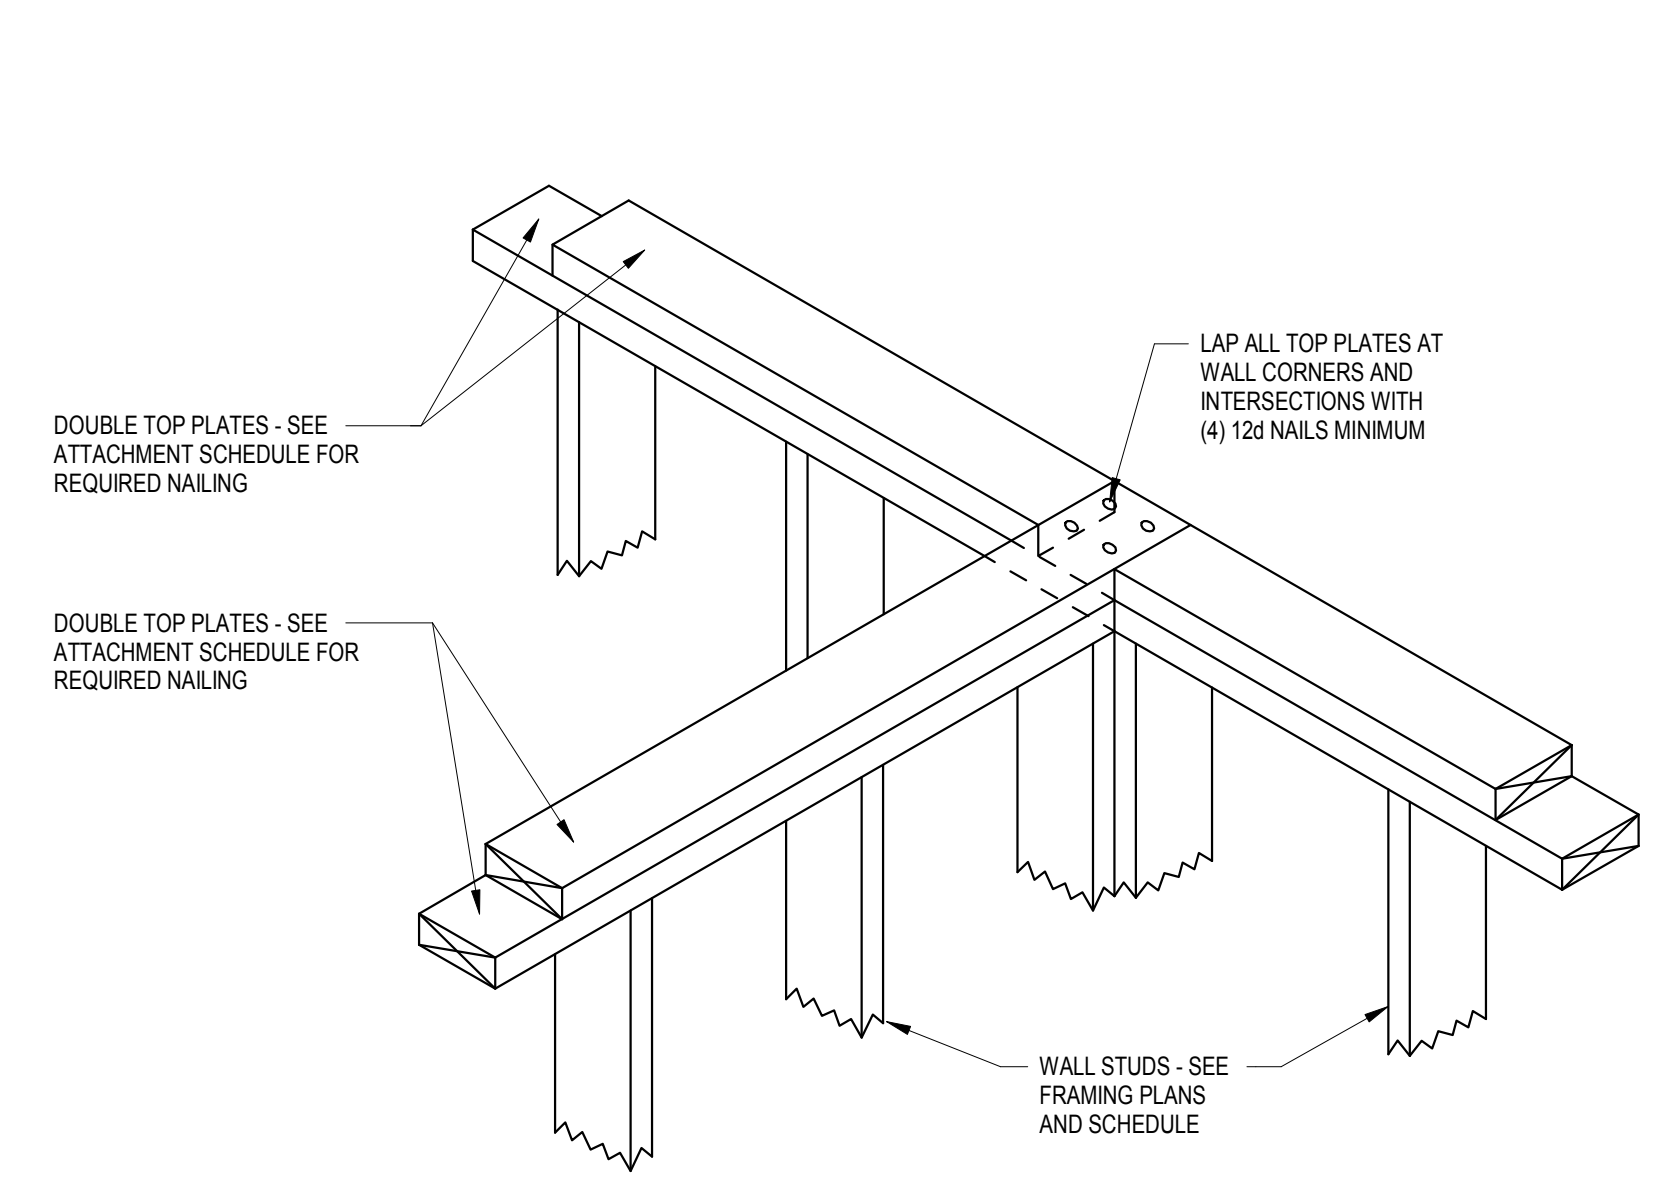
7 TYPICAL BRICK VENEER ANCHOR TIES 3/4" x 1'-0"




8 TYPICAL TOP PLATE INTERSECTION 1" x 1'-0"

WOOD ROOF AND FLOOR TRUSS NOTES

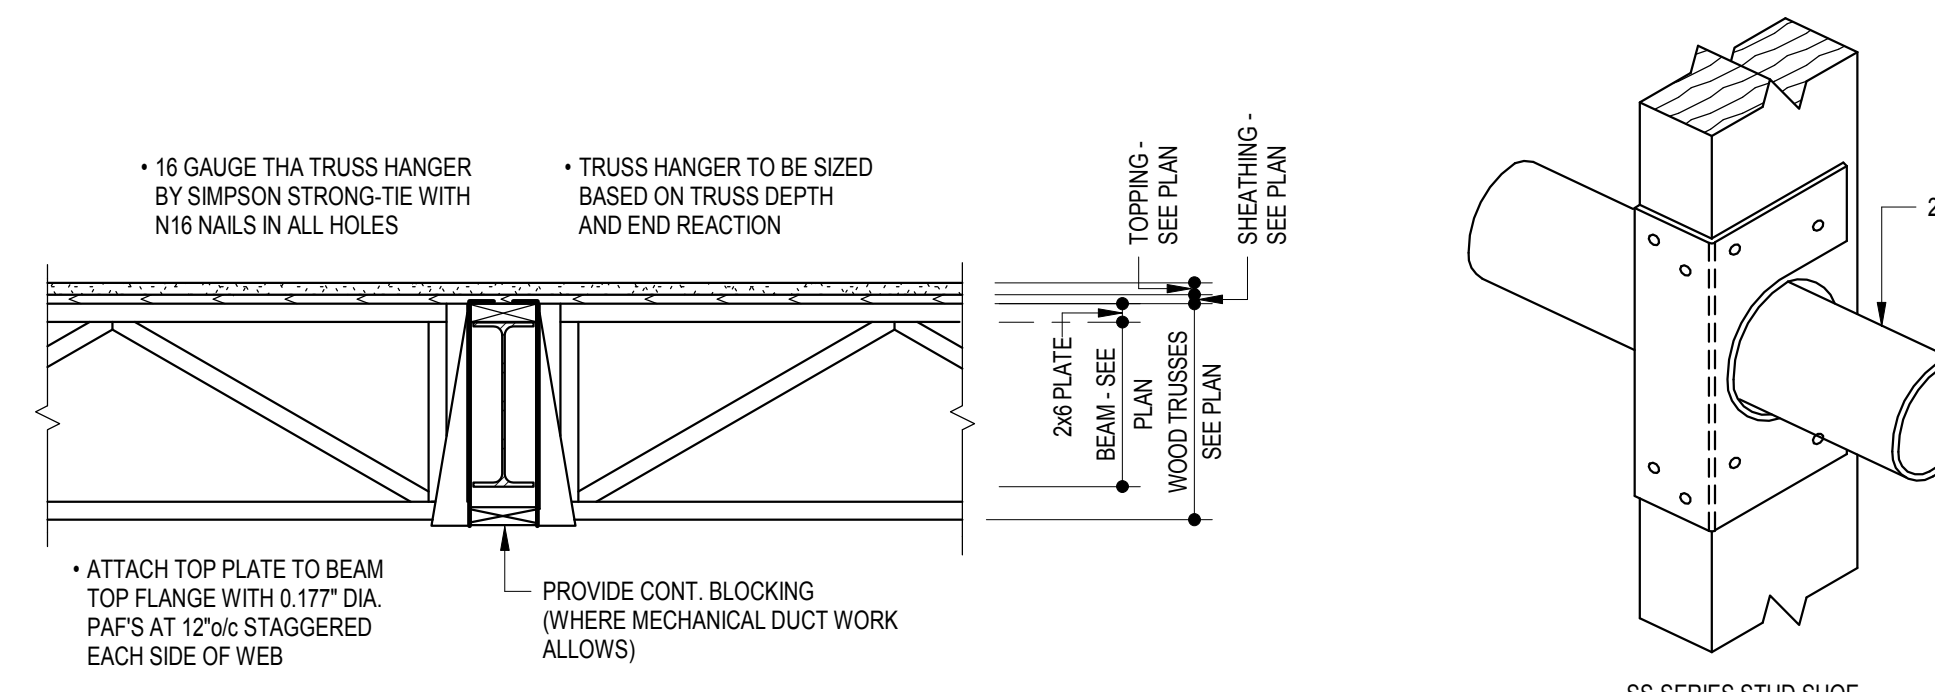- 1. DESIGN: TRUSS MANUFACTURER IS COMPLETELY RESPONSIBLE FOR DESIGN AND FABRICATION OF ALL ROOF AND FLOOR TRUSSES...
2. DESIGN LOADS: FLOOR TRUSSES SHALL BE DESIGNED FOR THE APPROPRIATE FLOOR LOADINGS...
3. BRACING: PERMANENT BRACING REQUIRED FOR INDIVIDUAL TRUSS MEMBERS...



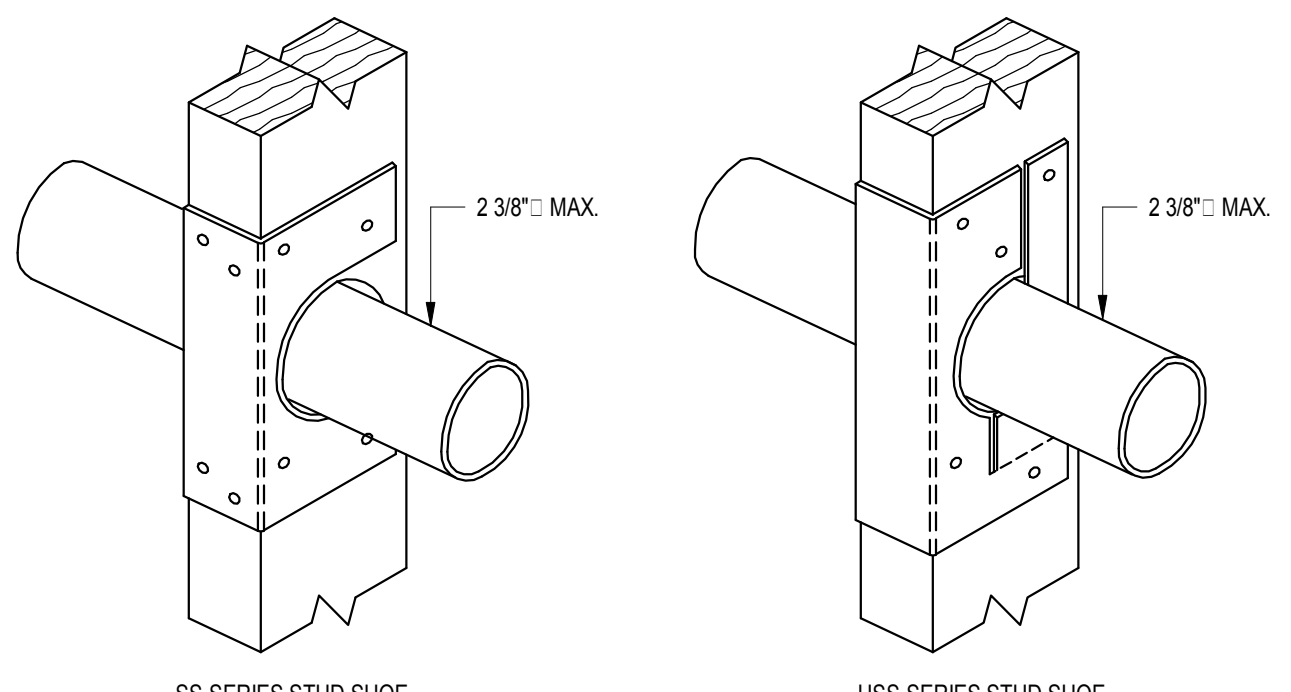9 TYPICAL WOOD TRUSSES BEARING AT STEEL BEAM 3/4" x 1'-0"



10 STUD SHOE REINFORCING 3" x 1'-0"

STUD SHOE REINFORCEMENT NOTES:

- 1. STUD SHOES SHALL BE PROVIDED TO REINFORCE STUDS WHERE BORINGS DO NOT MEET THE CRITERIA SET BY DETAIL...
2. STUD SHOES BY SIMPSON STRONG-TIE...
3. ONLY (1) STUD SHOE SHALL BE PERMITTED PER STUD, IF MULTIPLE BORINGS EXIST IN SINGLE STUD, CONTACT ENGINEER.

Table with 3 columns: STUD SIZE, SS-SERIES, HSS-SERIES. Lists stud sizes and corresponding shoe series.

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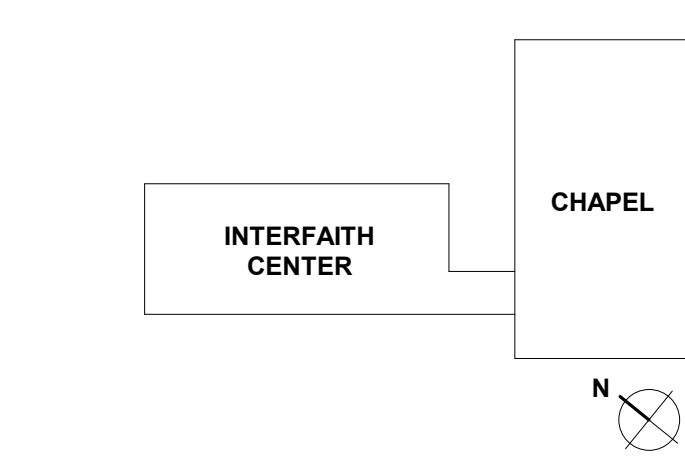
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REVISIONS		
REV. #	DESCRIPTION	DATE

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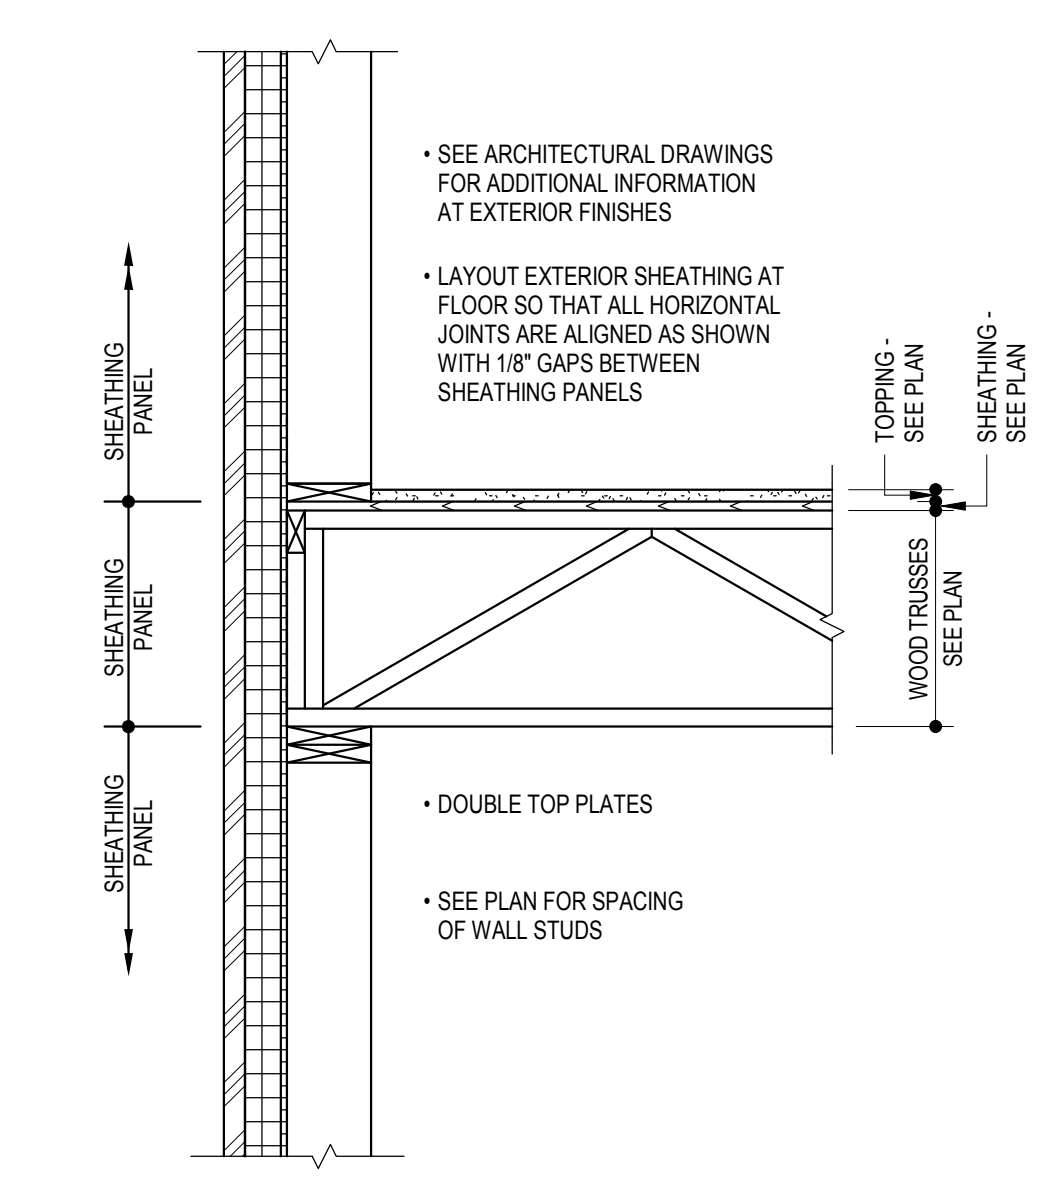
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ISSUE DATE:	04/28/17
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JOB NO.:	16072
DRAWN BY:	CRS


PROJECT DESIGN PHASE
50% CD SET
DRAWING NAME

FLOOR FRAMING DETAILS


DRAWING NUMBER
S3.04



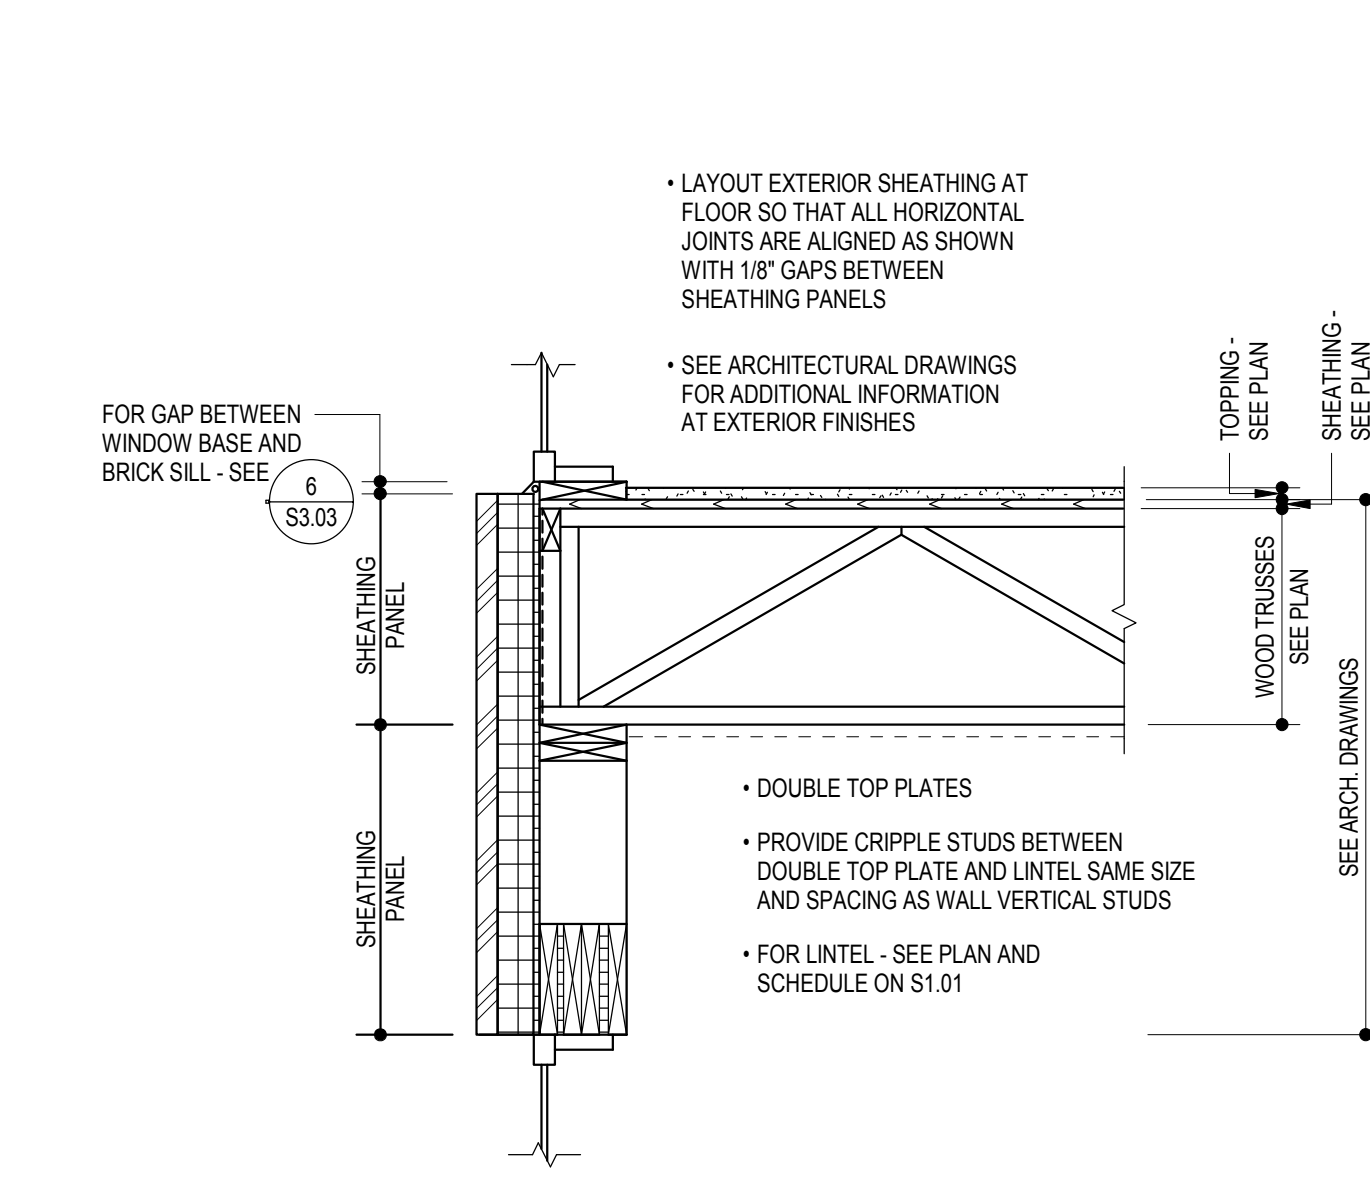
1 FLOOR TRUSSES BEARING AT EXTERIOR WALL WITH PANEL VENEER
3/4" = 1'-0"



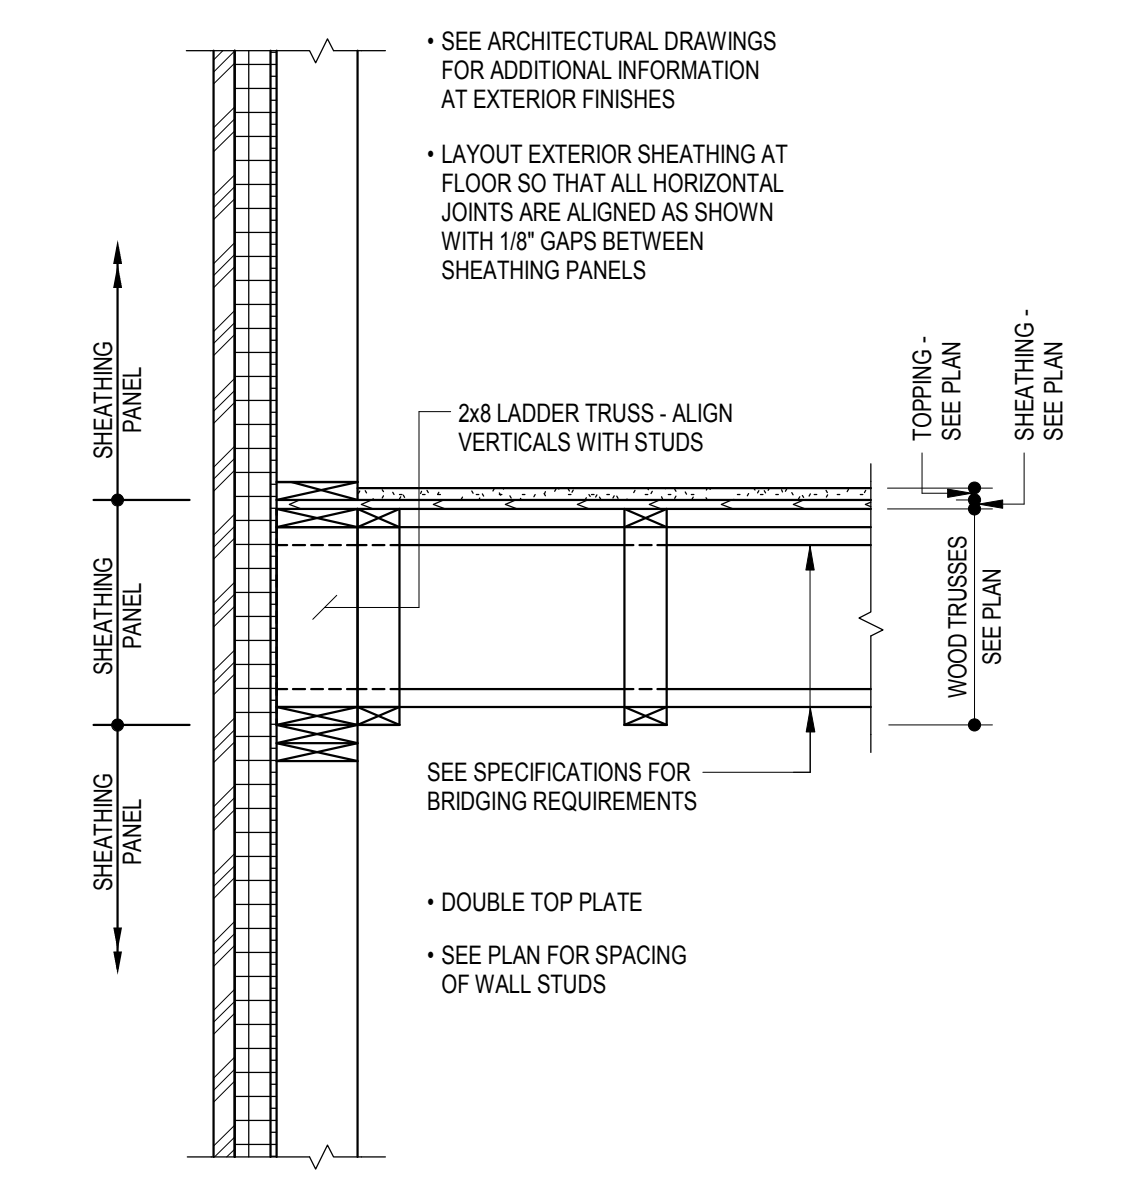
2 FLOOR TRUSSES BEARING AT EXTERIOR OPENING WITH PANEL VENEER
3/4" = 1'-0"



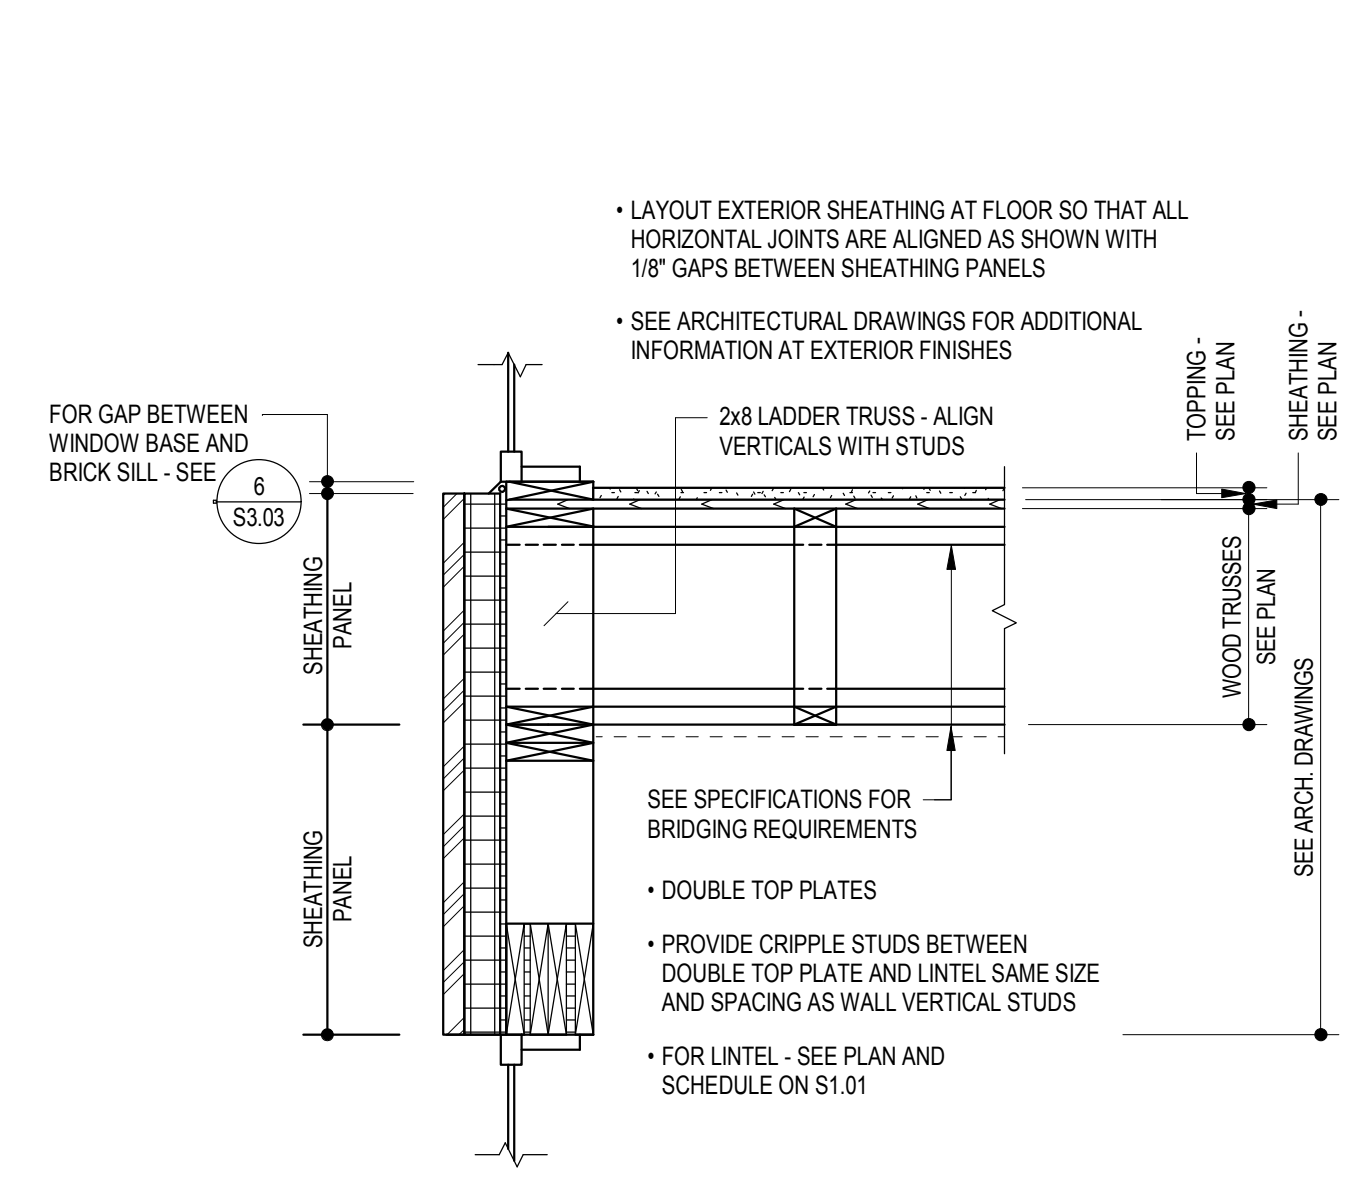
3 FLOOR TRUSSES PARALLEL TO EXTERIOR WALL WITH PANEL VENEER
3/4" = 1'-0"



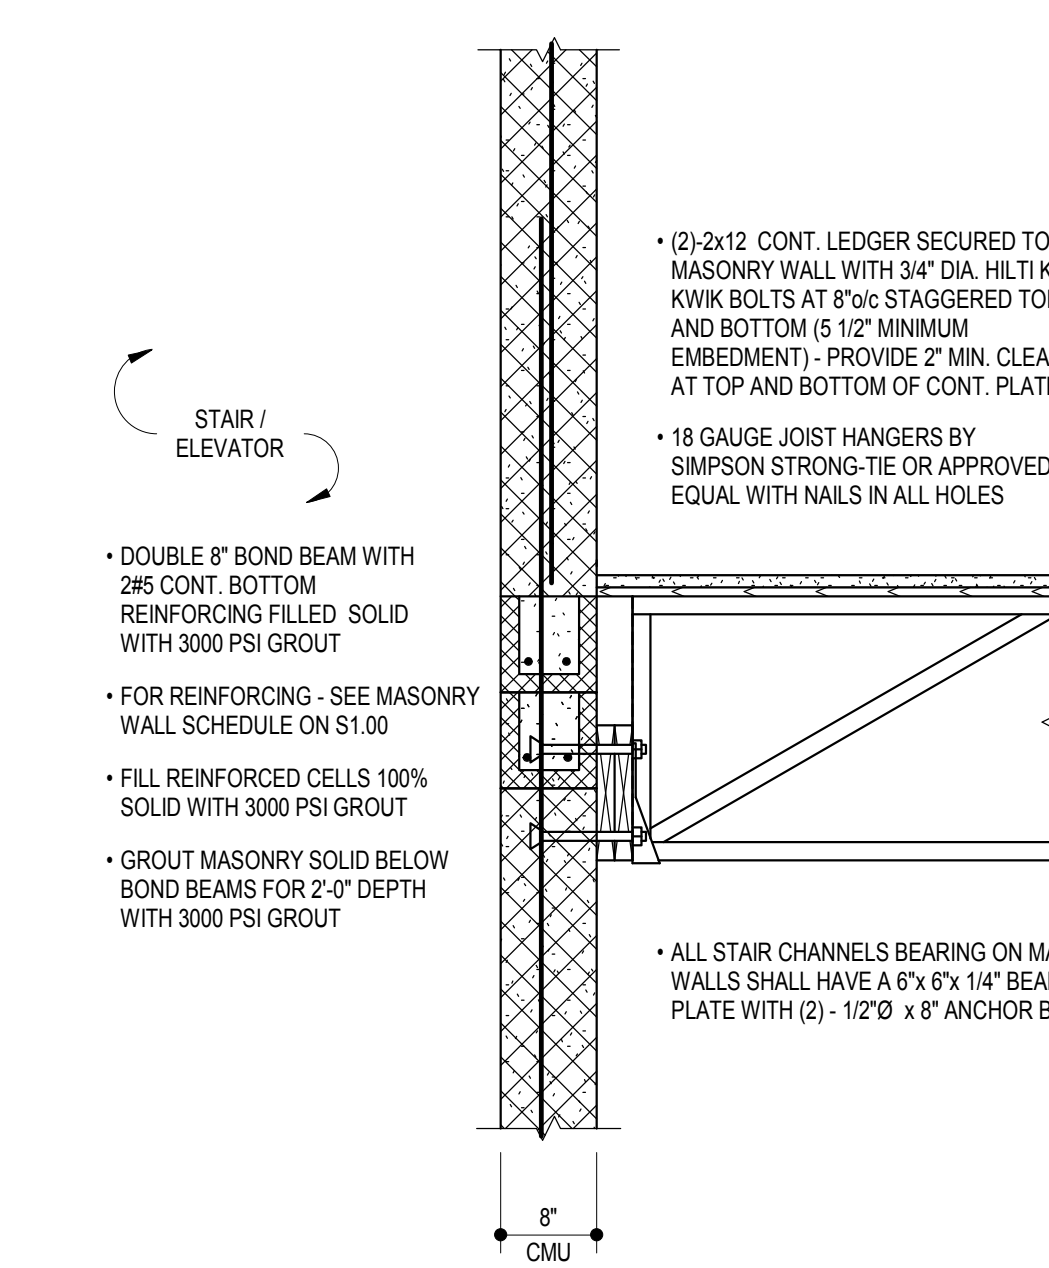
4 FLOOR TRUSSES PARALLEL TO EXTERIOR OPENING WITH PANEL VENEER
3/4" = 1'-0"



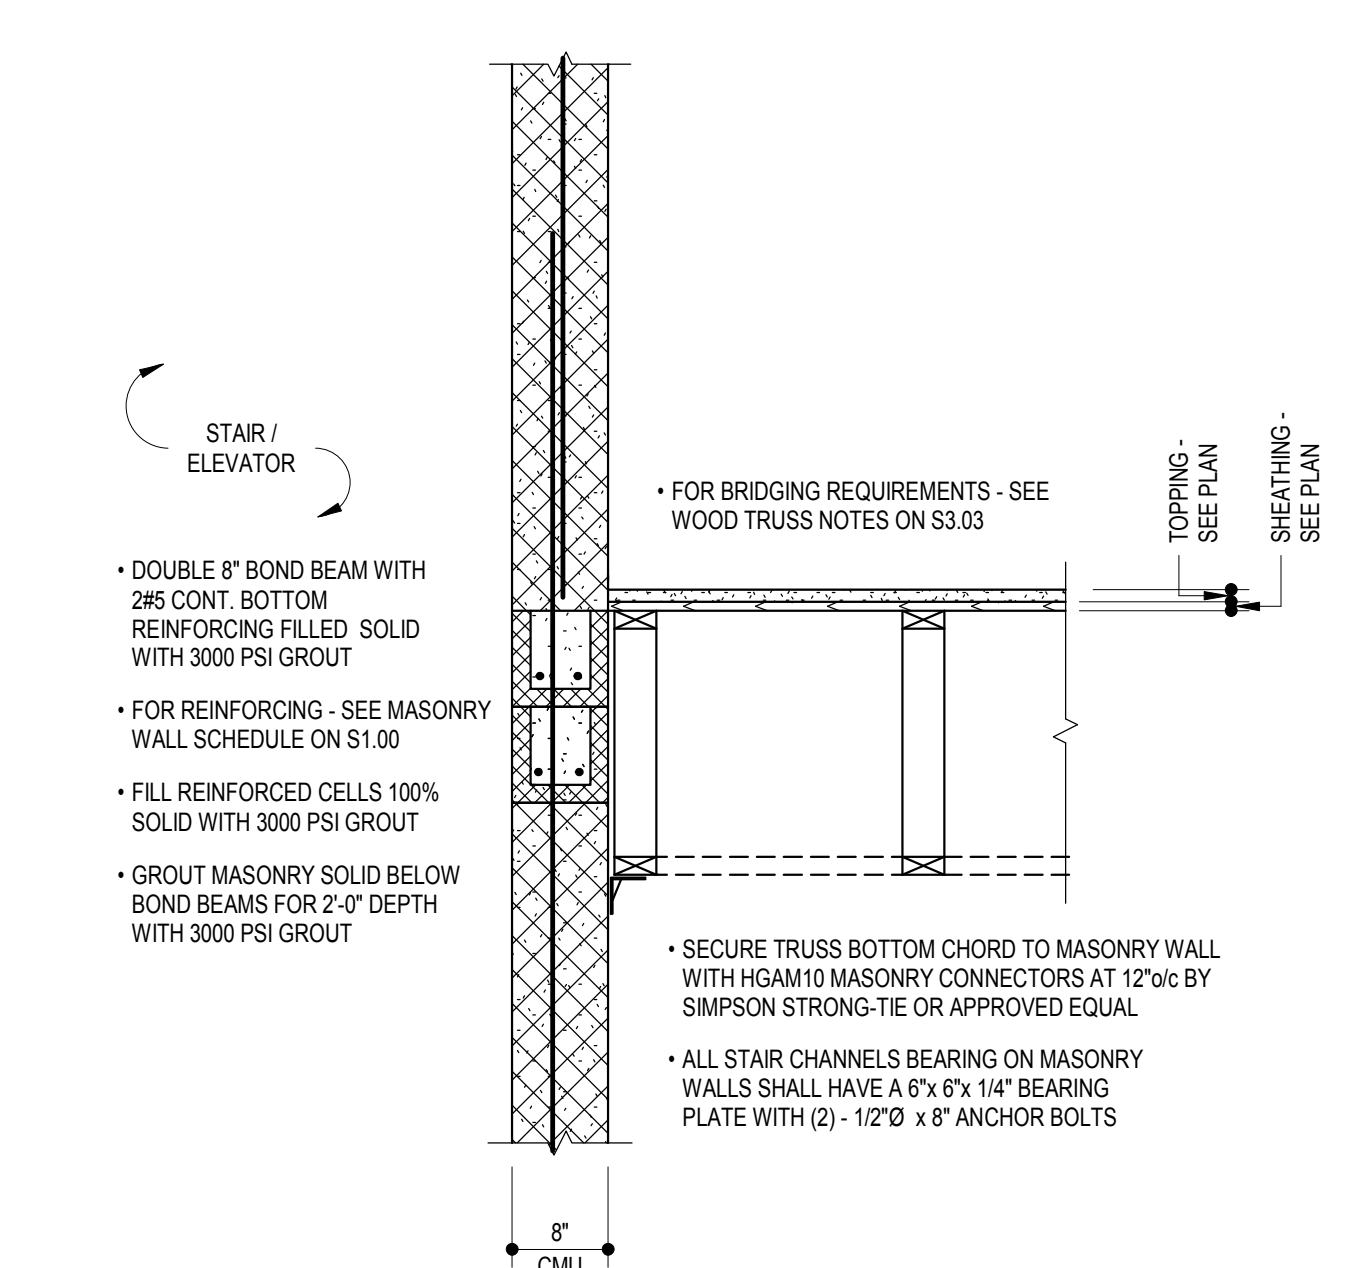
5 FLOOR TRUSS BEARING AT SHAFT WALL
3/4" = 1'-0"



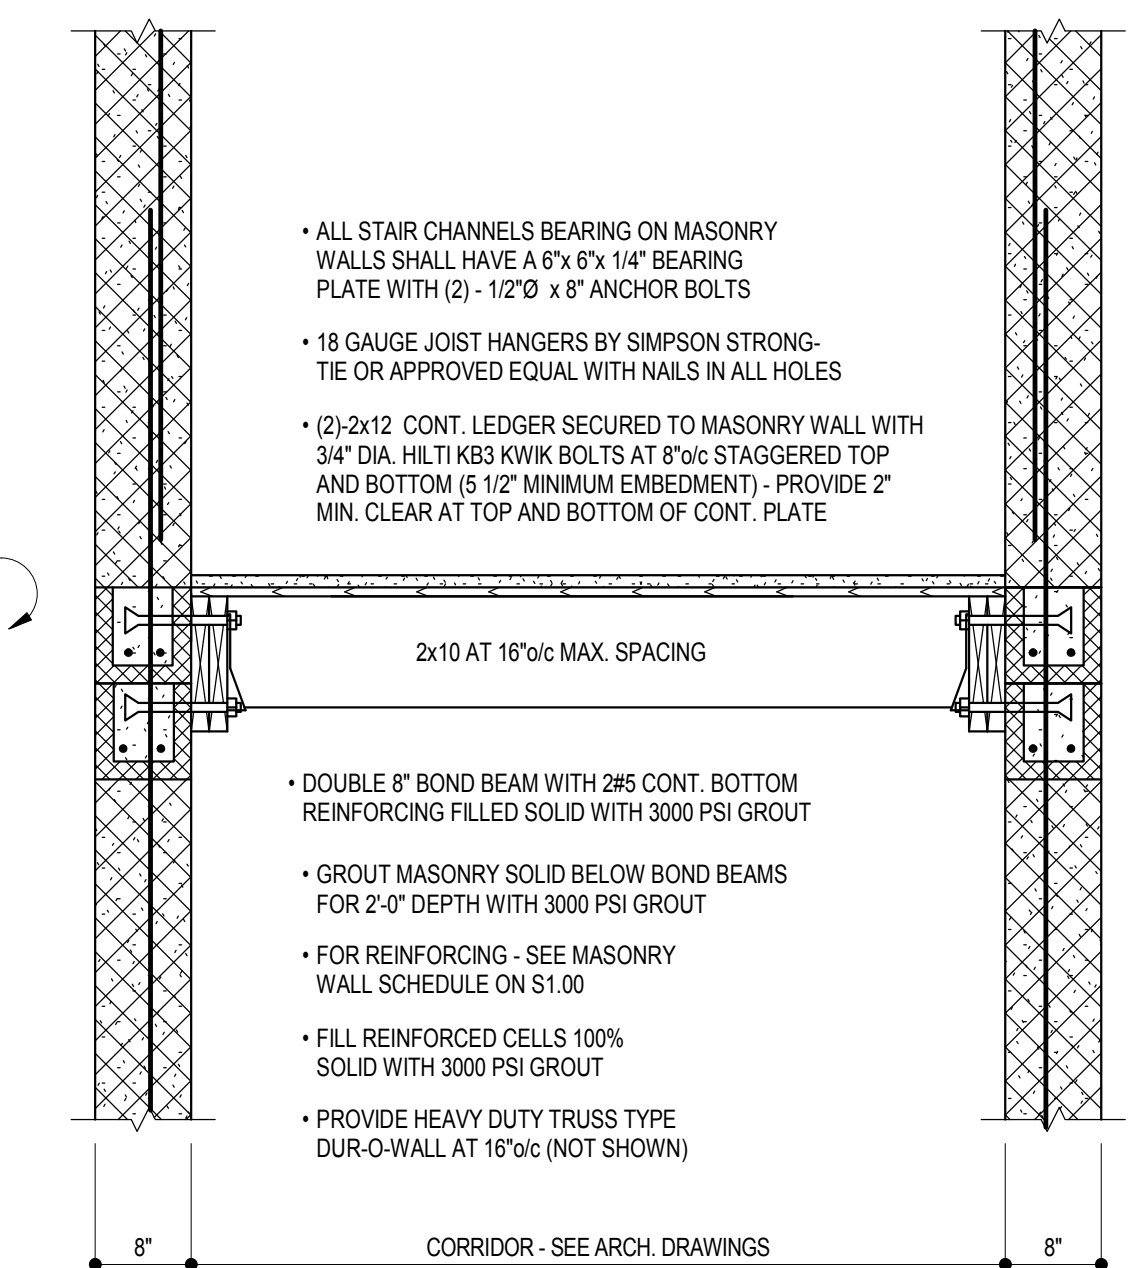
6 FLOOR TRUSS PARALLEL AT SHAFT WALL
3/4" = 1'-0"



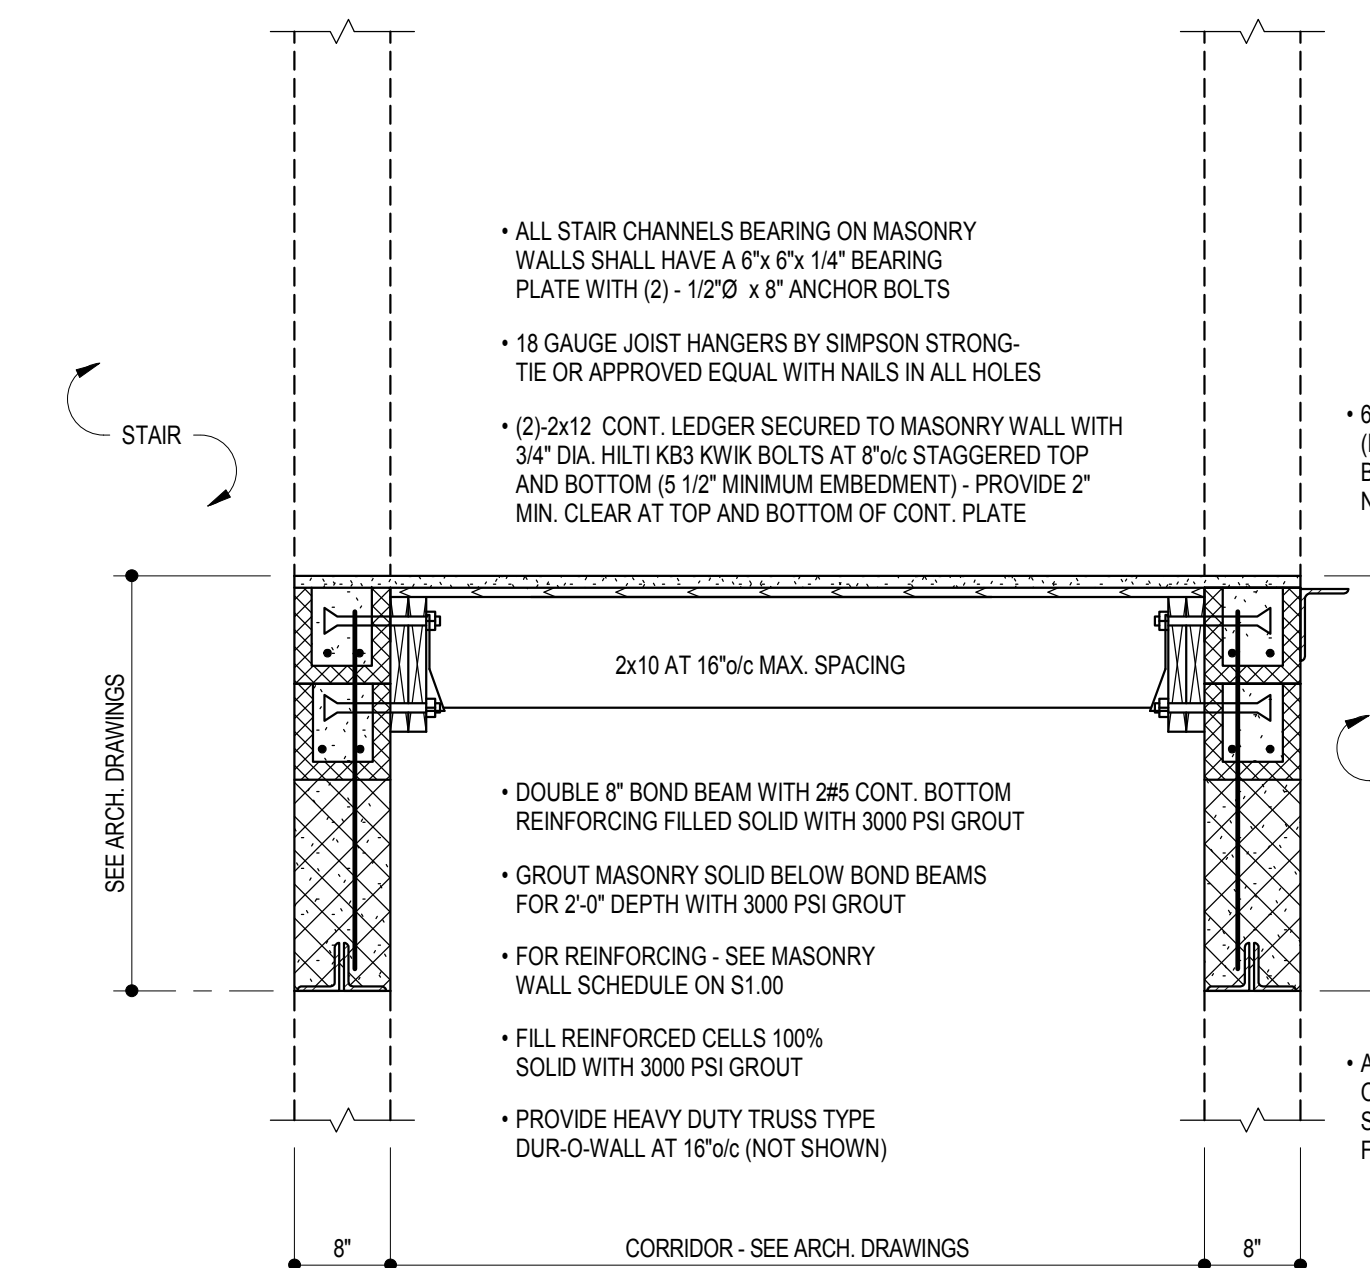7 FLOOR JOIST BEARING AT STAIR AND ELEVATOR
3/4" = 1'-0"



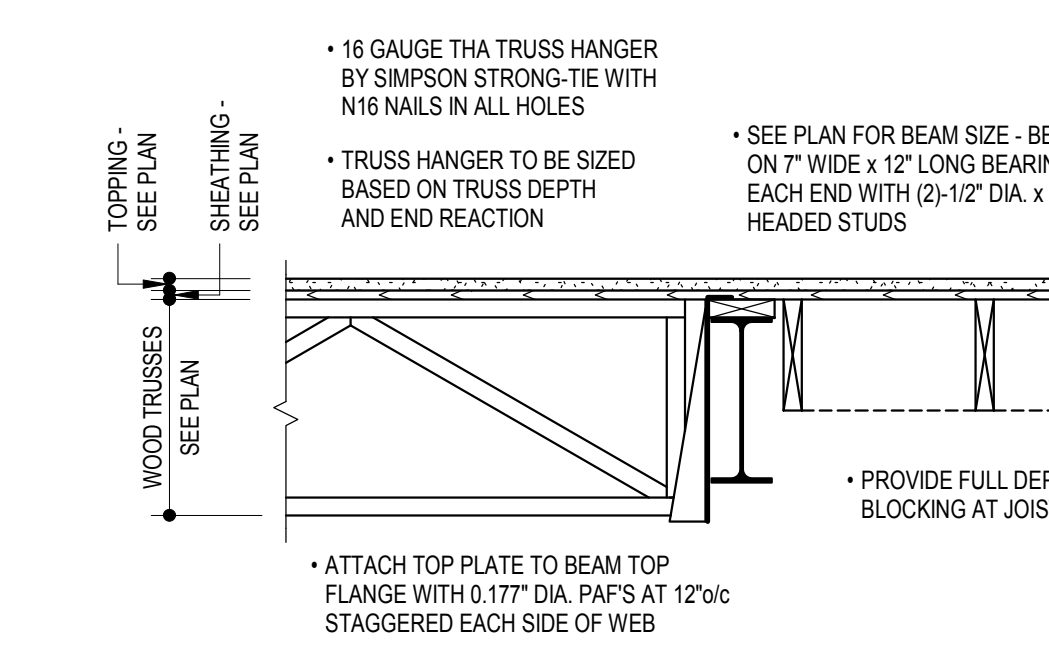8 FLOOR JOIST BEARING AT STAIR AND ELEVATOR DOOR
3/4" = 1'-0"




9 TRUSS BEARING AND JOISTS PARALLEL AT STEEL BEAM
3/4" = 1'-0"

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Table with 3 columns: REV. #, DESCRIPTION, DATE. Includes a section for REVISIONS and a KEY PLAN.



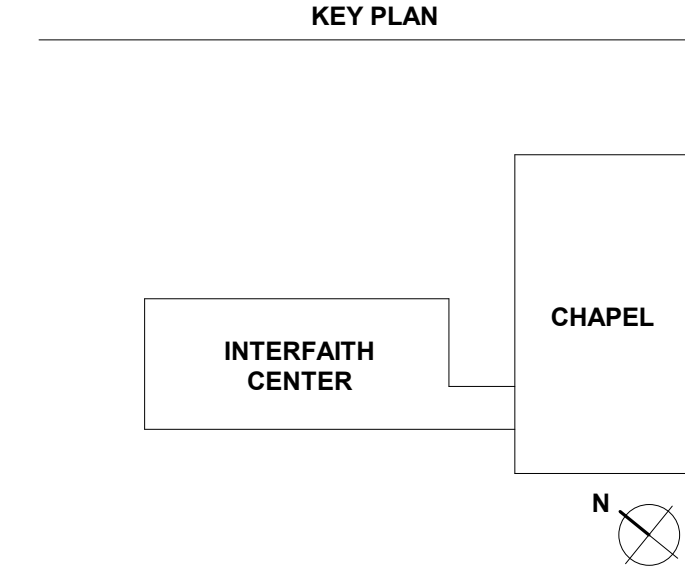ARCHITECTS + PLANNERS

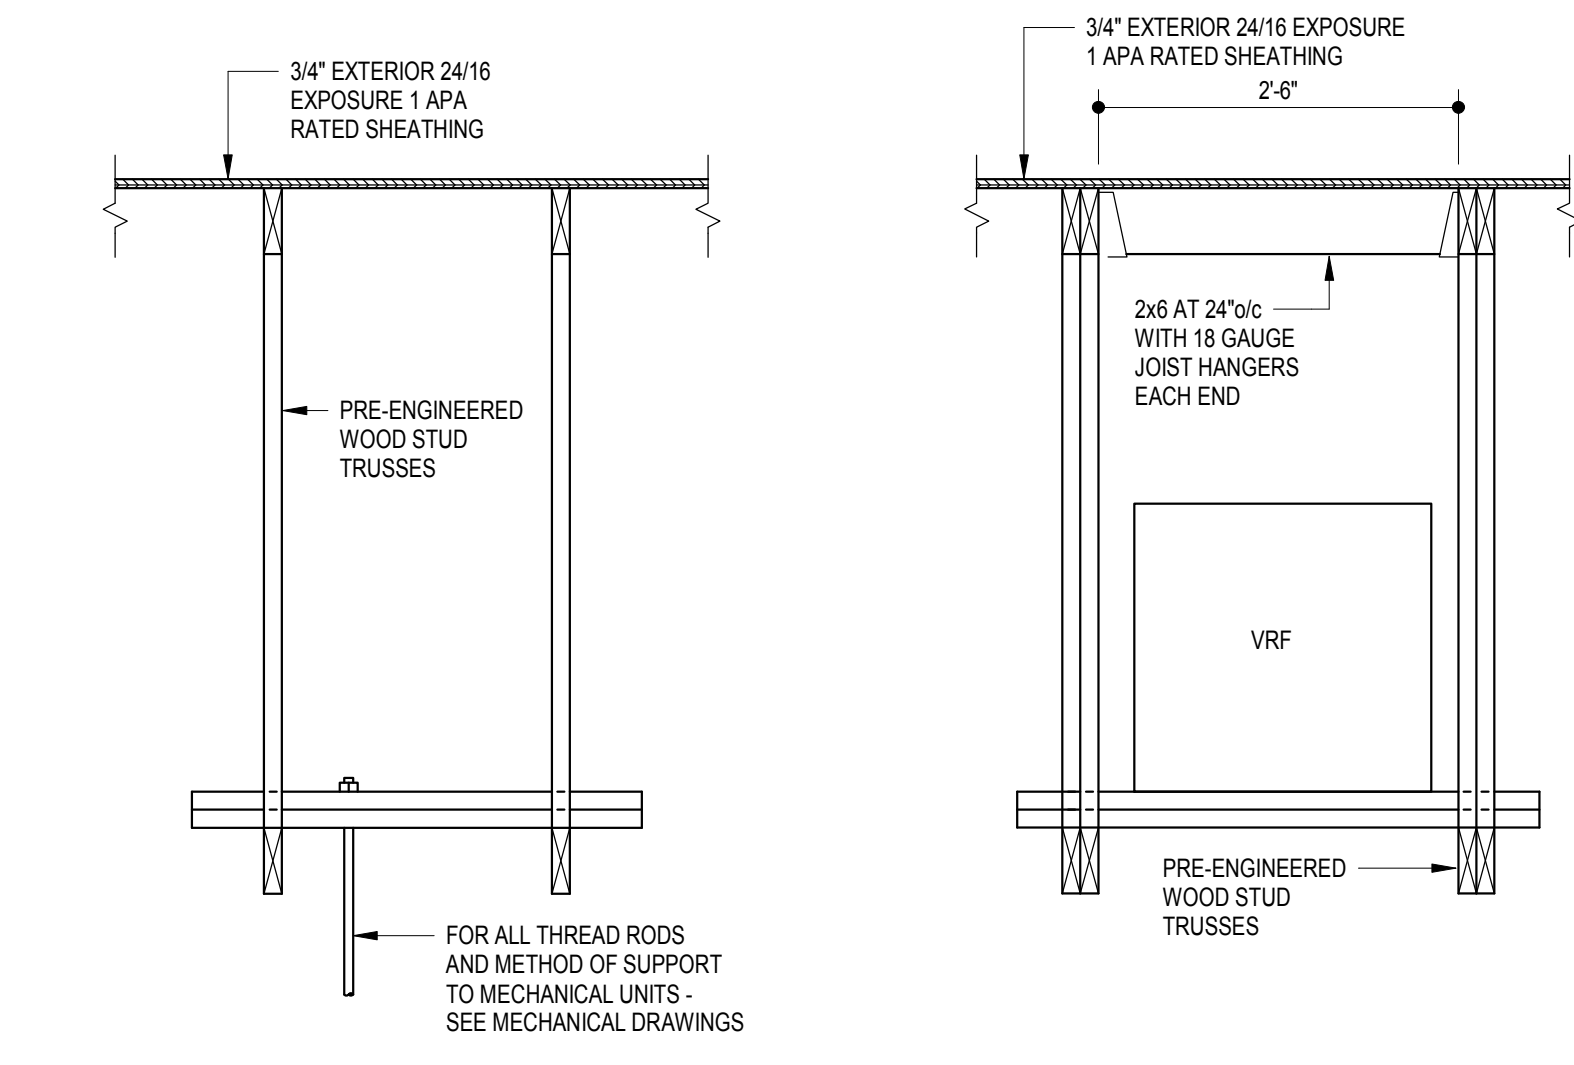
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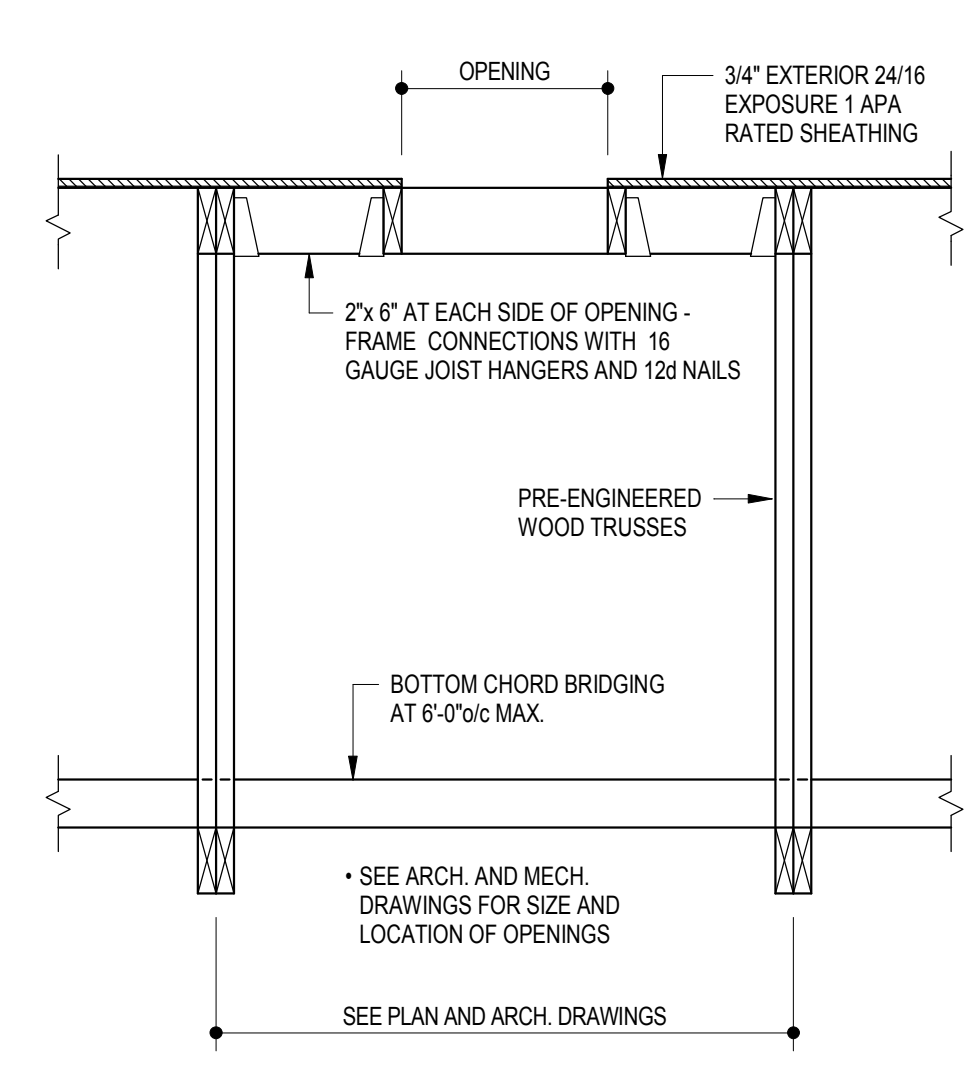
PROJECT DESIGN PHASE: 50% CD SET

DRAWING NAME: TYPICAL ROOF DETAILS

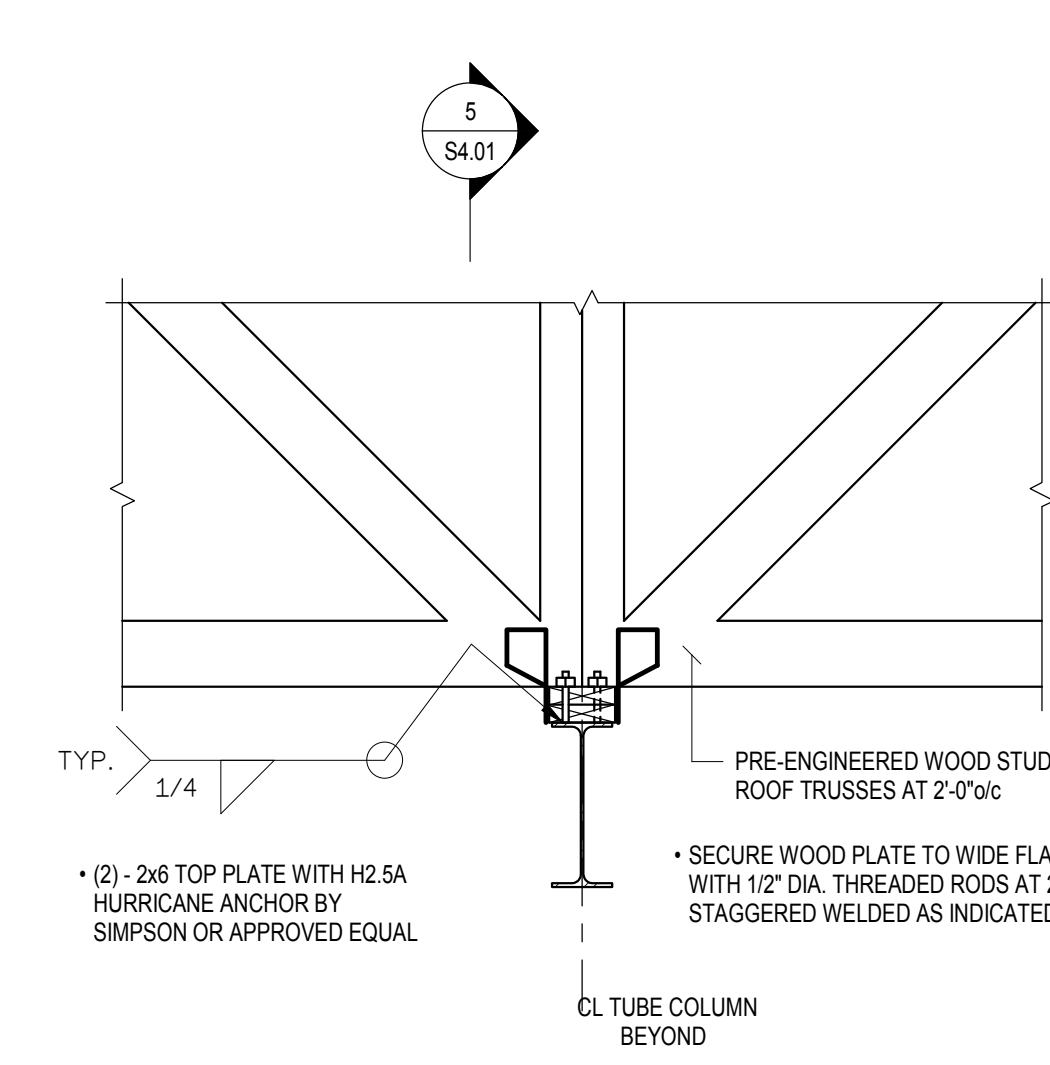
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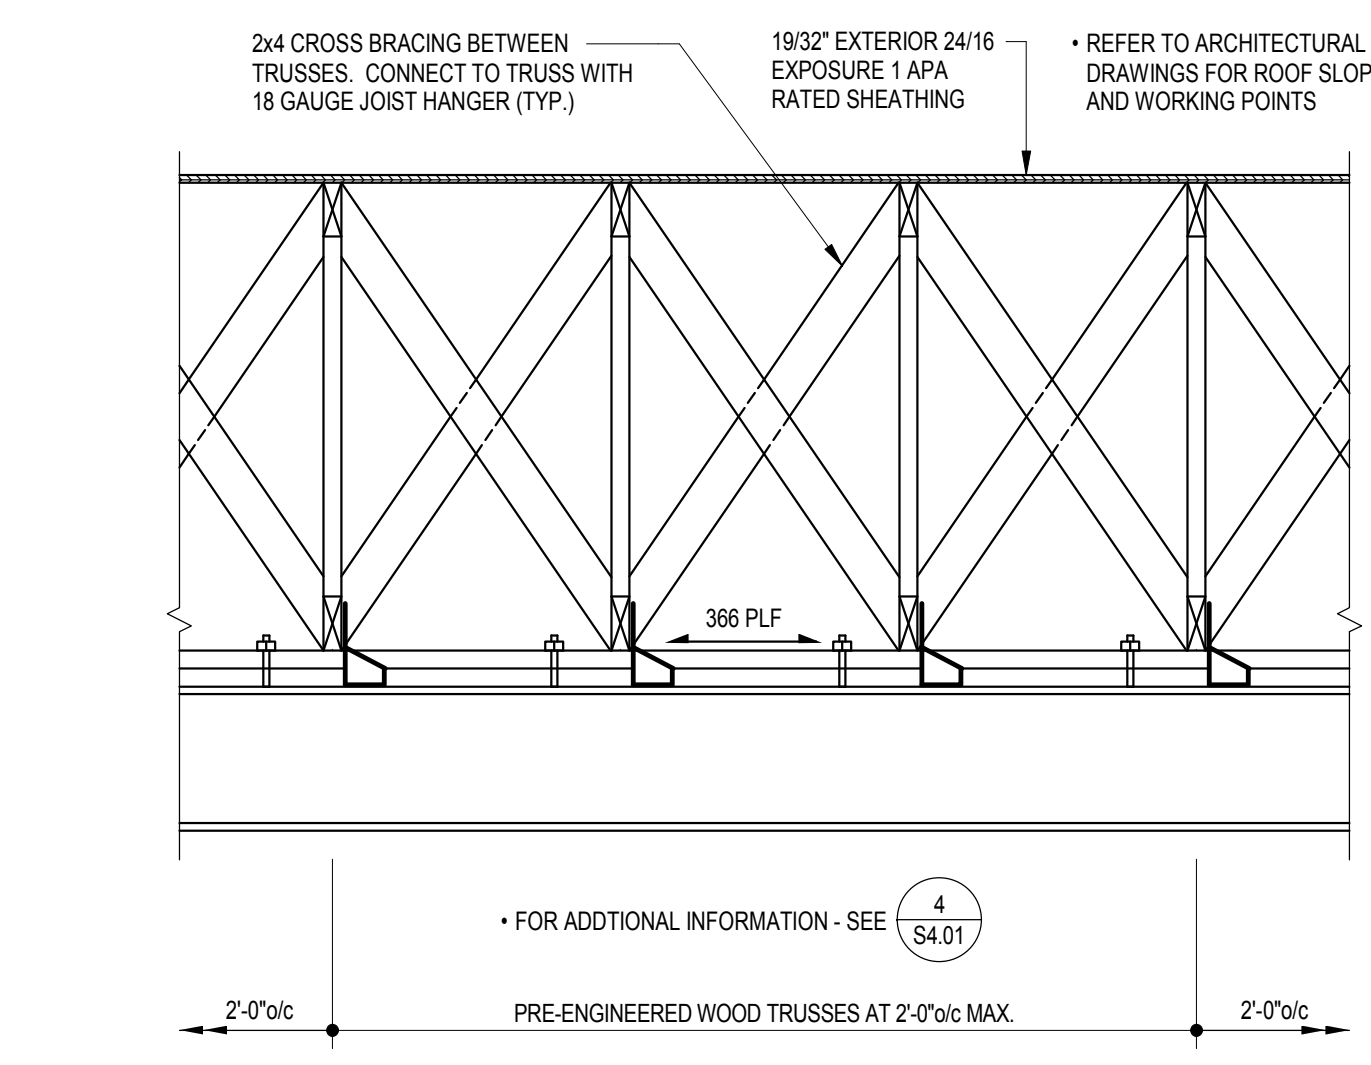
1 TYPICAL SUSPENDED MECHANICAL UNIT AT PWRT 3/4" x 1'-0"




2 TYPICAL VRF AT PWRT 3/4" x 1'-0"




3 ROOF OPENING DETAIL AT WOOD STUD 3/4" x 1'-0"



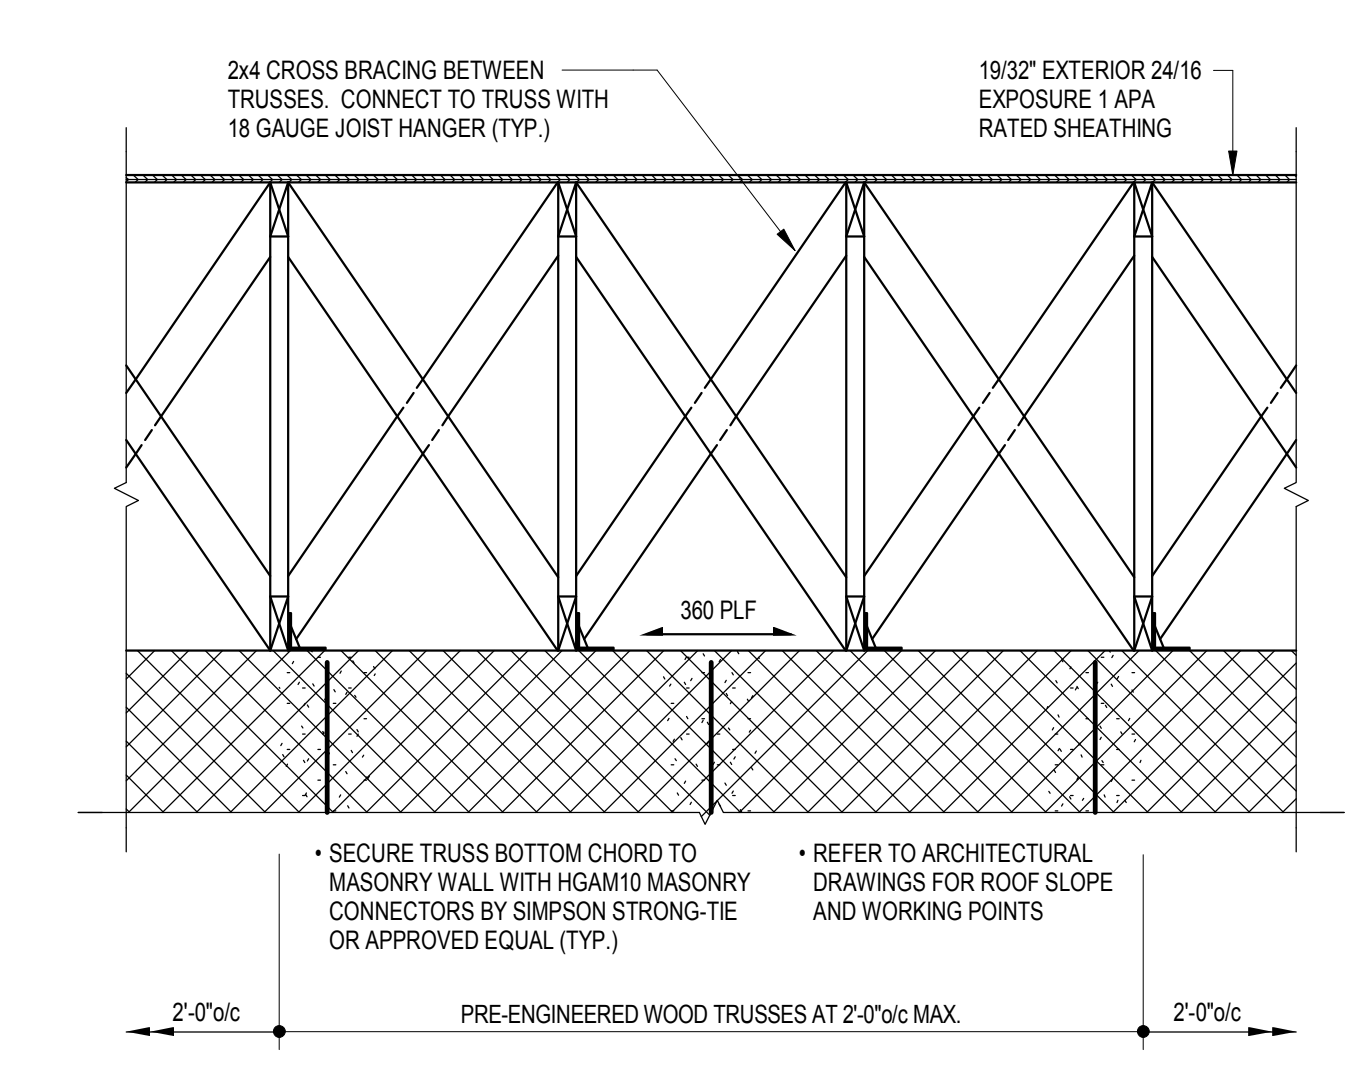
4 ROOF TRUSS BEARING AT MOMENT FRAME 3/4" x 1'-0"



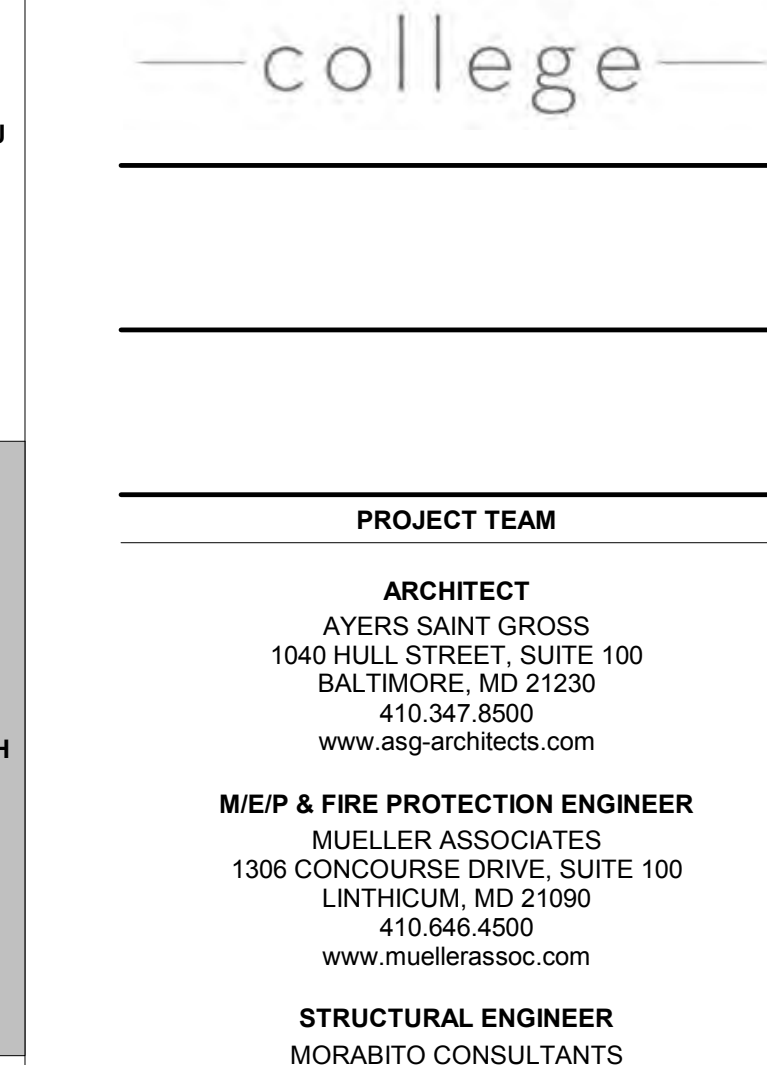5 CROSS BRACING AT MOMENT FRAME 3/4" x 1'-0"



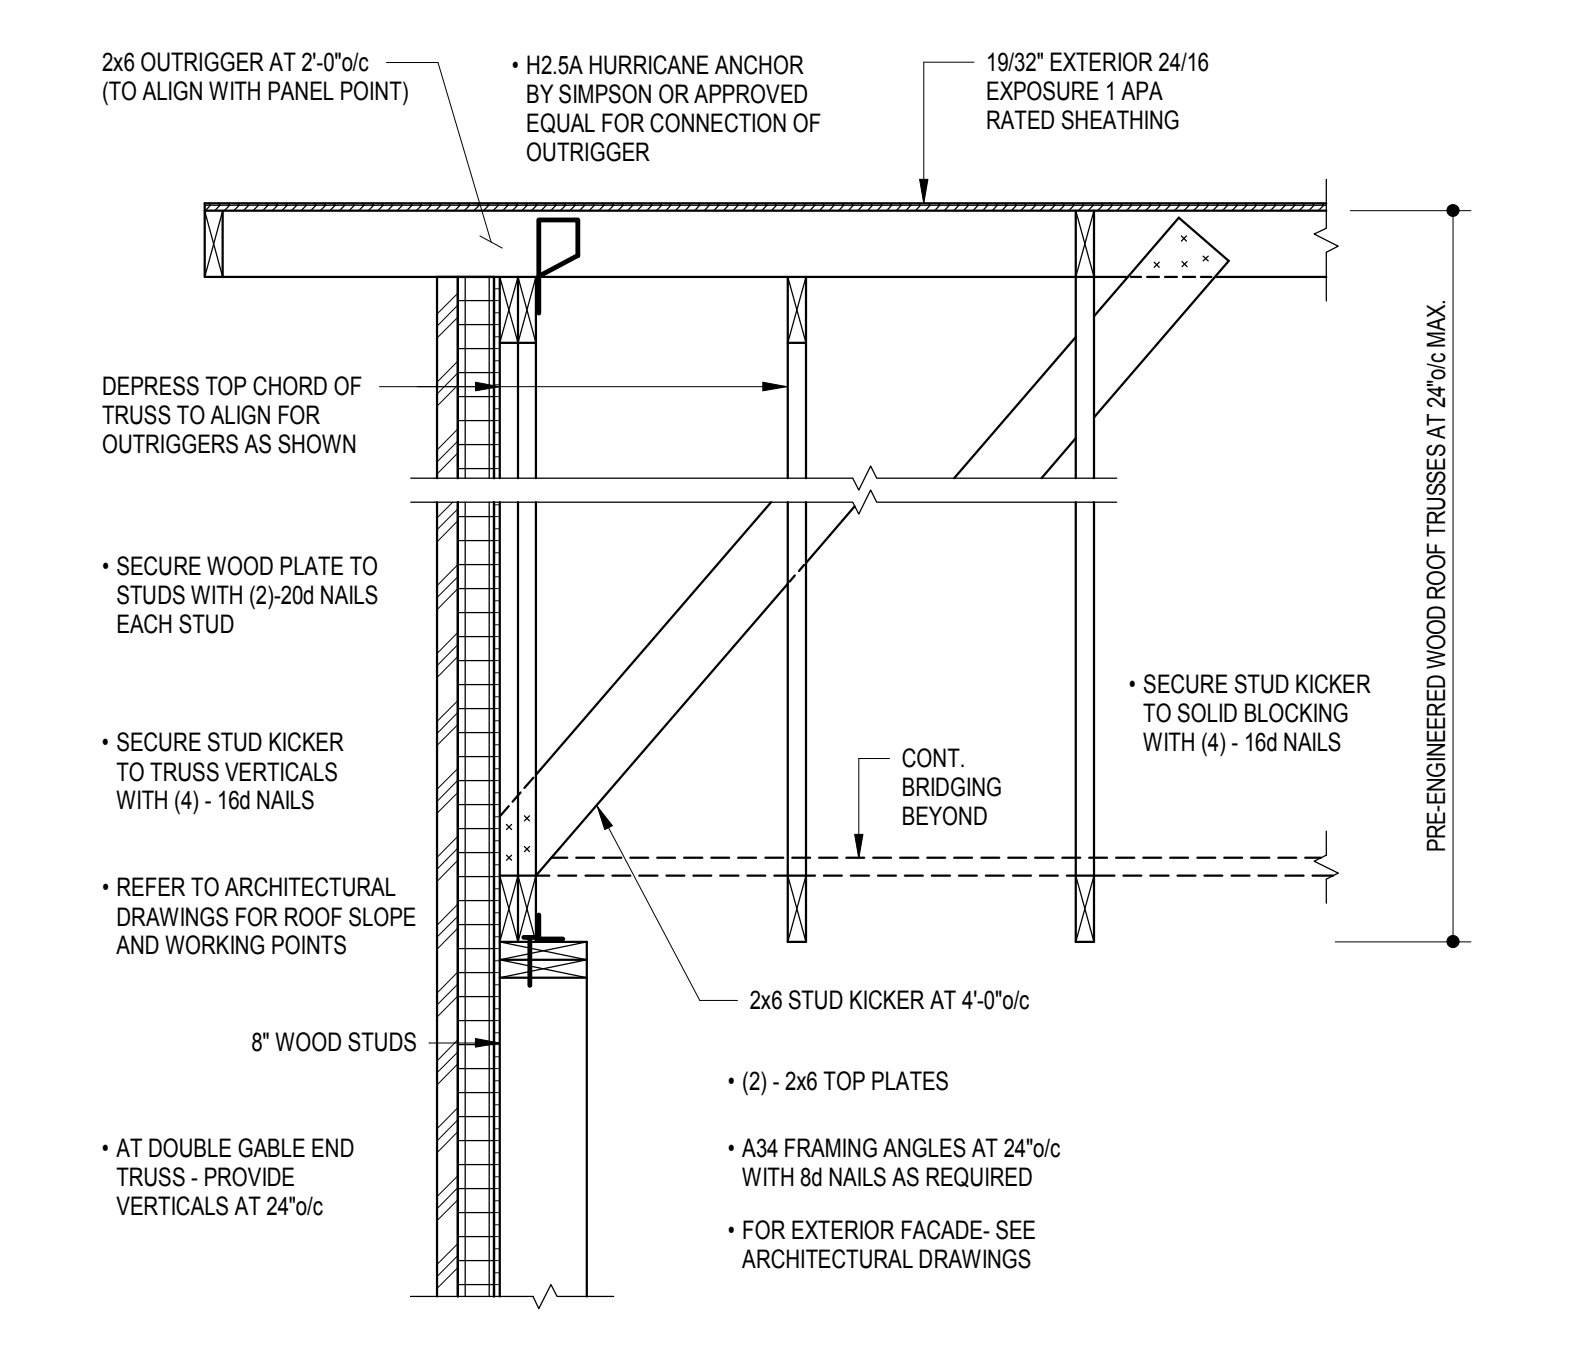6 CROSS BRACING AT MASONRY SHEAR WALL 3/4" x 1'-0"



7 GABLE END 3/4" x 1'-0"

ROOF TRUSS NOTES:


- 1. STRUCTURAL ROOF SHALL BE 3/4" EXTERIOR 24/16 EXPOSURE 1 APA RATED PL WOOD SHEATHING OVER WOOD TRUSSES AT 34" MAX.
2. SEE ARCHITECTURAL DRAWINGS FOR WORKING POINTS AND PITCHES OF PREFABRICATED WOOD ROOF TRUSSES.
3. CONTRACTOR TO PROVIDE ALL REQUIRED BRACING FOR WOOD TRUSSES ROOF TRUSSES IN ACCORDANCE WITH "BUILDING COMPONENT SAFETY INFORMATION" (BCSI-2006) AS PUBLISHED BY THE TRUSS PLATE INSTITUTE. (NOT SHOWN).
4. PRE-ENGINEERED WOOD ROOF TRUSSES SHALL BE DESIGNED FOR THE FOLLOWING UNIFORMED LOADS (U.N.O.):
LIVE LOAD: A) TOP CHORD = 30 PSF*, B) BOTTOM CHORD = 0 PSF (TYP.)
DEAD LOAD: A) TOP CHORD = 15 PSF, B) BOTTOM CHORD = 10 PSF*
WIND LOAD: 115 MPH PER IBC 2015
* IN ADDITION, ALL TRUSSES SHALL BE DESIGNED FOR SNOW DRIFT PER THE REQUIREMENTS OF IBC 2015. TRUSSES SHALL ALSO BE DESIGNED TO SUPPORT ALL MECHANICAL EQUIPMENT.
5. FIELD VERIFY ALL TRUSS DIMENSIONS PRIOR TO FABRICATION.
6. TOP CHORD OF ALL WOOD ROOF TRUSSES SHALL BE DESIGNED FOR ALL AXIAL AND BENDING STRESSES.
7. CONTRACTOR SHALL COORDINATE TRUSS WEB MEMBERS WITH MECHANICAL DUCTWORK AND MECHANICAL AND ELECTRICAL EQUIPMENT.
8. IF SEPARATE OR PIGGY BACK TRUSSES ARE DEEMED NECESSARY BY THE CONTRACTOR DUE TO SHIPPING AND HANDLING, ANY ADDITIONAL COST SHALL BE THE RESPONSIBILITY OF THE CONTRACTOR.
9. TRUSSES SHALL ALSO BE DESIGNED FOR WIND UPLIFT FORCES.
10. CONTRACTOR SHALL SUPPLY AND DESIGN ALL TRUSS CONNECTIONS AS REQUIRED.
11. CONTRACTOR SHALL ALSO SUPPLY AND DESIGN CONNECTIONS OF ALL TRUSS TO STRUCTURAL COLD FORMED METAL STUD WALLS, BEAMS, SLABS, STEEL FRAME, ETC. AS NECESSARY.
12. WHERE INDICATED ON PLAN, ROOF TRUSSES SHALL BE DESIGNED FOR AN INCREASED TOP CHORD LIVE LOAD.
13. VAULTED CEILINGS SHALL BE PROVIDED WHERE INDICATED ON PLAN. BOTTOM CHORD OF ROOF TRUSSES SHALL BE STEPPED AS REQUIRED TO FRAME THE VAULT. SEE ARCHITECTURAL DRAWINGS FOR EXACT SIZE AND LOCATION OF VAULTS.

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KEY PLAN



ARCHITECTS + PLANNERS


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50% CD SET

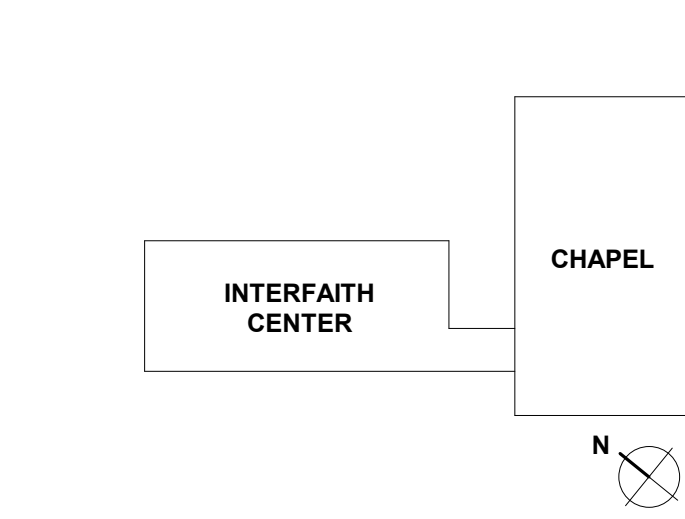ROOF DETAILS

DRAWING NUMBER S4.02




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REVISIONS		
REV. #	DESCRIPTION	DATE

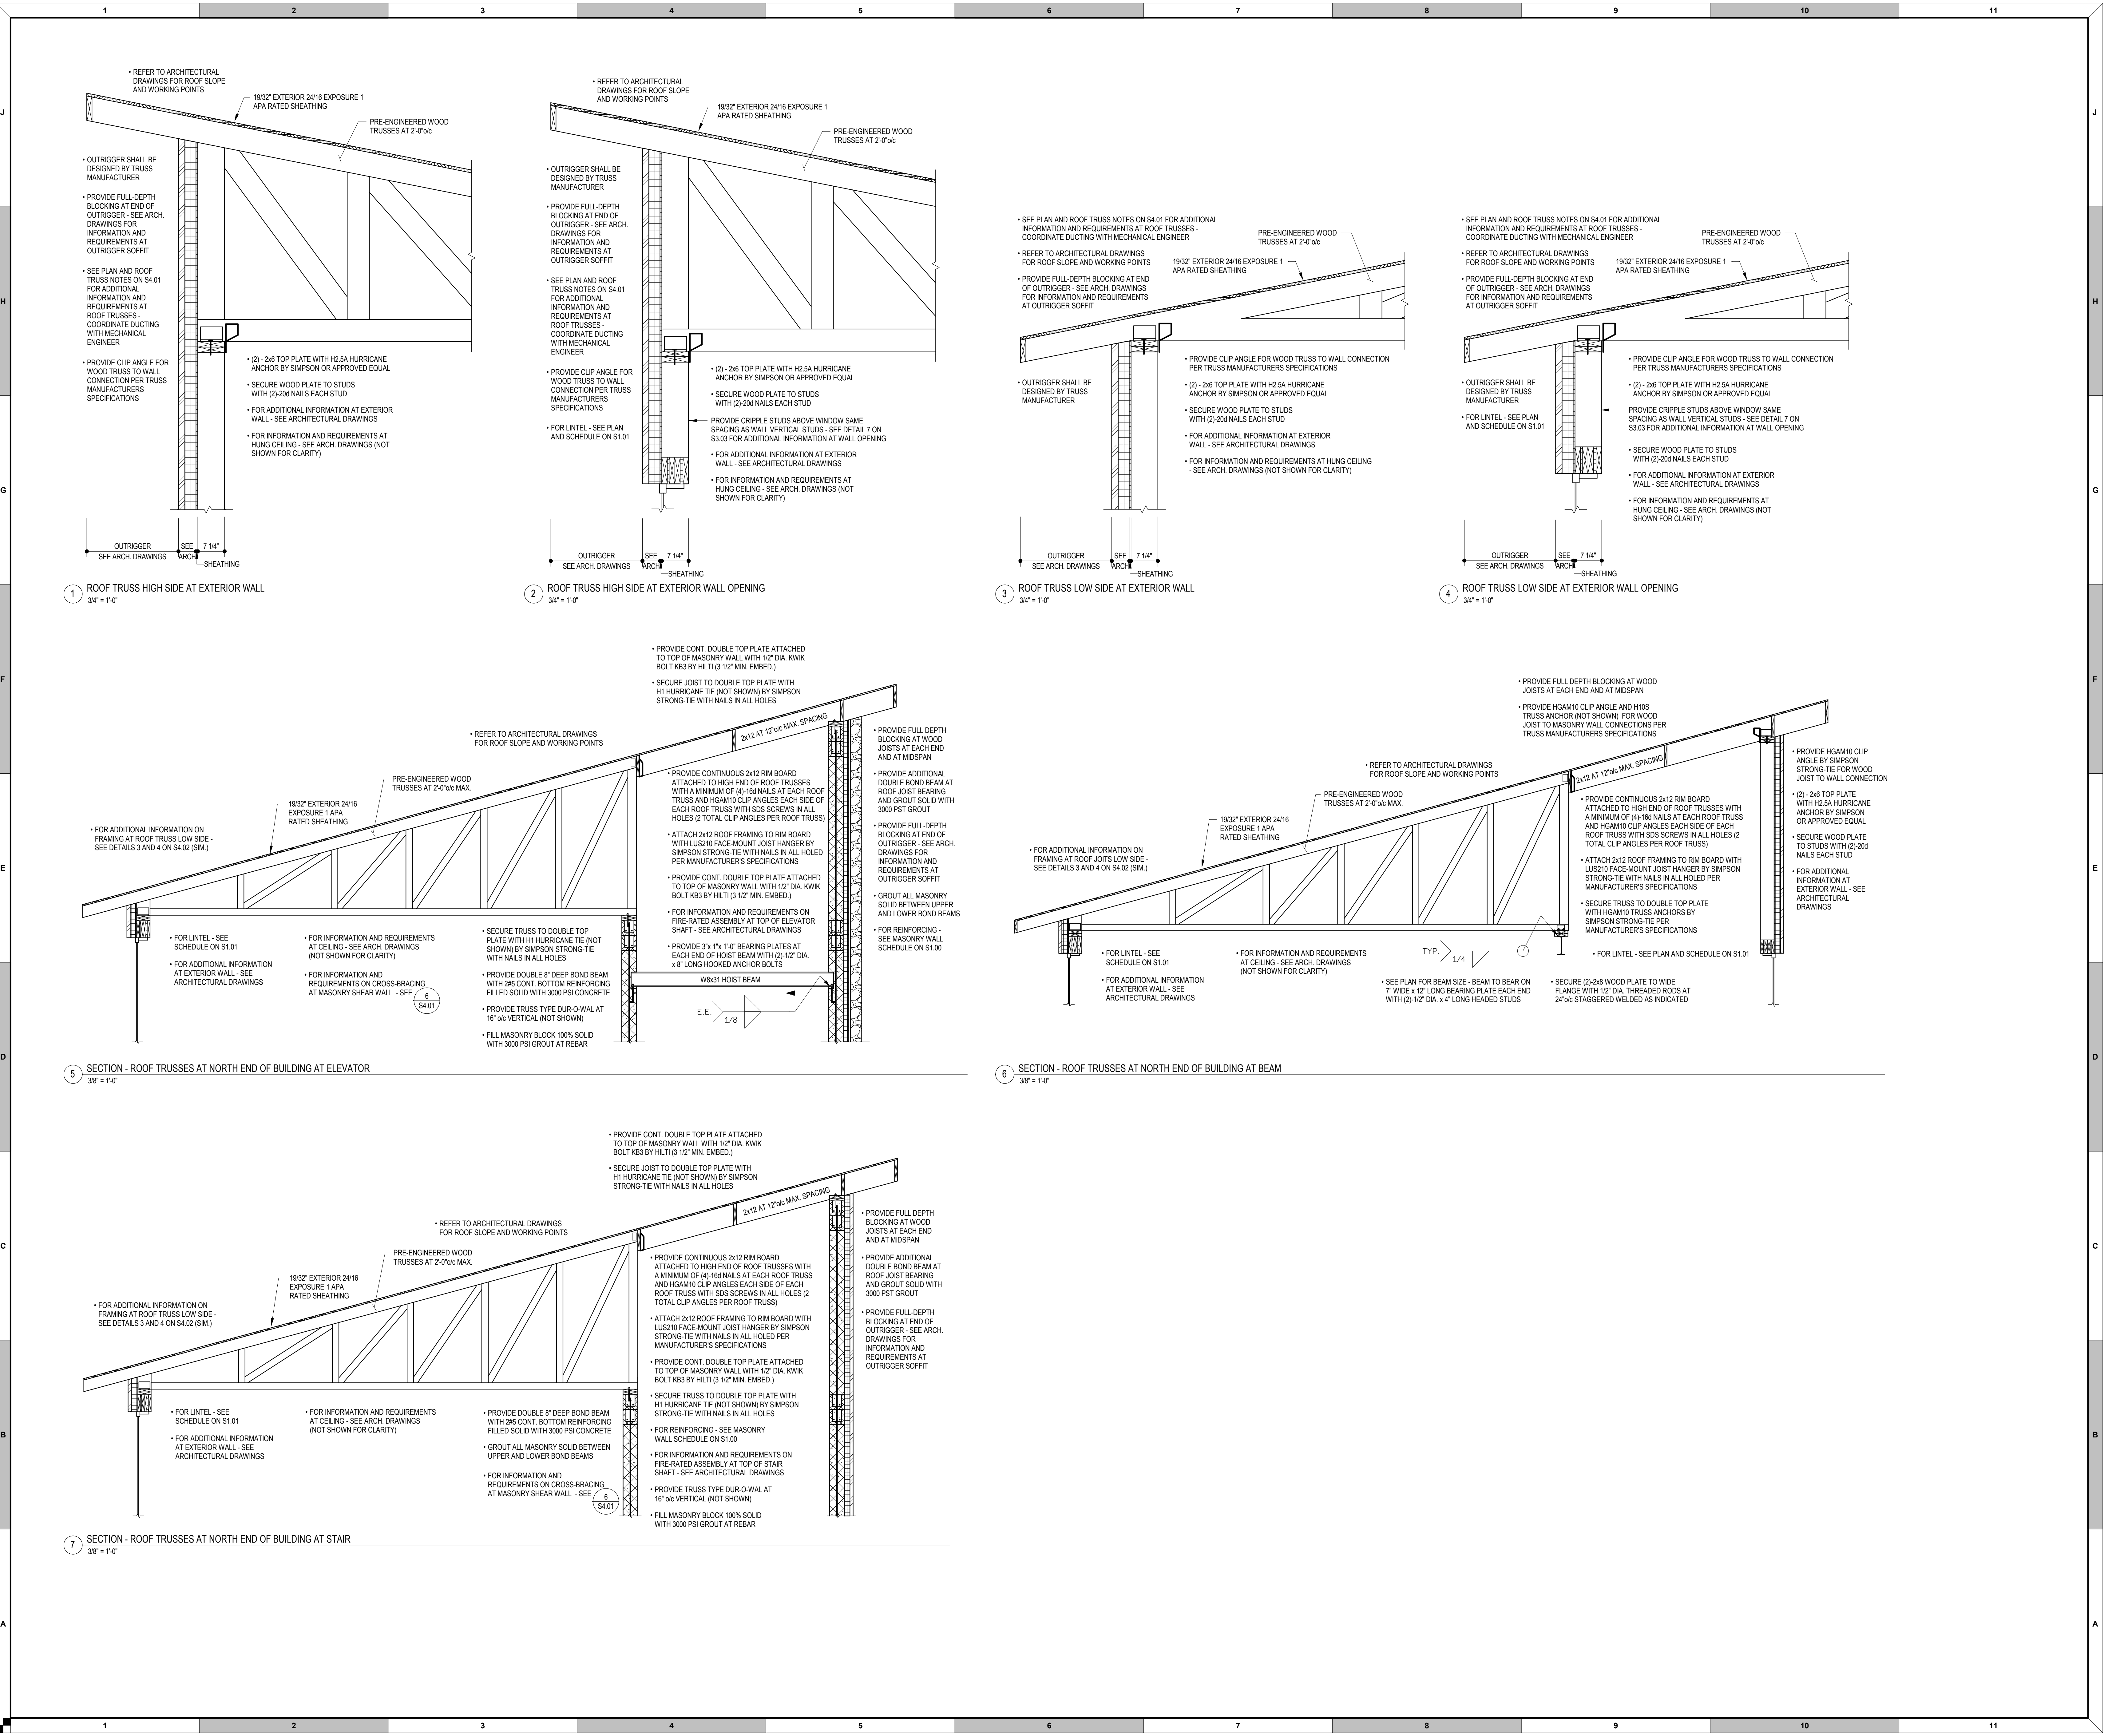KEY PLAN



ARCHITECTS + PLANNERS


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DRAWING INFORMATION	
ISSUE DATE:	04/28/17
SCALE:	3/8" = 1'-0"
JOB NO.:	16072
DRAWN BY:	CRS

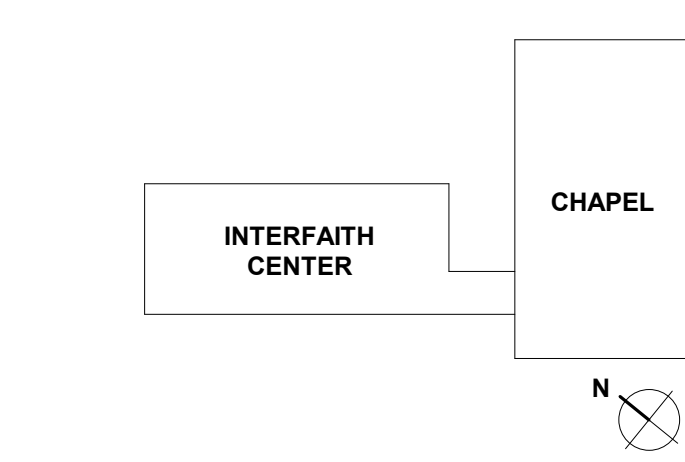PROJECT DESIGN PHASE
50% CD SET
DRAWING NAME

ROOF DETAILS


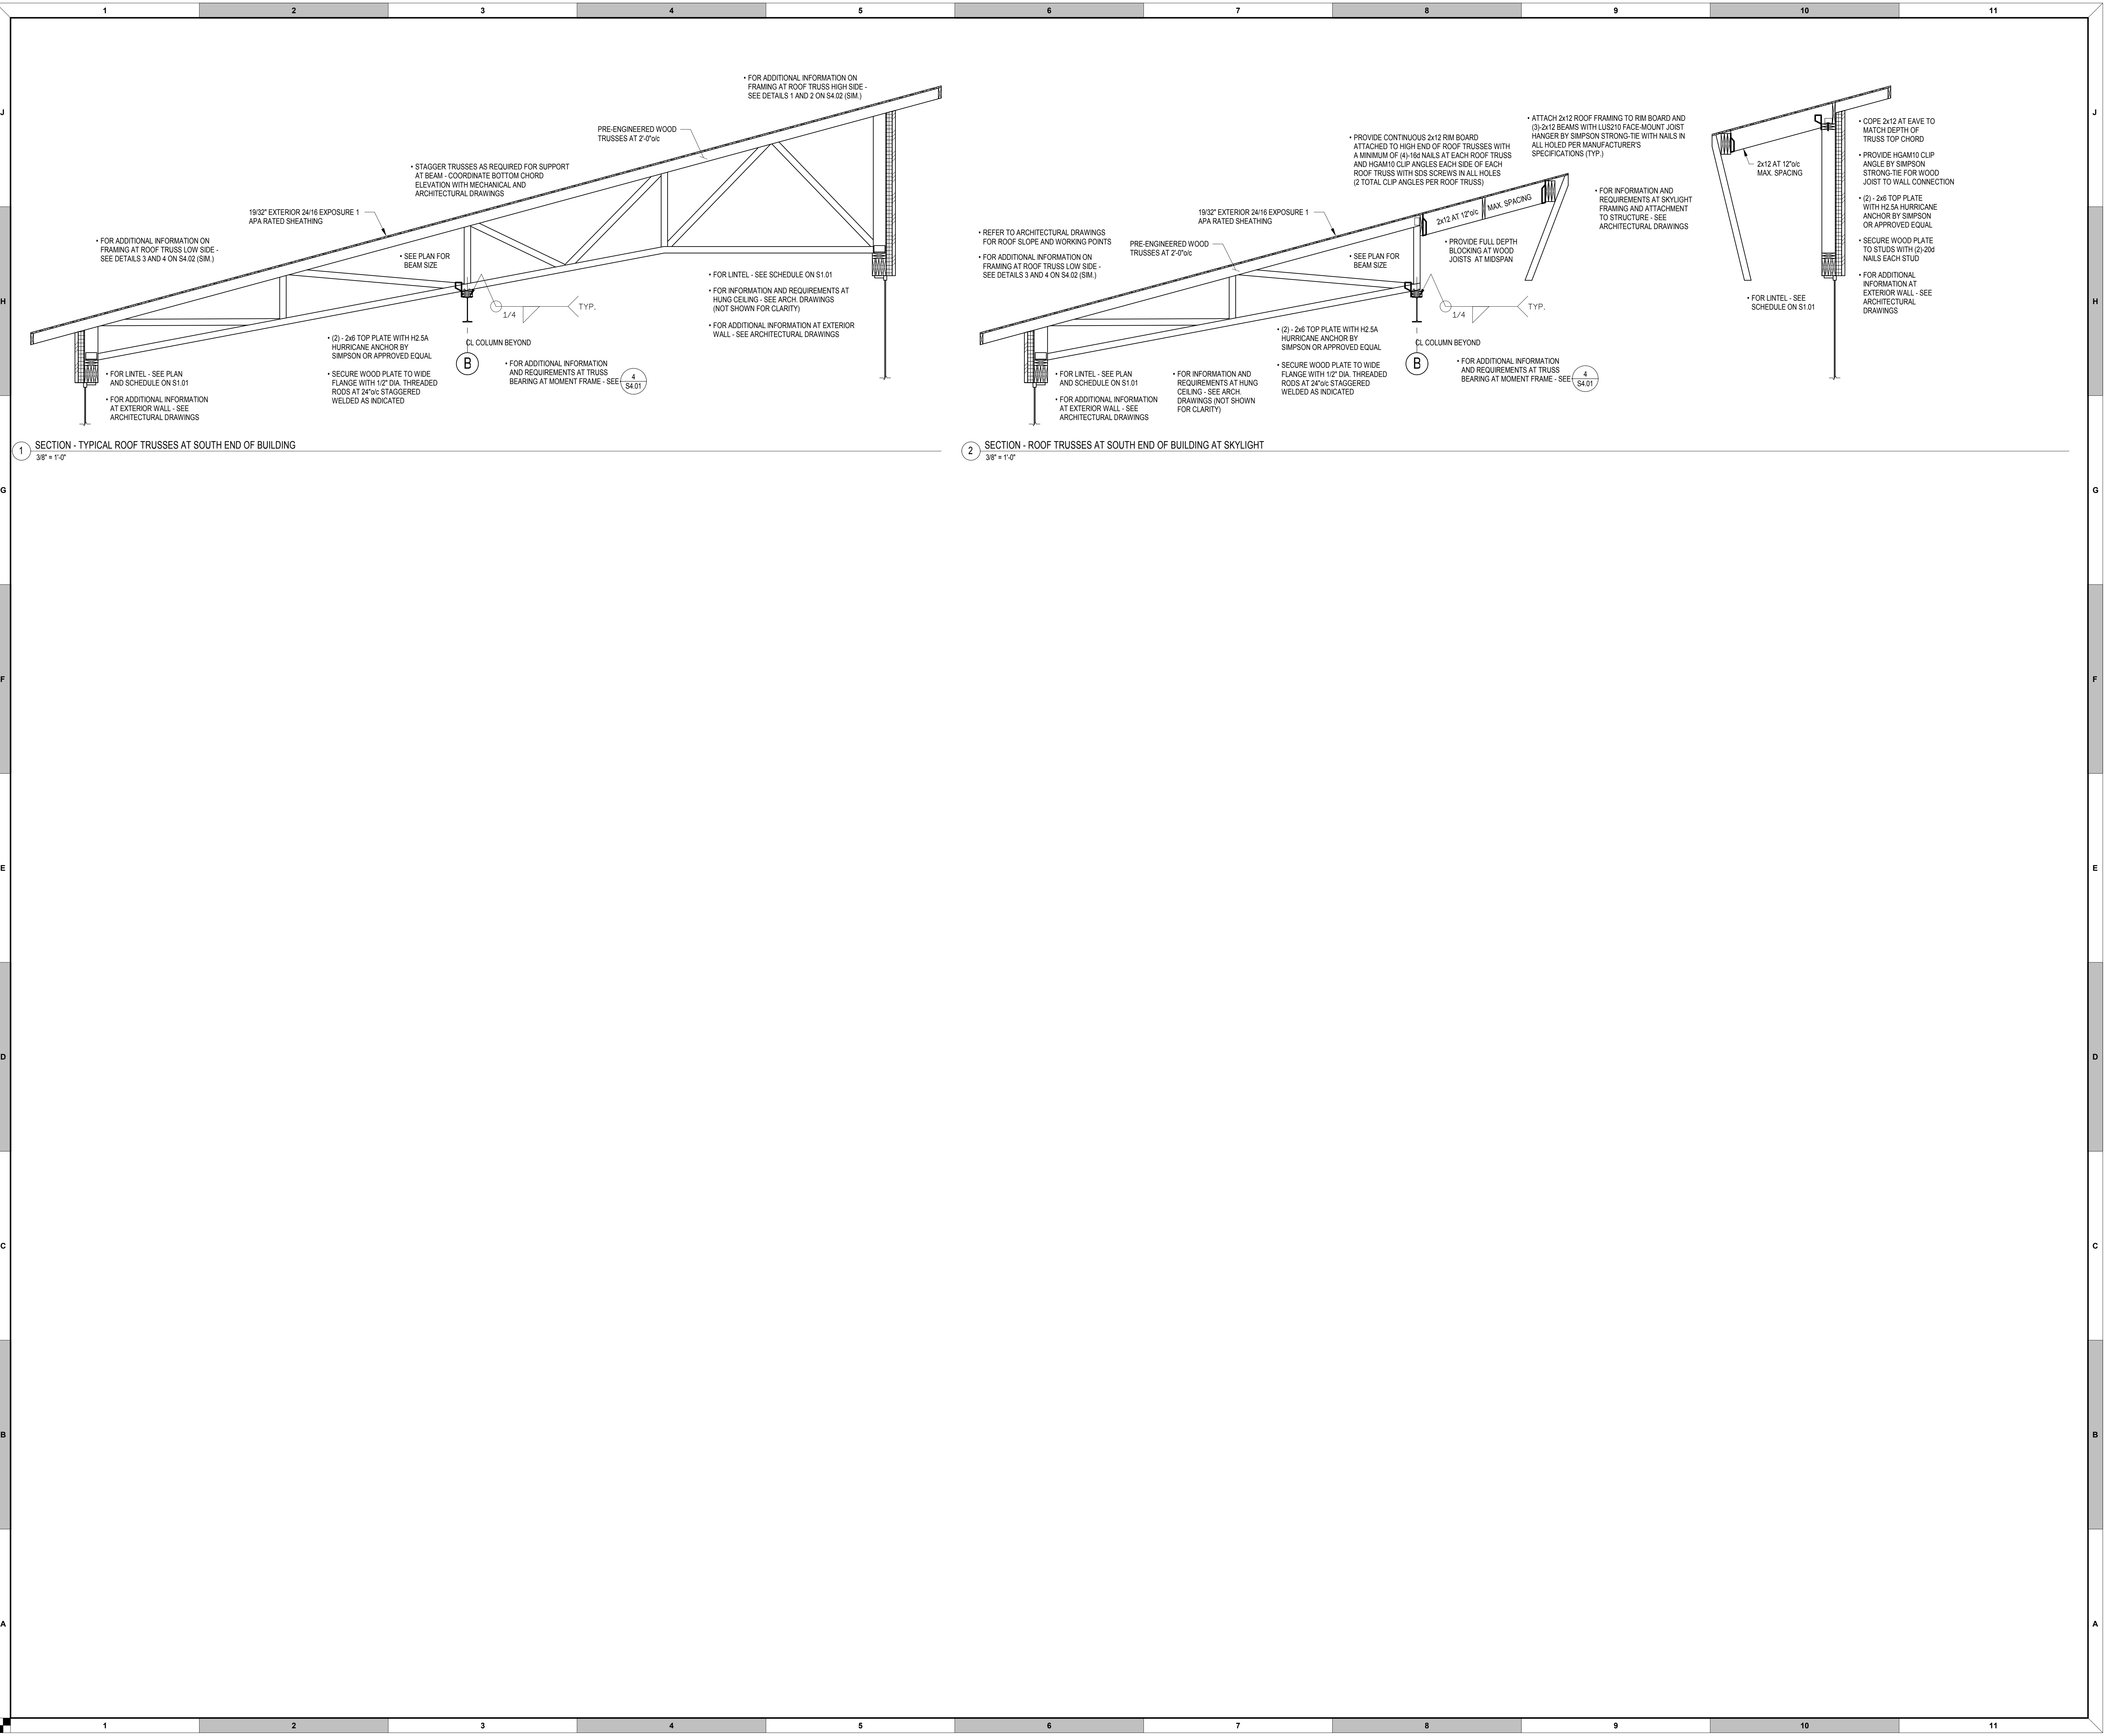
DRAWING NUMBER
S4.03



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DRAWING INFORMATION table with fields for ISSUE DATE, SCALE, JOB NO., and DRAWN BY.

PROJECT DESIGN PHASE
50% CD SET

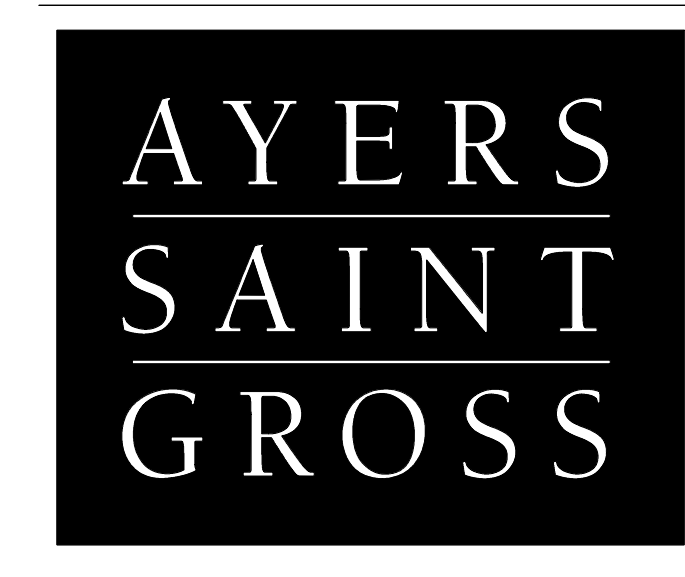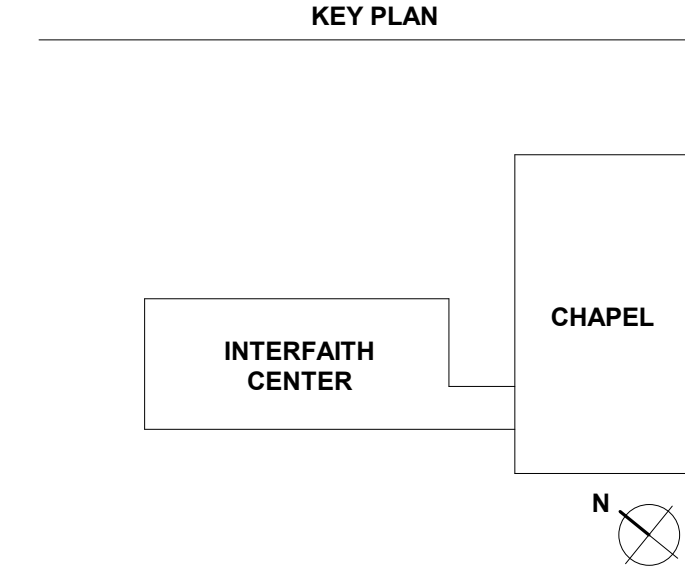DRAWING NAME
LIST OF SPECIAL INSPECTIONS

DRAWING NUMBER
S5.01

Table with 5 columns: TASK, VERIFICATION AND INSPECTION TASK; FREQUENCY OF INSPECTIONS (CONTINUOUS, PERIODIC); REFERENCE CRITERIA (REF. STD., IBC REF.). Includes SOILS inspection tasks.

SPECIAL INSPECTIONS NOTES
1. THE OWNER WILL ENGAGE (SEE CONTRACT REQUIREMENTS) THE SERVICES OF ONE OR MORE SPECIAL INSPECTORS TO PROVIDE INSPECTIONS DURING CONSTRUCTION ON WORK INDICATED IN THE SCHEDULE OF SPECIAL INSPECTIONS...

Table with 5 columns: TASK, VERIFICATION AND INSPECTION TASK; FREQUENCY OF INSPECTIONS; REFERENCE CRITERIA. Includes STEEL CONSTRUCTION OTHER THAN STRUCTURAL STEEL inspection tasks.

Table with 5 columns: TASK, VERIFICATION AND INSPECTION TASK; FREQUENCY OF INSPECTIONS; REFERENCE CRITERIA. Includes CONCRETE CONSTRUCTION inspection tasks.

Table with 6 columns: TASK, VERIFICATION AND INSPECTION TASK; FREQUENCY OF INSPECTIONS; REFERENCE CRITERIA. Includes MASONRY CONSTRUCTION LEVEL B inspection tasks.

Table with 5 columns: TASK, VERIFICATION AND INSPECTION TASK; FREQUENCY OF INSPECTIONS; REFERENCE CRITERIA. Includes STRUCTURAL STEEL inspection tasks.

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STAPLE EDGE

STAPLE EDGE

STAPLE EDGE

PROJECT GENERAL NOTES

ABBREVIATIONS

SYMBOLS

PROJECT INFORMATION



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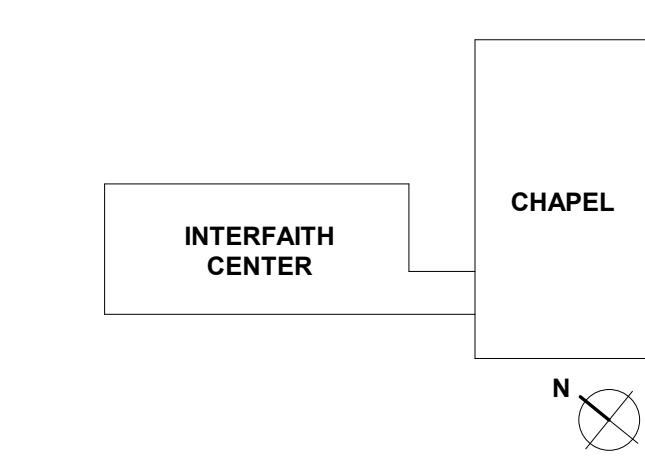
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REVISIONS table with columns: REV.#, DESCRIPTION, DATE

KEY PLAN



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50% CONSTRUCTION DOCUMENTS

ABBREVIATIONS AND SYMBOLS

DRAWING NUMBER

A0.10


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Main table containing abbreviations and symbols. Columns include: #, NUMBER, POUNDS, FFE, FINISH FLOOR ELEVATION / FIXTURES FURNITURE & EQUIPMENT, OPNG, OPENING, etc.

Grid lines and project general notes area. Includes vertical labels A through J and horizontal labels 1 through 11. Contains project general notes text.

REVISIONS

REV. #	DESCRIPTION	DATE

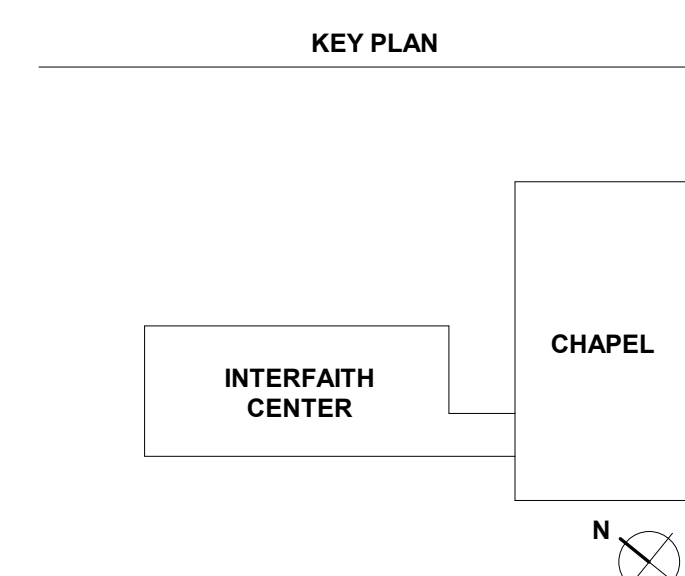

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DRAWING INFORMATION

ISSUE DATE:	04/28/17
SCALE:	As indicated
JOB NO.:	21641.00
DRAWN BY:	ASG

PROJECT DESIGN PHASE
50% CONSTRUCTION DOCUMENTS

CODE SUMMARY & EGRESS PLANS

DRAWING NUMBER
A0.20

CODE SUMMARY

Applicable Codes

- 2015 International Building Code with Baltimore County Amendments
- 2015 International Existing Building Code
- 2015 International Mechanical Code with Baltimore County Amendments
- 2015 National Standard Plumbing Code with Baltimore County Amendments
- 2015 International Energy Conservation Code with Baltimore County Amendments
- 2014 National Electrical Code with Baltimore County Amendments
- 2015 NFPA 101 Life Safety Code with Baltimore County Amendments
- 2015 NFPA 1 With Baltimore County Amendments
- Accessibility Code: COMAR 05.02.02: 2010 ADAAG

Alterations to Existing Chapel:

The existing Haebler Chapel was constructed in 1982. The existing building is of concrete, masonry, and wood construction and is unsprinklered. Scope of alterations to the existing chapel includes the addition of two accessible toilet rooms for convenience, lighting upgrades, and removal of fixed seating pews and casework. As part of the alterations the building will be fully sprinklered.

The existing primary occupancy to remain unchanged is Assembly Group A-3, Spaces for worship.

New Construction:

Construction of a new addition will be separated from the existing Haebler Chapel by means of a rated construction and will be considered a separate building of Type V-B construction, fully sprinklered.

Occupancy

The building is a non-separated mixed use building consisting primarily of Business (IBC 2015 Section 304 & LSC Chapter 38), Assembly (IBC 2015 Section 303.1, & per LSC Chapter 12) and Storage.

The building is fully sprinklered per NFPA 13.

Type of Construction

Type V-B Construction (Allowable Height, Number of Stories, and Area per IBC Table 504.3, Table 504.4 & 506.2)

- Allowable Height with sprinkler increases: 60 feet.
- Number of Stories above Grade Plane 2.
- Allowable Area with sprinkler increases for multistory: 18,000.

The highest occupied floor is less than 75 feet above the lowest level of fire department access. Therefore, the building is not considered high rise (IBC 403.1)

New Construction Fire Resistance Rating Requirements for Building Elements

Structural Frame: 0 Hours
Beaming walls (Interior & Exterior): 0 Hours
Floor construction: 0 Hours
Roof construction: 0 Hours
Non Beaming Walls & Partitions (Interior): 0 Hours
Vertical Openings Connecting not more than 2 stories are allowed per IBC 707.2 exception 2 and per LSC 5.6

Means of Egress

Occupant Load Factor (LSC Table 7.3.1.2)
Assembly, concentrated: 7 NSF per person.
Assembly, less concentrated: 15 NSF per person.
Business: 100 GSF per person.
Storage: 300 GSF per person.

Chapel:
Stages & Platforms: 15 NSF per person.

04 T.O. ROOF 463' - 4"
03 ROOF BEARING 455' - 4"
02 LEVEL 2 445' - 4"
00 GROUND LEVEL 434' - 0"
-03 LOWER LEVEL 423' - 0"
-04 CHAPEL BASEMENT 422' - 0"

2 CODE ANALYSIS BUILDING SECTION
1/16" = 1'-0"

INTERFAITH CENTER - PLUMBING FIXTURE TABULATION

LEVEL	AREA TYPE	(GSF)	OCCUPANCY GROUP	OCCUPANCY DESCRIPTION	WATER CLOSETS		LAVATORIES		BATHTUBS / SHOWERS	DRINKING FOUNTAINS	OTHER
					MALE	FEMALE	MALE	FEMALE			
BASEMENT LEVEL	ACCESSORY STORAGE AREAS, MECHANICAL EQUIPMENT ROOMS	1378 SQ.FT.									
BASEMENT LEVEL	ASSEMBLY UNCONCENTRATED	291 SQ.FT.	A-3								
BASEMENT LEVEL	BUSINESS AREAS	1076 SQ.FT.	B								
GROUND LEVEL	ASSEMBLY UNCONCENTRATED	1572 SQ.FT.	A-3								
GROUND LEVEL	BUSINESS AREAS	1337 SQ.FT.	B								
SECOND LEVEL	BUSINESS AREAS	816 SQ.FT.	B								

CHAPEL - PLUMBING FIXTURE TABULATION

LEVEL	AREA TYPE	(GSF)	OCCUPANCY GROUP	OCCUPANCY DESCRIPTION	WATER CLOSETS		LAVATORIES		BATHTUBS / SHOWERS	DRINKING FOUNTAINS	OTHER
					MALE	FEMALE	MALE	FEMALE			
BASEMENT LEVEL	ACCESSORY STORAGE AREAS, MECHANICAL EQUIPMENT ROOMS	2368 SQ.FT.	B								
BASEMENT LEVEL	BUSINESS AREAS	797 SQ.FT.	A-3								
GROUND LEVEL	ACCESSORY STORAGE AREAS, MECHANICAL EQUIPMENT ROOMS	75 SQ.FT.	B								
GROUND LEVEL	ASSEMBLY UNCONCENTRATED	1918 SQ.FT.	A-3								
GROUND LEVEL	BUSINESS AREAS	1891 SQ.FT.	B								
SECOND LEVEL	ASSEMBLY FIXED SEATING	459 SQ.FT.	A-3								

CHAPEL - BUILDING OCCUPANCY SUMMARY

CODE SPACE FUNCTION KEY	OCCUPANCY CALCULATION		OCCUPANCY AREA	OCCUPANCY LOAD	NOTES
	SF/OCCUPANT	NSF/GSF			
-03 LOWER LEVEL					
ACCESSORY STORAGE AREAS, MECHANICAL EQUIPMENT ROOMS	300 SF	GROSS	2368 SF	9	
BUSINESS AREAS	100 SF	GROSS	797 SF	9	
			3165 SF	18	
00 GROUND LEVEL					
ACCESSORY STORAGE AREAS, MECHANICAL EQUIPMENT ROOMS	300 SF	GROSS	75 SF	1	
ASSEMBLY - UNCONCENTRATED (TABLES AND CHAIRS)	15 SF	NET	1918 SF	240	
BUSINESS AREAS	100 SF	GROSS	1891 SF	19	
			3884 SF	260	
02 LEVEL 2					
ASSEMBLY - FIXED SEATING	0 SF	SEE SECTION 1004.7	459 SF	69	
			459 SF	69	
			7508 SF	347	

INTERFAITH CENTER - BUILDING OCCUPANCY SUMMARY

CODE SPACE FUNCTION KEY	OCCUPANCY CALCULATION		OCCUPANCY AREA	OCCUPANCY LOAD	NOTES
	SF/OCCUPANT	NSF/GSF			
-03 LOWER LEVEL					
ACCESSORY STORAGE AREAS, MECHANICAL EQUIPMENT ROOMS	300 SF	GROSS	1404 SF	5	
ASSEMBLY - UNCONCENTRATED (TABLES AND CHAIRS)	15 SF	NET	291 SF	20	
BUSINESS AREAS	100 SF	GROSS	1050 SF	12	
			2746 SF	37	
00 GROUND LEVEL					
ASSEMBLY - UNCONCENTRATED (TABLES AND CHAIRS)	15 SF	NET	1572 SF	107	
BUSINESS AREAS	100 SF	GROSS	1337 SF	15	
			2908 SF	122	
02 LEVEL 2					
BUSINESS AREAS	100 SF	GROSS	816 SF	9	
			816 SF	9	
			6470 SF	168	

EGRESS COMPONENT SYMBOL

W = WIDTH OF LIMITING COMPONENT IN INCHES. DOOR CALCULATION = ACTUAL WIDTH - (DOOR THICKNESS + (2 x STOP DEPTH))
X = ACTUAL EXIT LOAD - PROPOSED NUMBER OF OCCUPANTS USING EXIT
Y = "CALCULATED EXIT CAPACITY" - MAX. NUMBER OF OCCUPANTS EXIT CAN ACCOMMODATE = W / Z
Z = EGRESS WIDTH PER OCCUPANT SERVED (INCHES PER OCCUPANT) PER TABLE 1005.1

20 MINUTE FIRE LABEL DOOR
45 MINUTE FIRE LABEL DOOR
60 MINUTE FIRE LABEL DOOR
90 MINUTE FIRE LABEL DOOR
180 MINUTE FIRE LABEL DOOR

--- NON-RATED SMOKE PARTITION
--- 1 1/2 HOUR RATED FIRE BARRIER
--- 1 HOUR RATED FIRE BARRIER
--- 12 HOUR RATED FIRE BARRIER

REFER TO FLOOR PLANS FOR PARTITION TYPES AND PARTITION SCHEDULE FOR SPECIFIC UL ASSEMBLIES

000 SF --- TOTAL AREA OF SPACE
000 --- NUMBER OF OCCUPANTS IN SPACE

Room name --- INDIVIDUAL ROOM NAMES
101 --- INDIVIDUAL ROOM NUMBERS

--- TRAVEL DISTANCE - PATH OF TRAVEL

--- DENOTES ACCESSIBLE MOBILITY FEATURES PER ADA 2010 T224.2
--- DENOTES ACCESSIBLE COMMUNICATION FEATURES PER ADA 2010 T224.4

LIFE SAFETY LEGEND
1/16" = 1'-0"

FC --- FIRE EXTINGUISHER/ STANDPIPE COMBO-FULLY RECESSED
FE --- FIRE EXTINGUISHER - BRACKET MOUNTED
FR --- FIRE EXTINGUISHER CABINET - FULLY RECESSED




SECOND FLOOR IS CONSIDERED A BUSINESS OCCUPANCY WITH AN OCCUPANT LOAD OF 8.

LSC 38 2.4.6: A SINGLE MEANS OF EGRESS SHALL BE PERMITTED FOR A MAXIMUM 2 STORY SINGLE TENANT BUILDING PROVIDED THAT THE BUILDING IS PROTECTED BY AN APPROVED, SUPERVISED AUTOMATIC SPRINKLER SYSTEM AND TOTAL TRAVEL DISTANCE TO THE OUTSIDE DOES NOT EXCEED 100 FEET.

TOTAL TRAVEL DISTANCE TO THE OUTSIDE = 87' < 100'

TABLE 1004.1.1
MAX. FLOOR AREA ALLOWANCES PER OCCUPANT FUNCTION OF SPACES SYMBOL LEGEND

000 SF 300 GSF	ACCESSORY STORAGE AND MECHANICAL EQUIPMENT ROOMS
000 SF 15 NSF	ASSEMBLY - FIXED SEATING REFER TO PLANS PER IBC 1004.7
000 SF 7 SF	ASSEMBLY - CONCENTRATED (CHAIRS ONLY)
000 SF 15 SF	ASSEMBLY UNCONCENTRATED (TABLES AND CHAIRS)
000 SF 100 GSF	BUSINESS AREAS

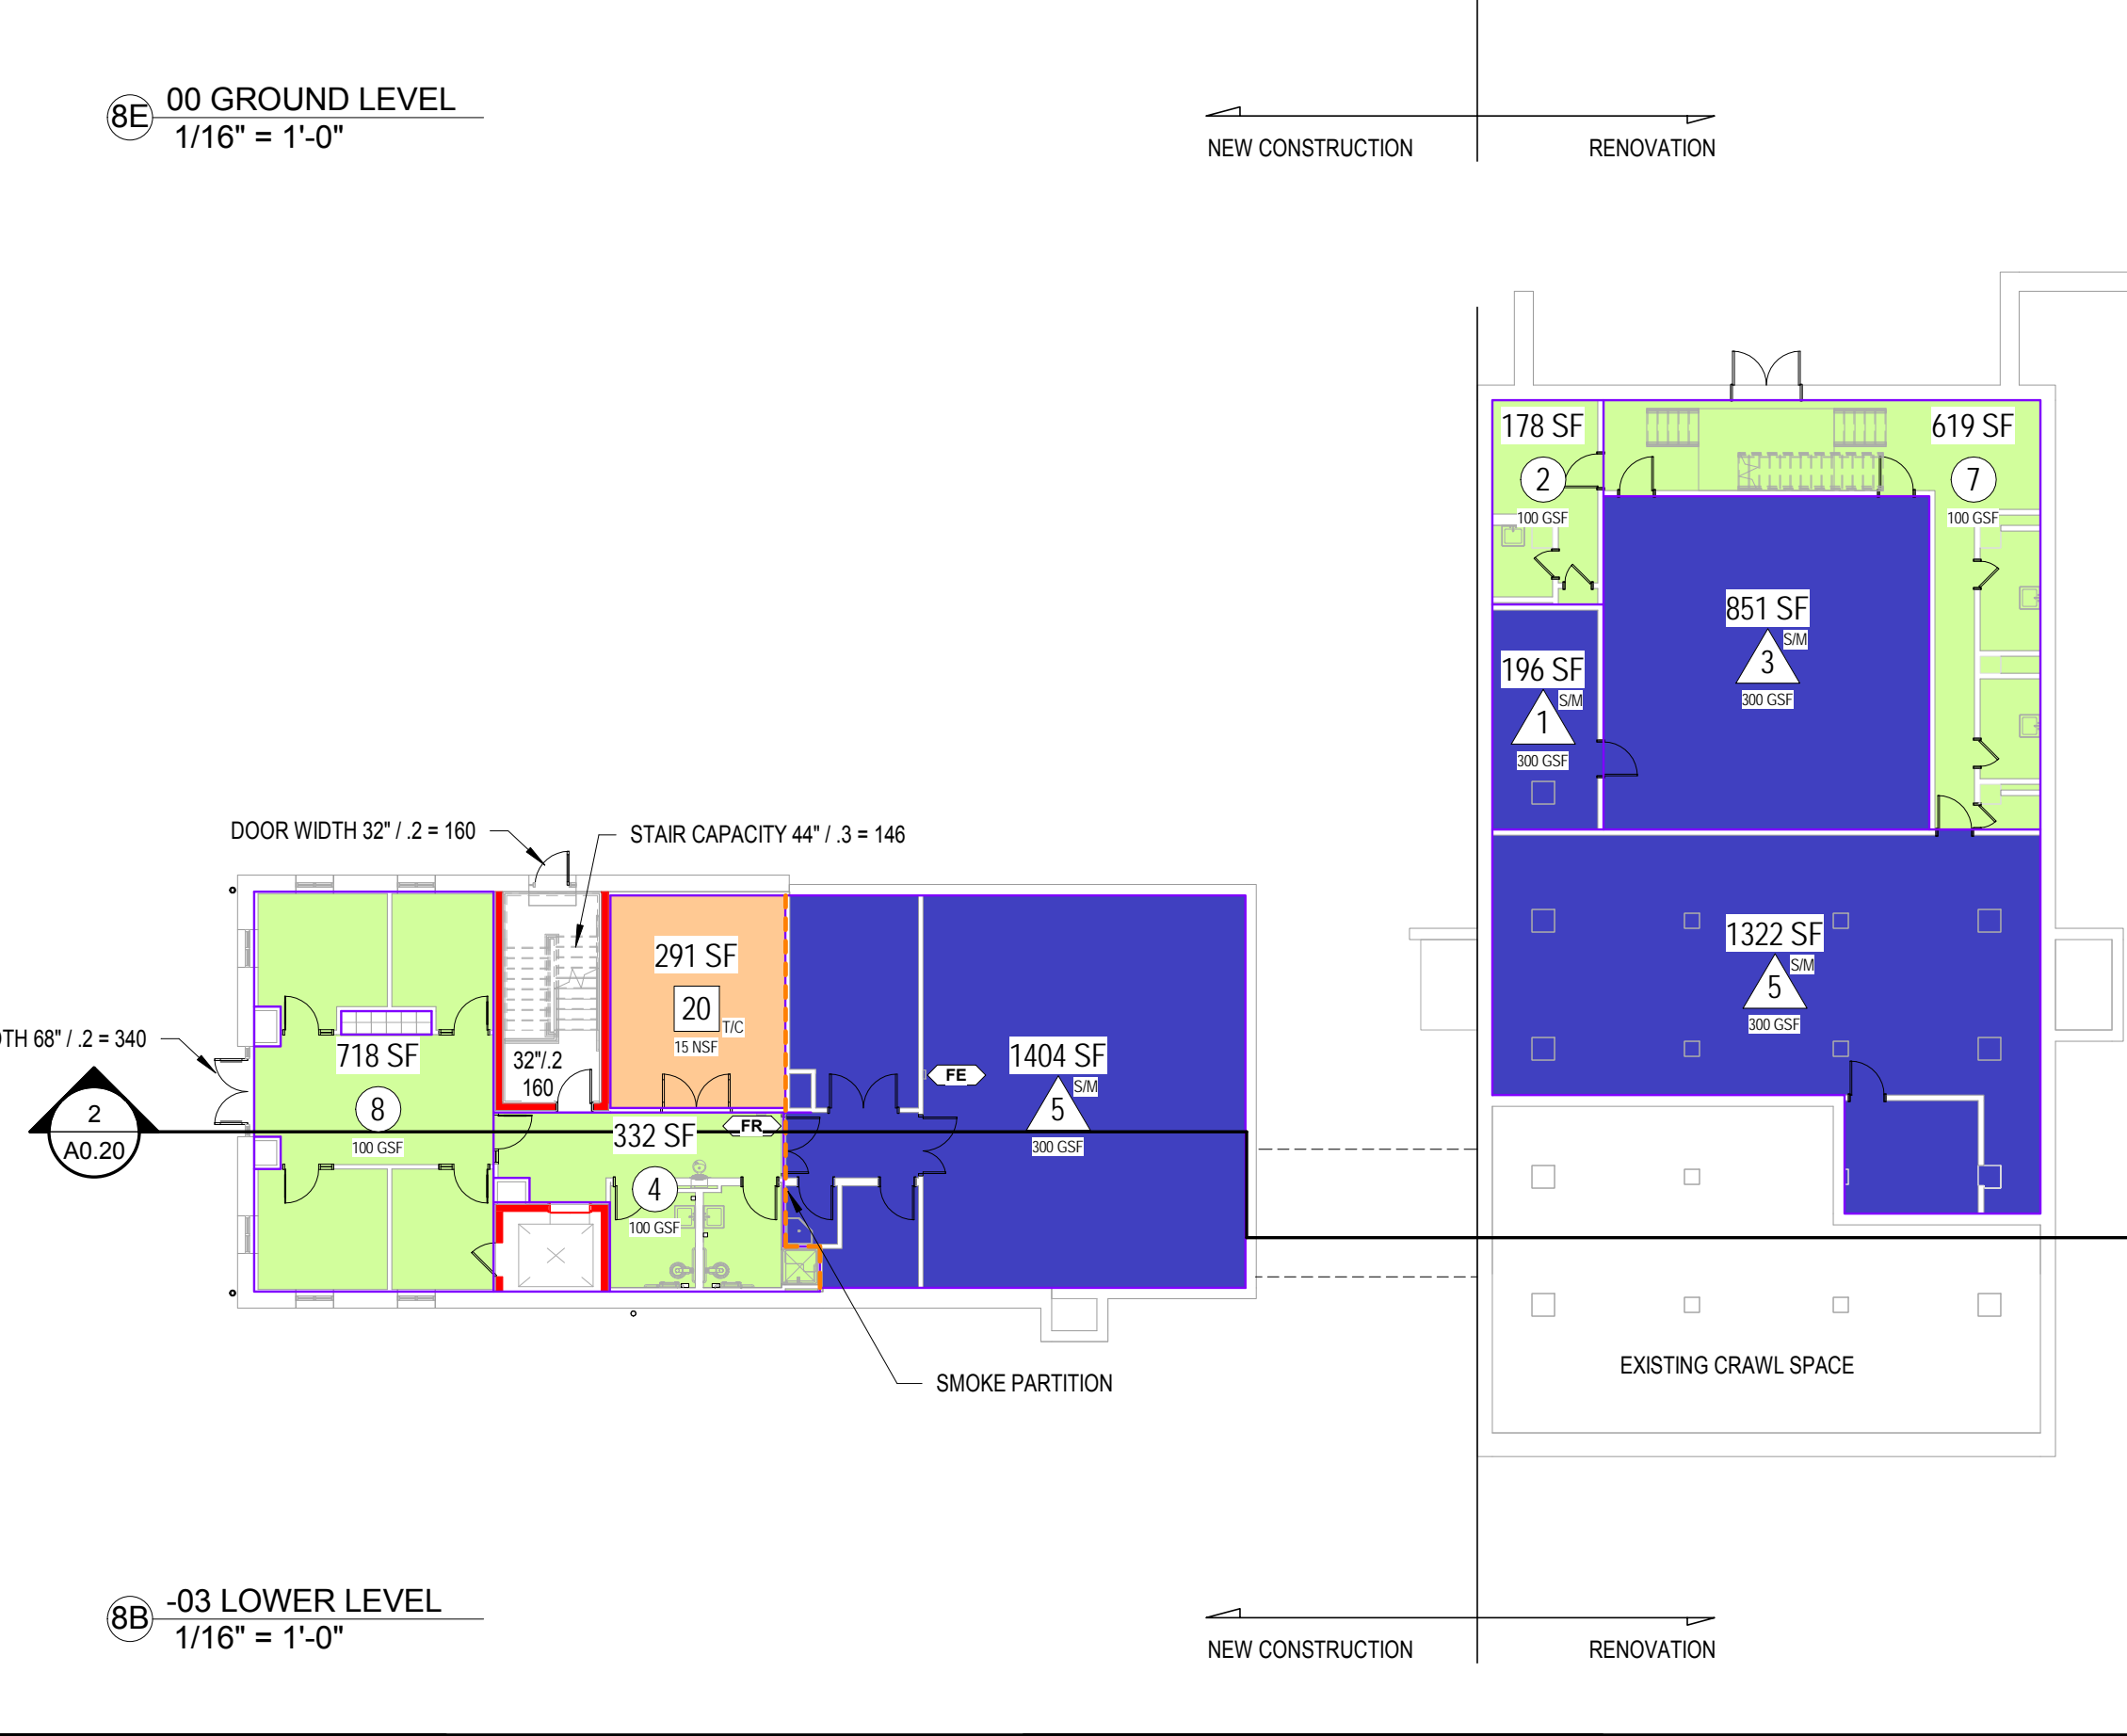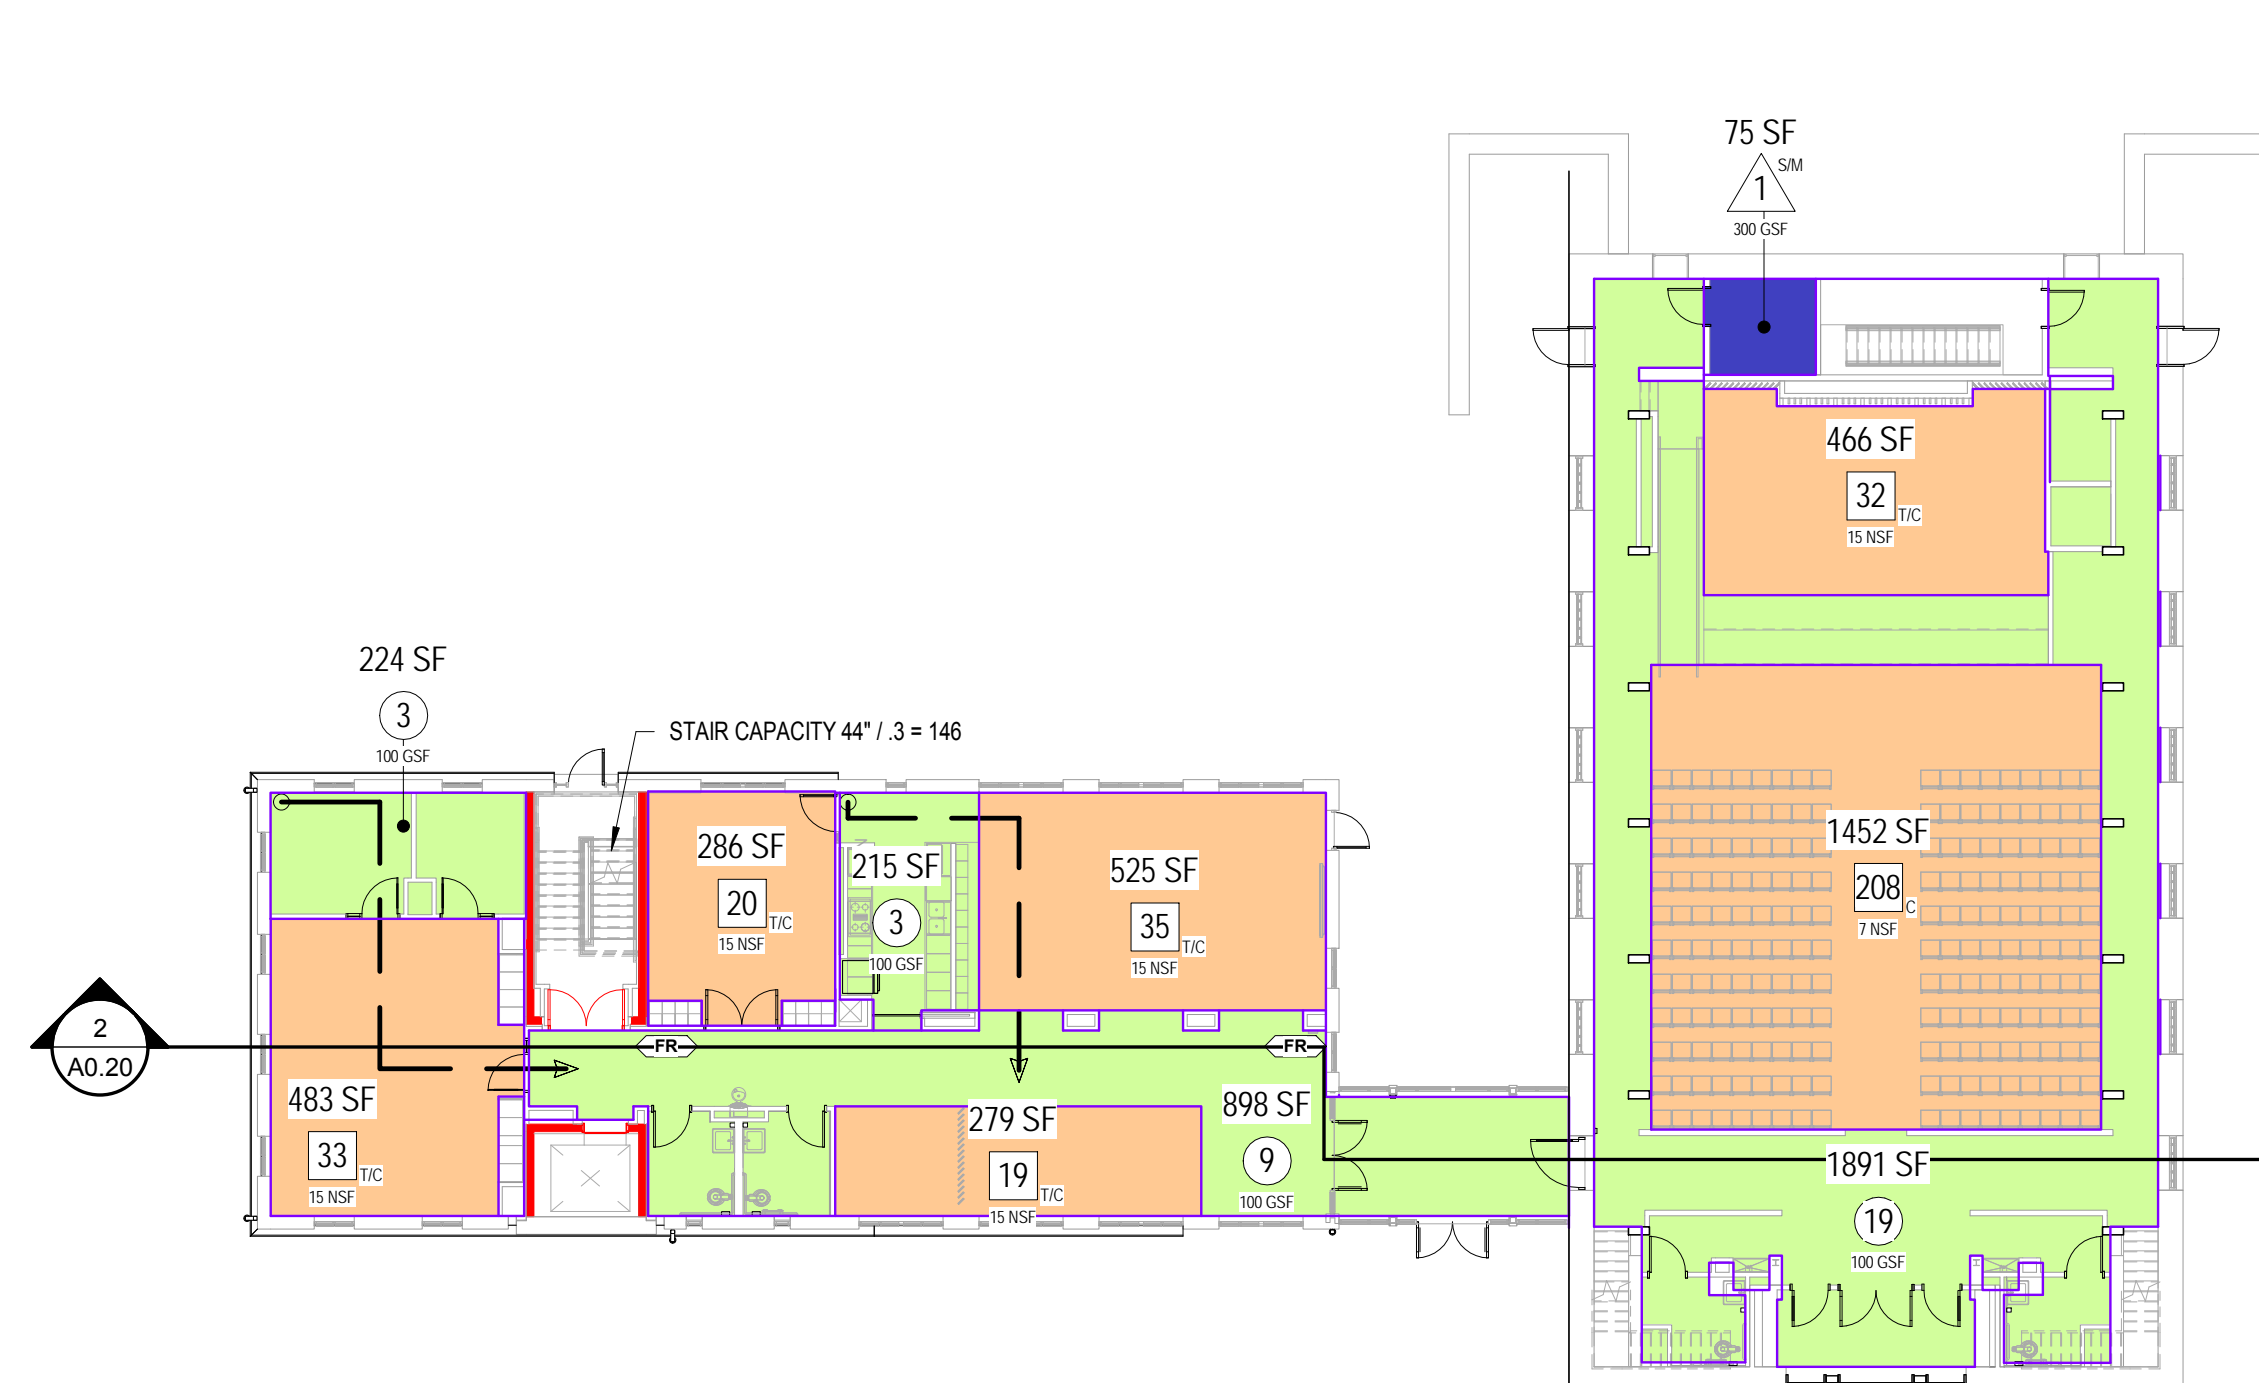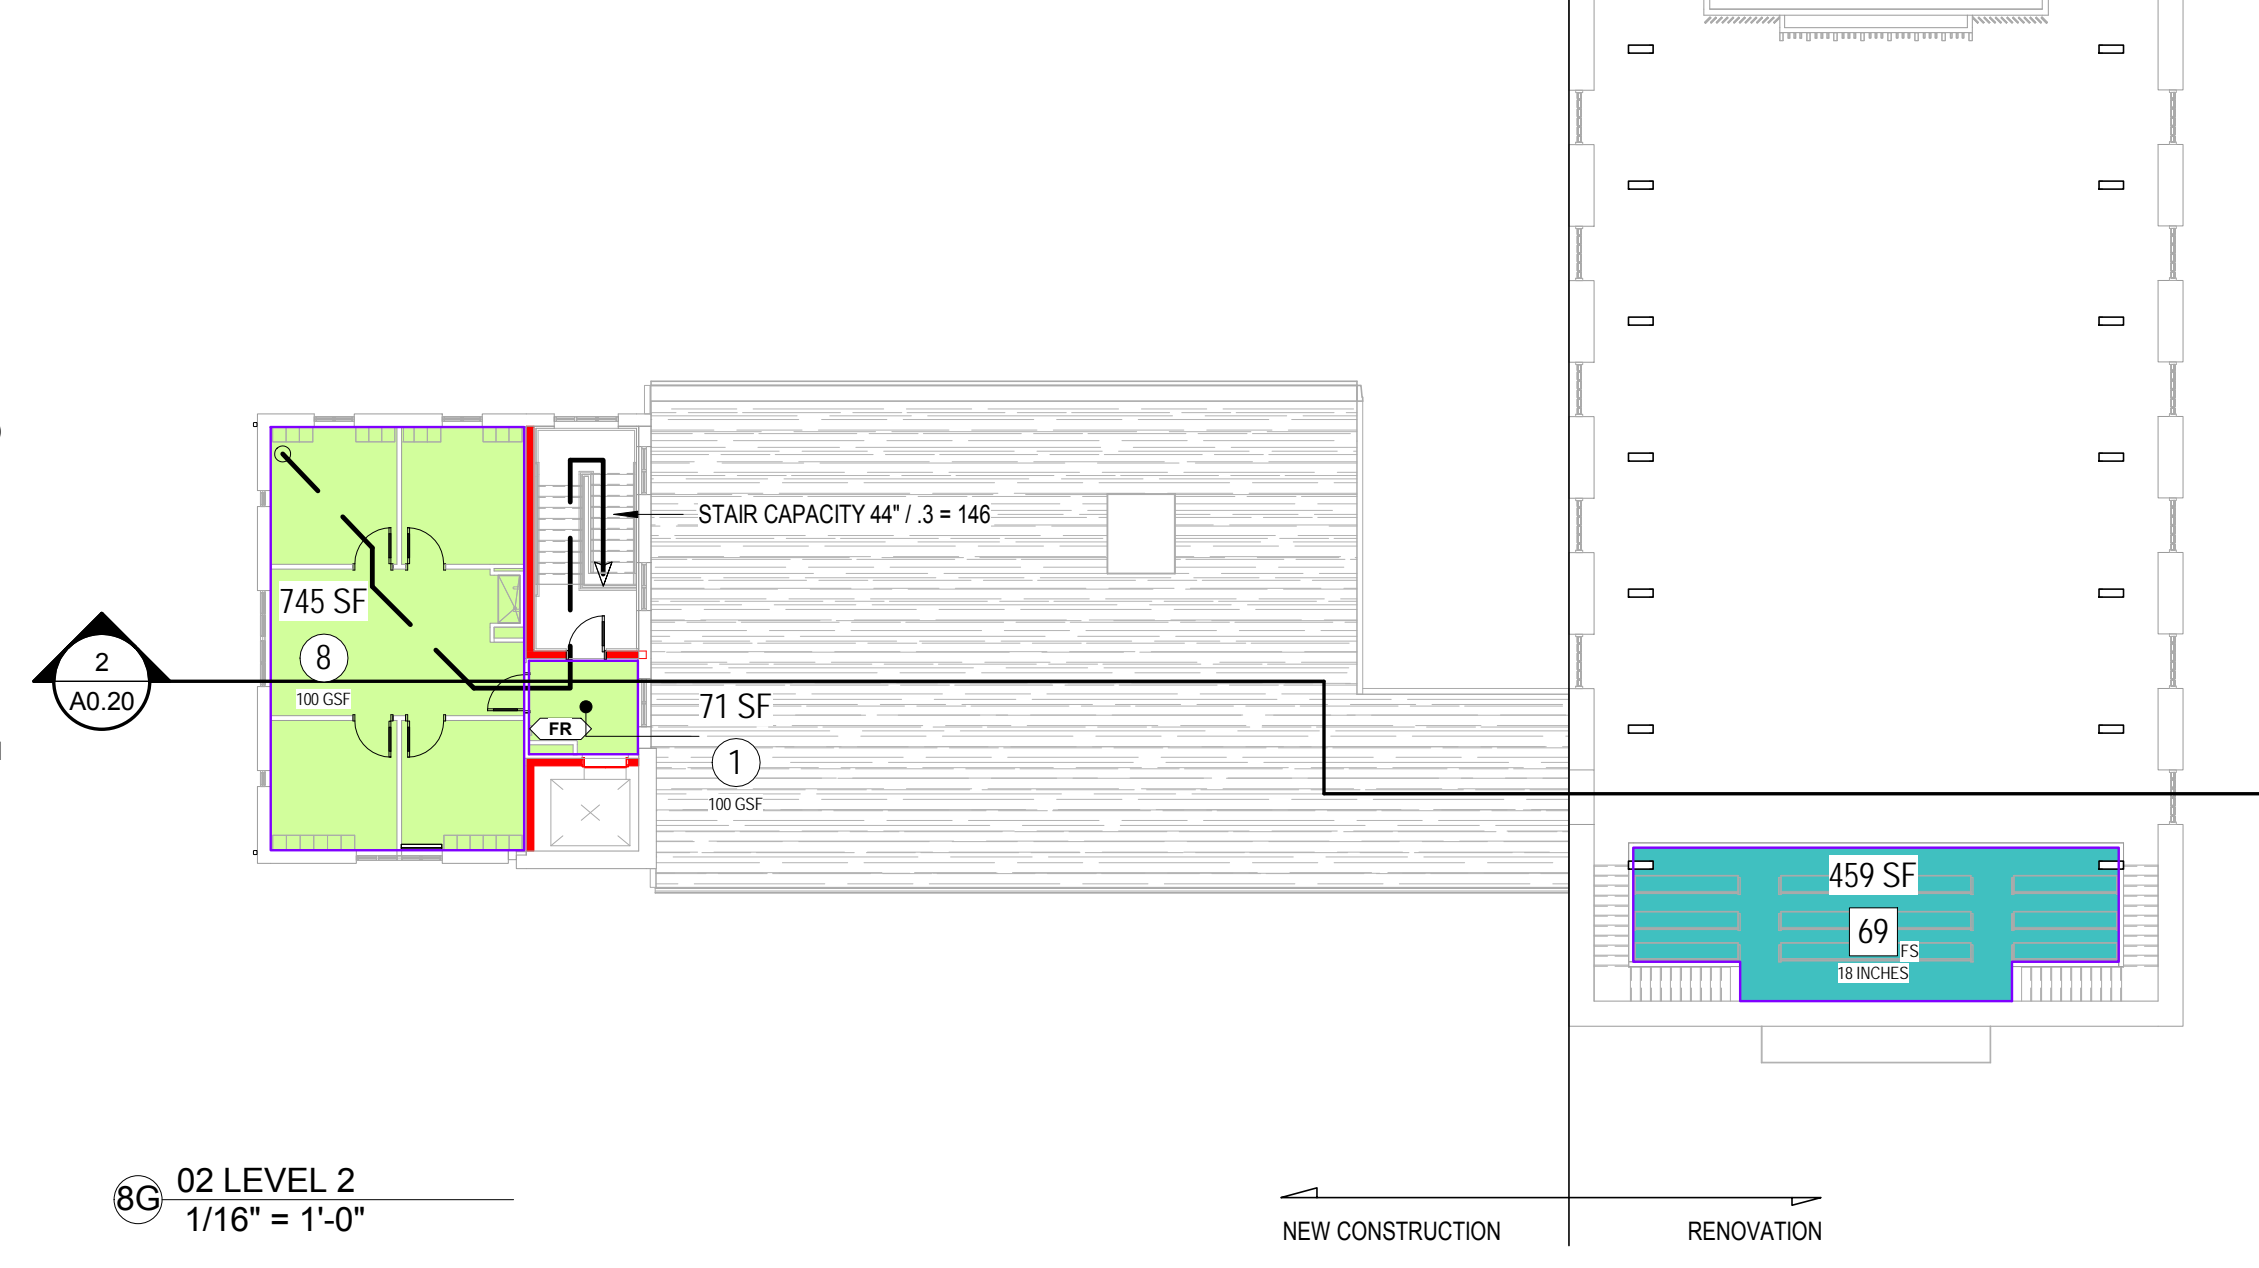

OCCUPANCY TYPE LEGEND

- ACCESSORY STORAGE AREAS, MECHANICAL EQUIPMENT ROOMS
- ASSEMBLY - FIXED SEATING
- ASSEMBLY - UNCONCENTRATED (TABLES AND CHAIRS)
- BUSINESS AREAS
- Calculating...

GOLDSMITH INTERFAITH CENTER

GOUCHER COLLEGE
1021 DULANEY VALLEY RD
BALTIMORE MD 21204

PROJECT TEAM

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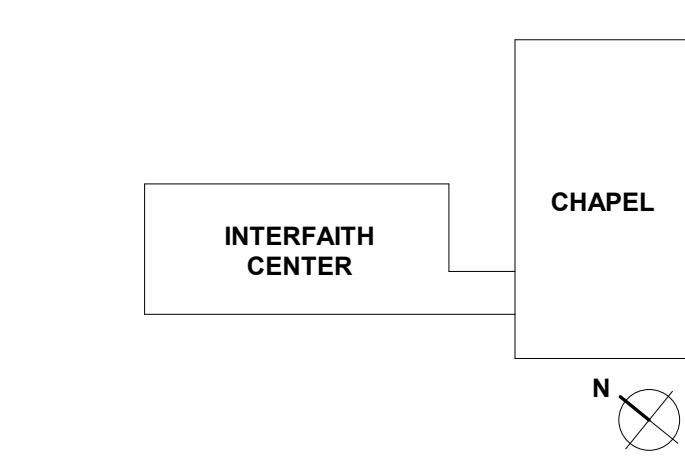
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410.712.0390
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REVISIONS		
REV. #	DESCRIPTION	DATE

KEY PLAN



ARCHITECTS + PLANNERS


NOT FOR CONSTRUCTION

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ISSUE DATE:	04/28/17
SCALE:	1" = 20'-0"
JOB NO.:	21641.00
DRAWN BY:	ASG

PROJECT DESIGN PHASE
50% CONSTRUCTION DOCUMENTS


DRAWING NAME
ARCHITECTURAL SITE PLAN

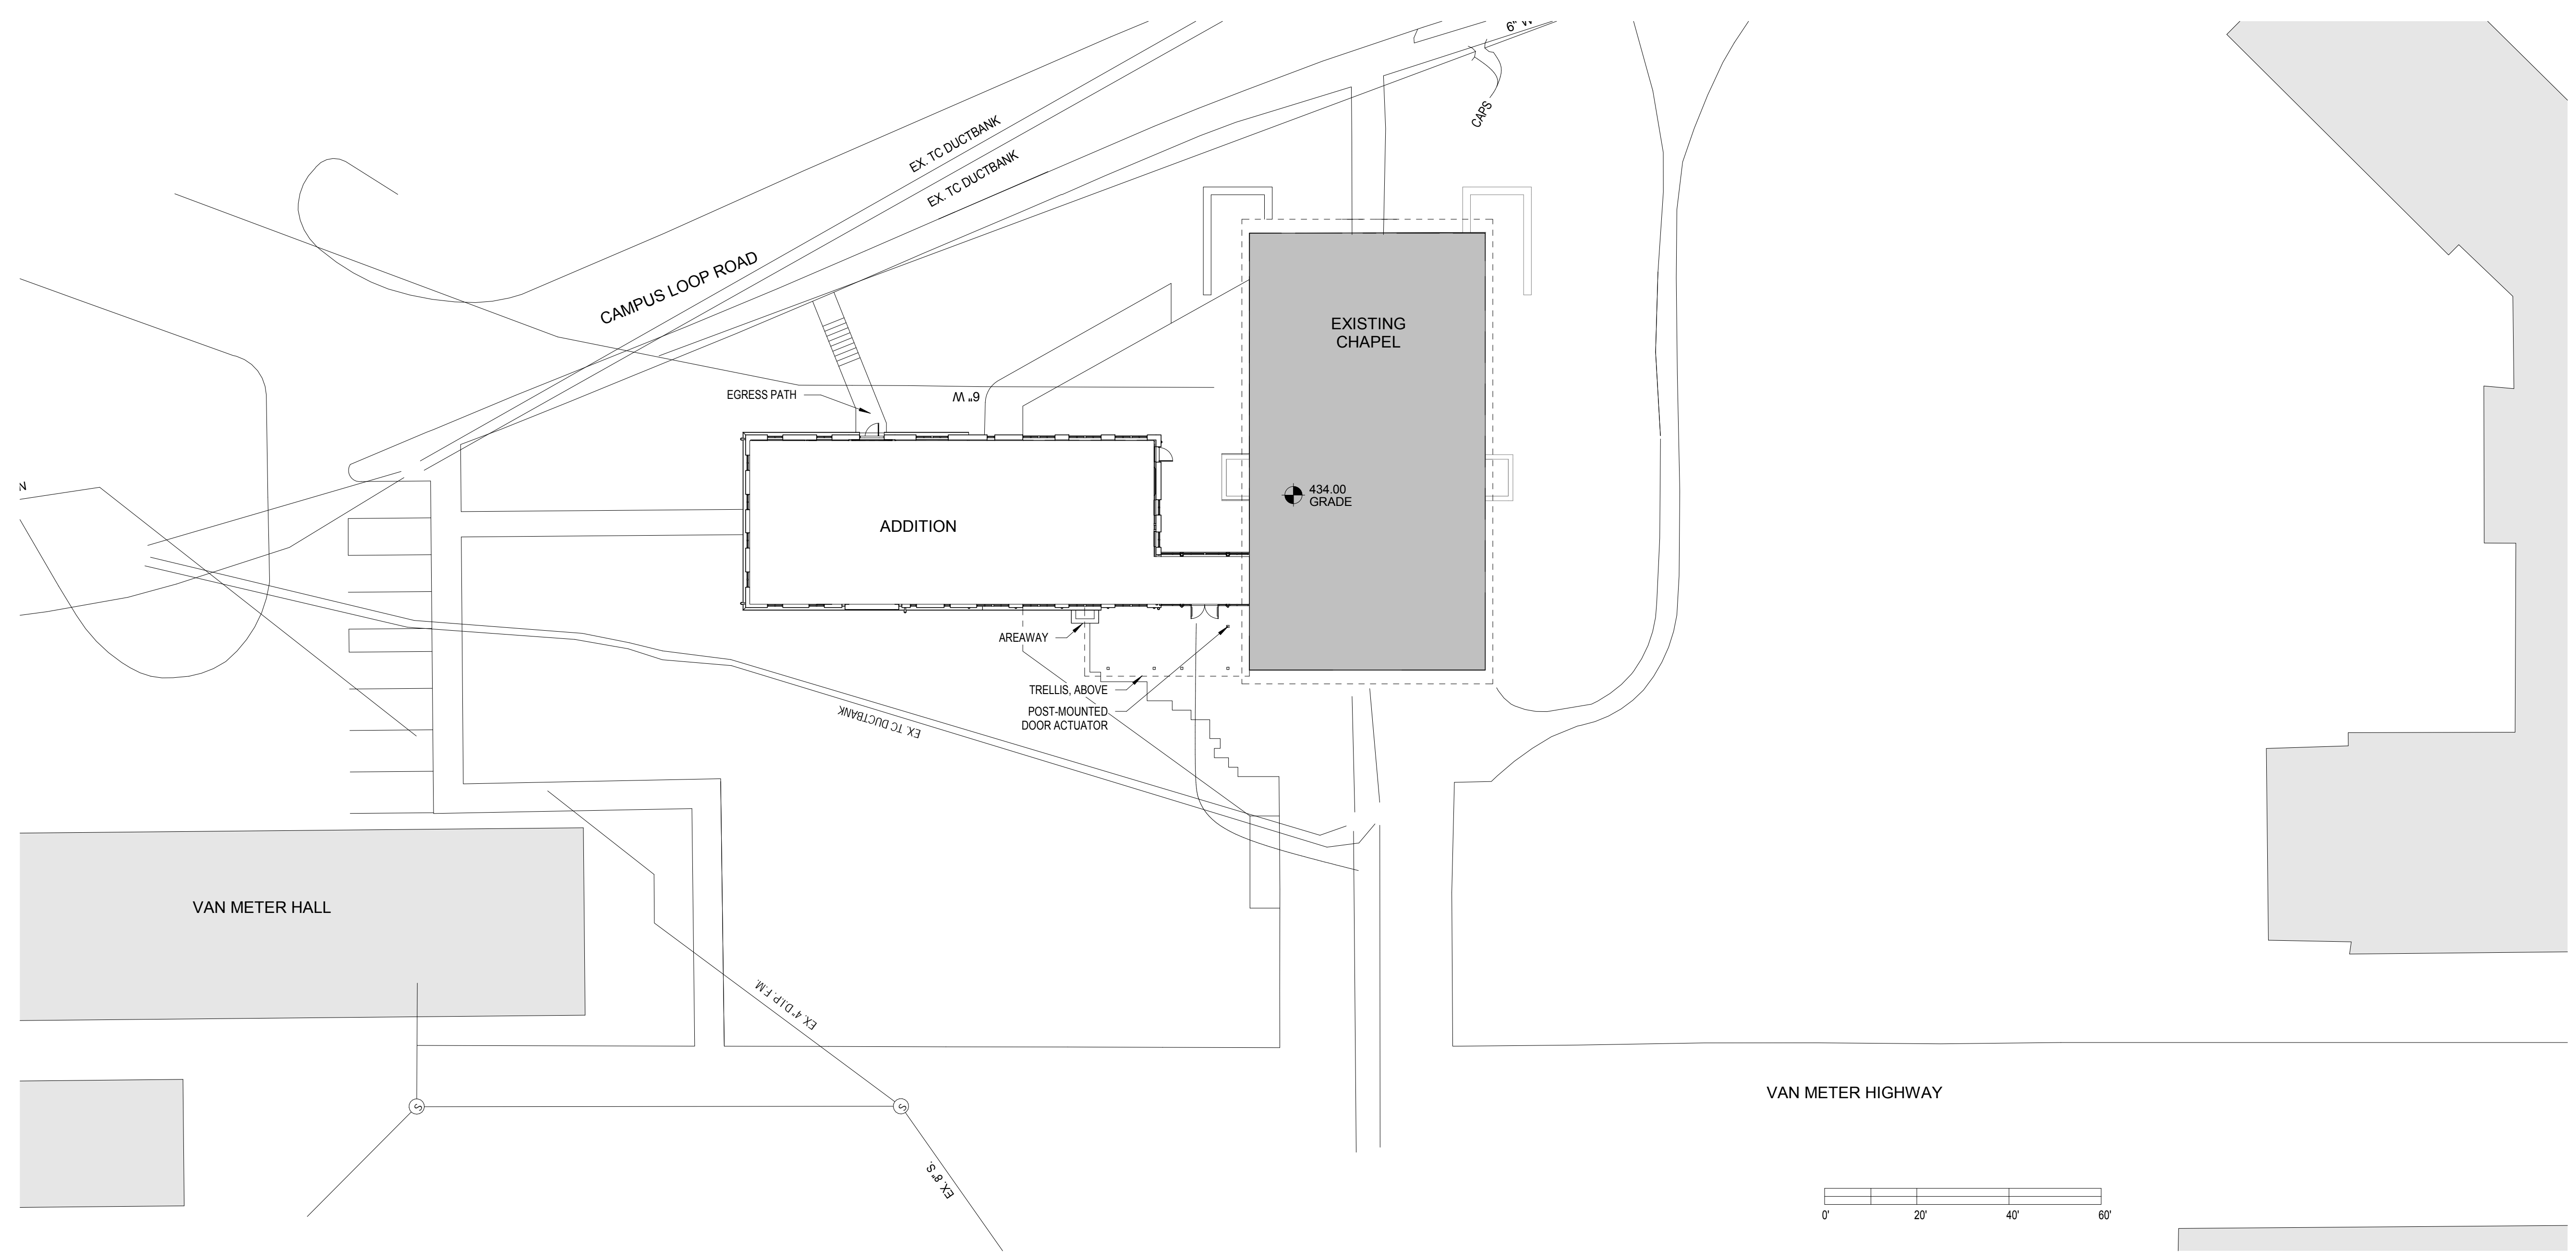DRAWING NUMBER
A1.00



SITE PLAN
1" = 20'-0"

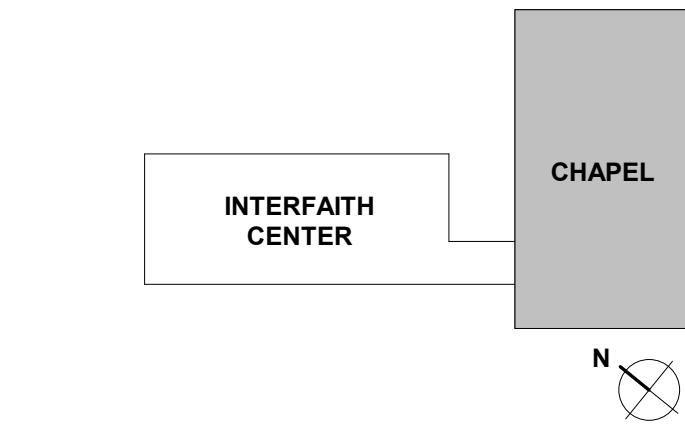Table with 3 columns: REV.#, DESCRIPTION, DATE. Includes a section for KEY PLAN.



ARCHITECTS + PLANNERS

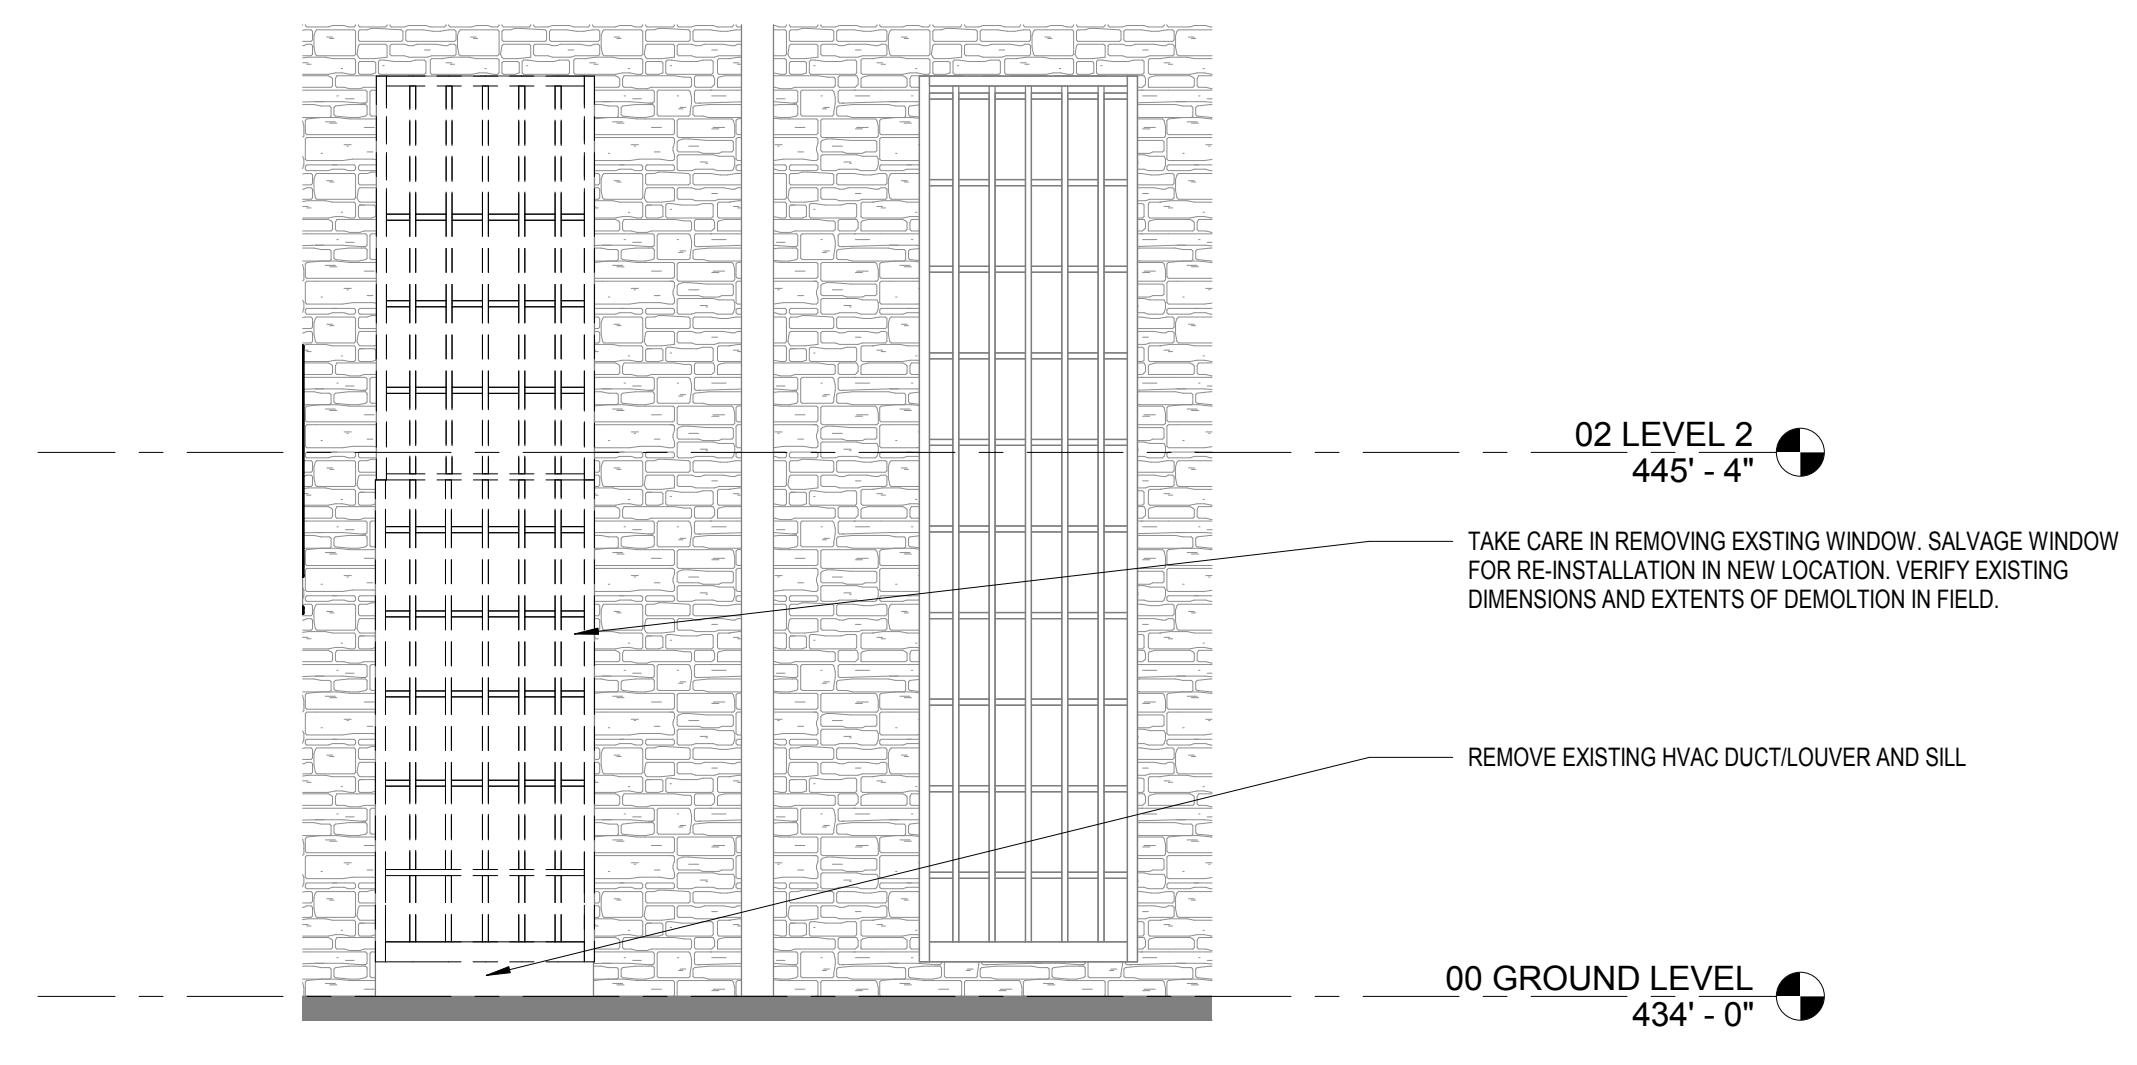
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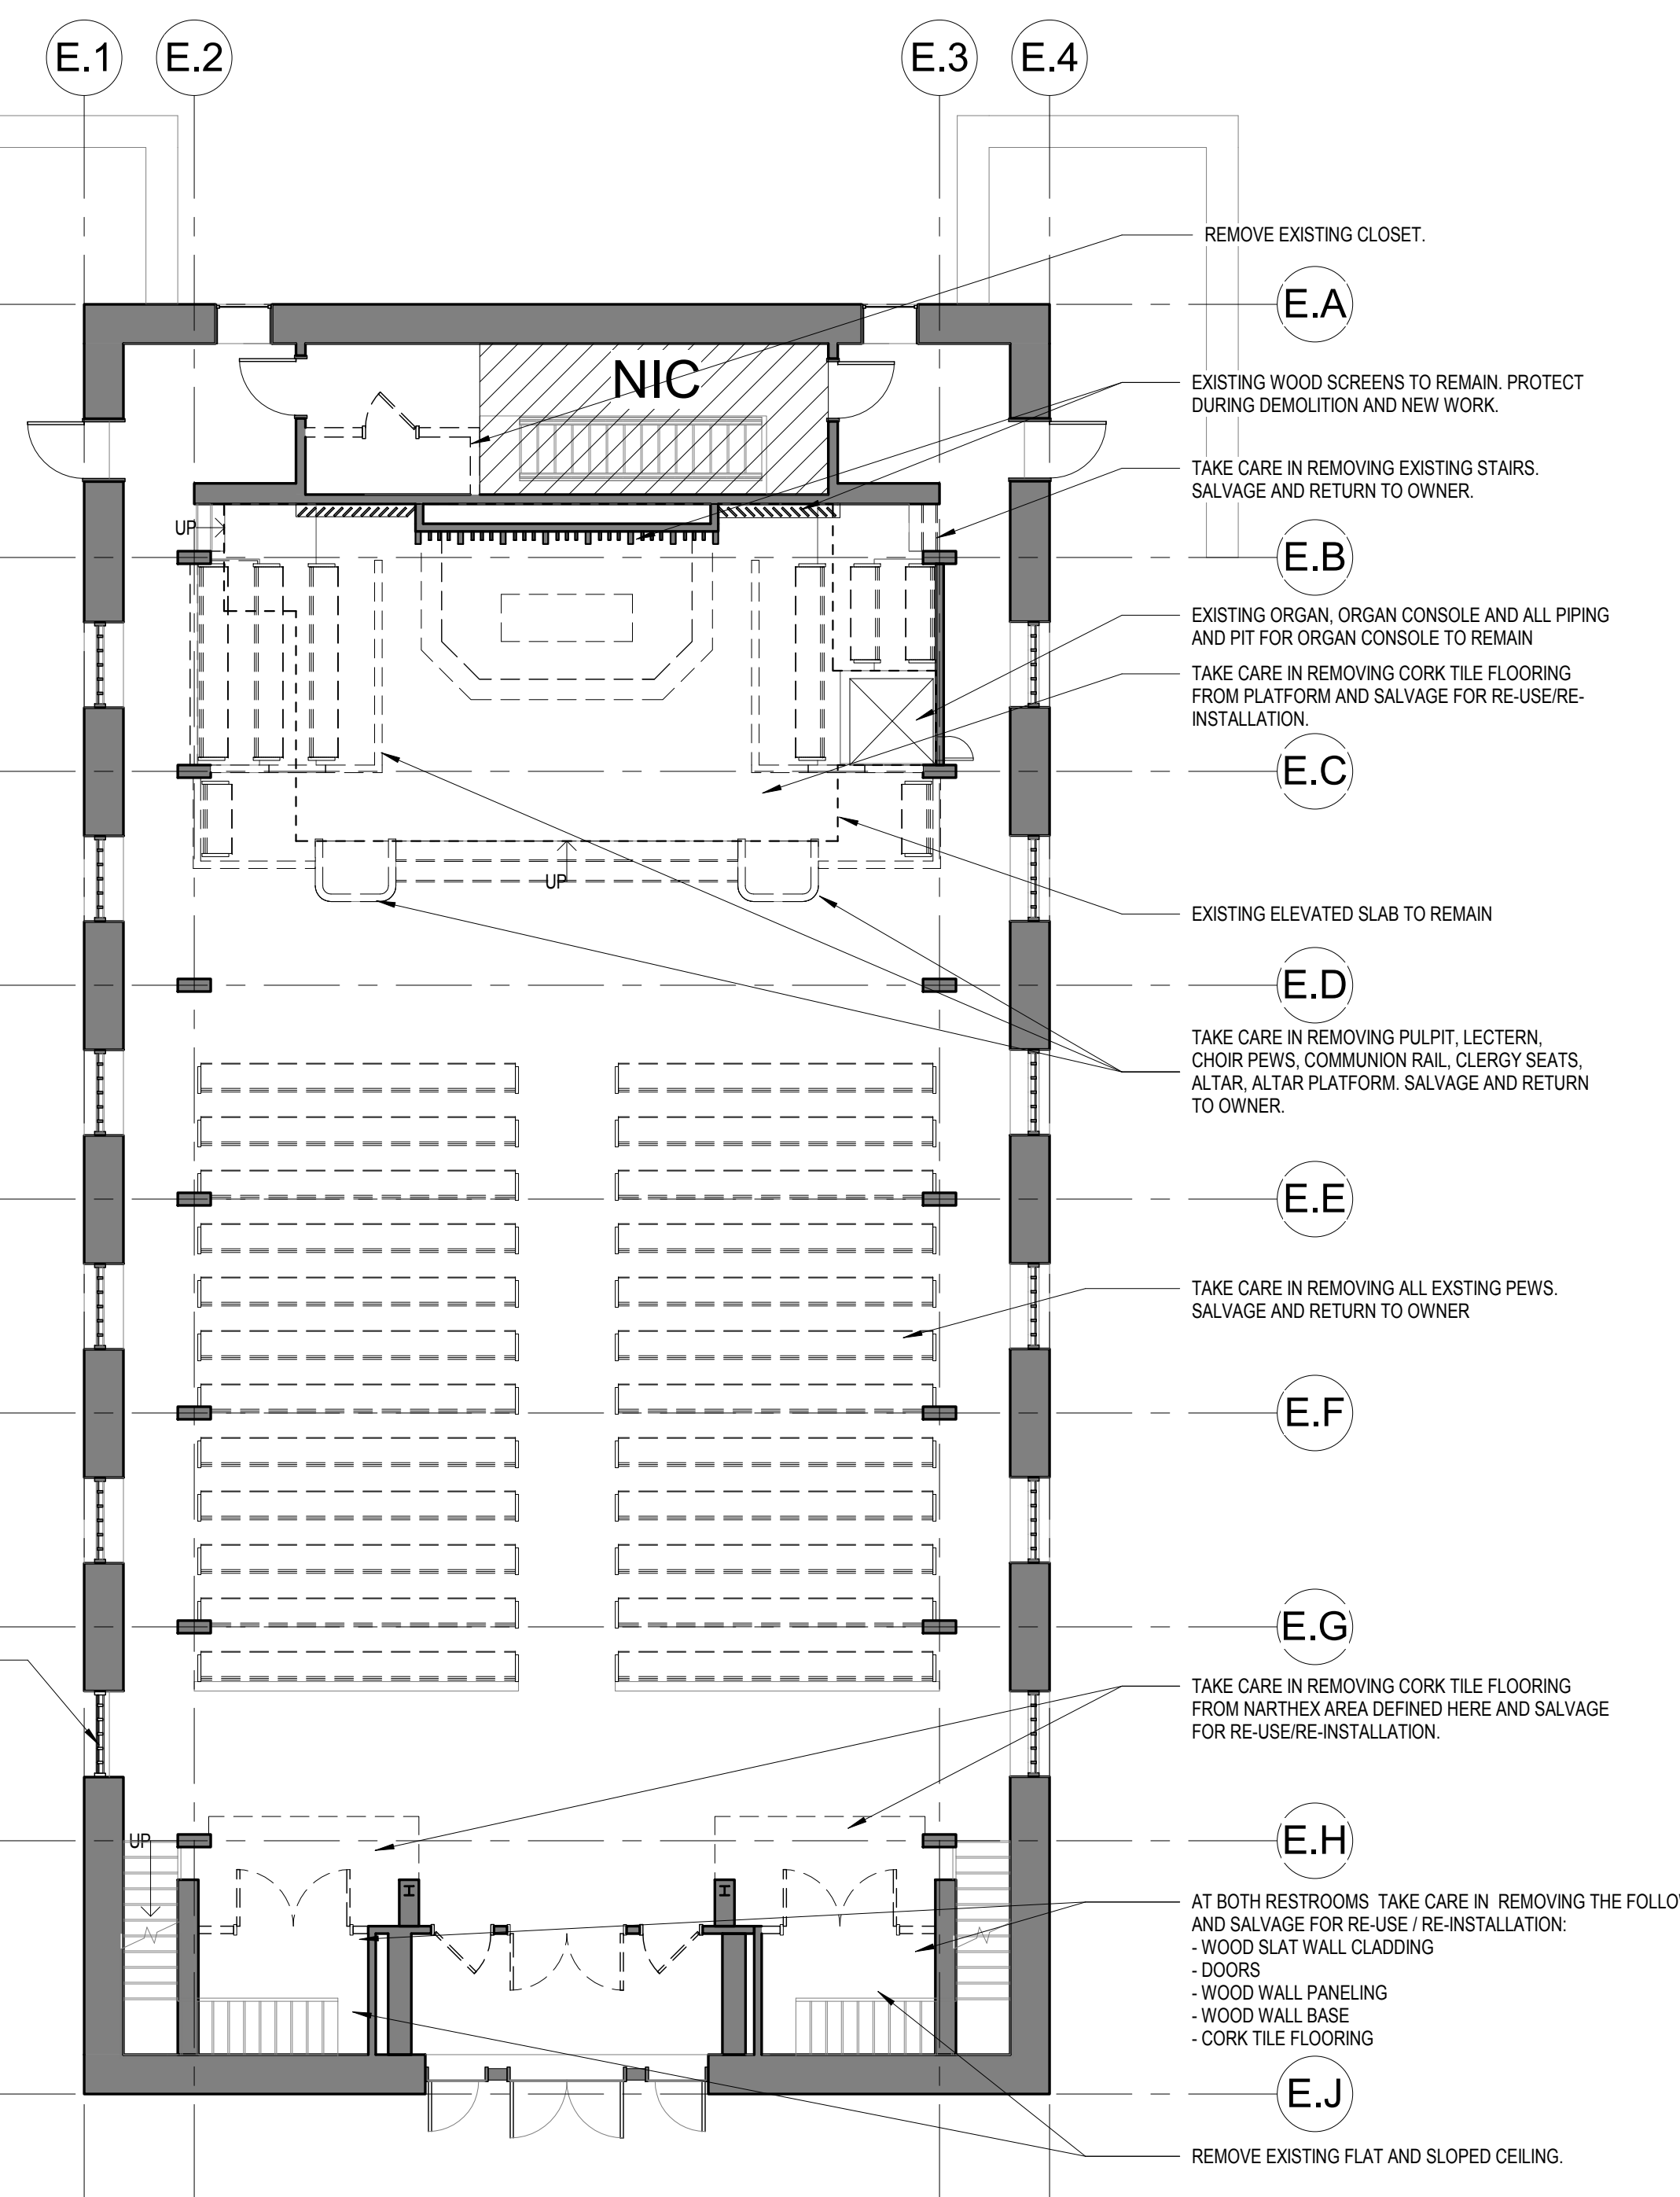
PROJECT DESIGN PHASE
50% CONSTRUCTION DOCUMENTS

DRAWING NAME
SELECTIVE DEMOLITION PLANS

DRAWING NUMBER
A1.10



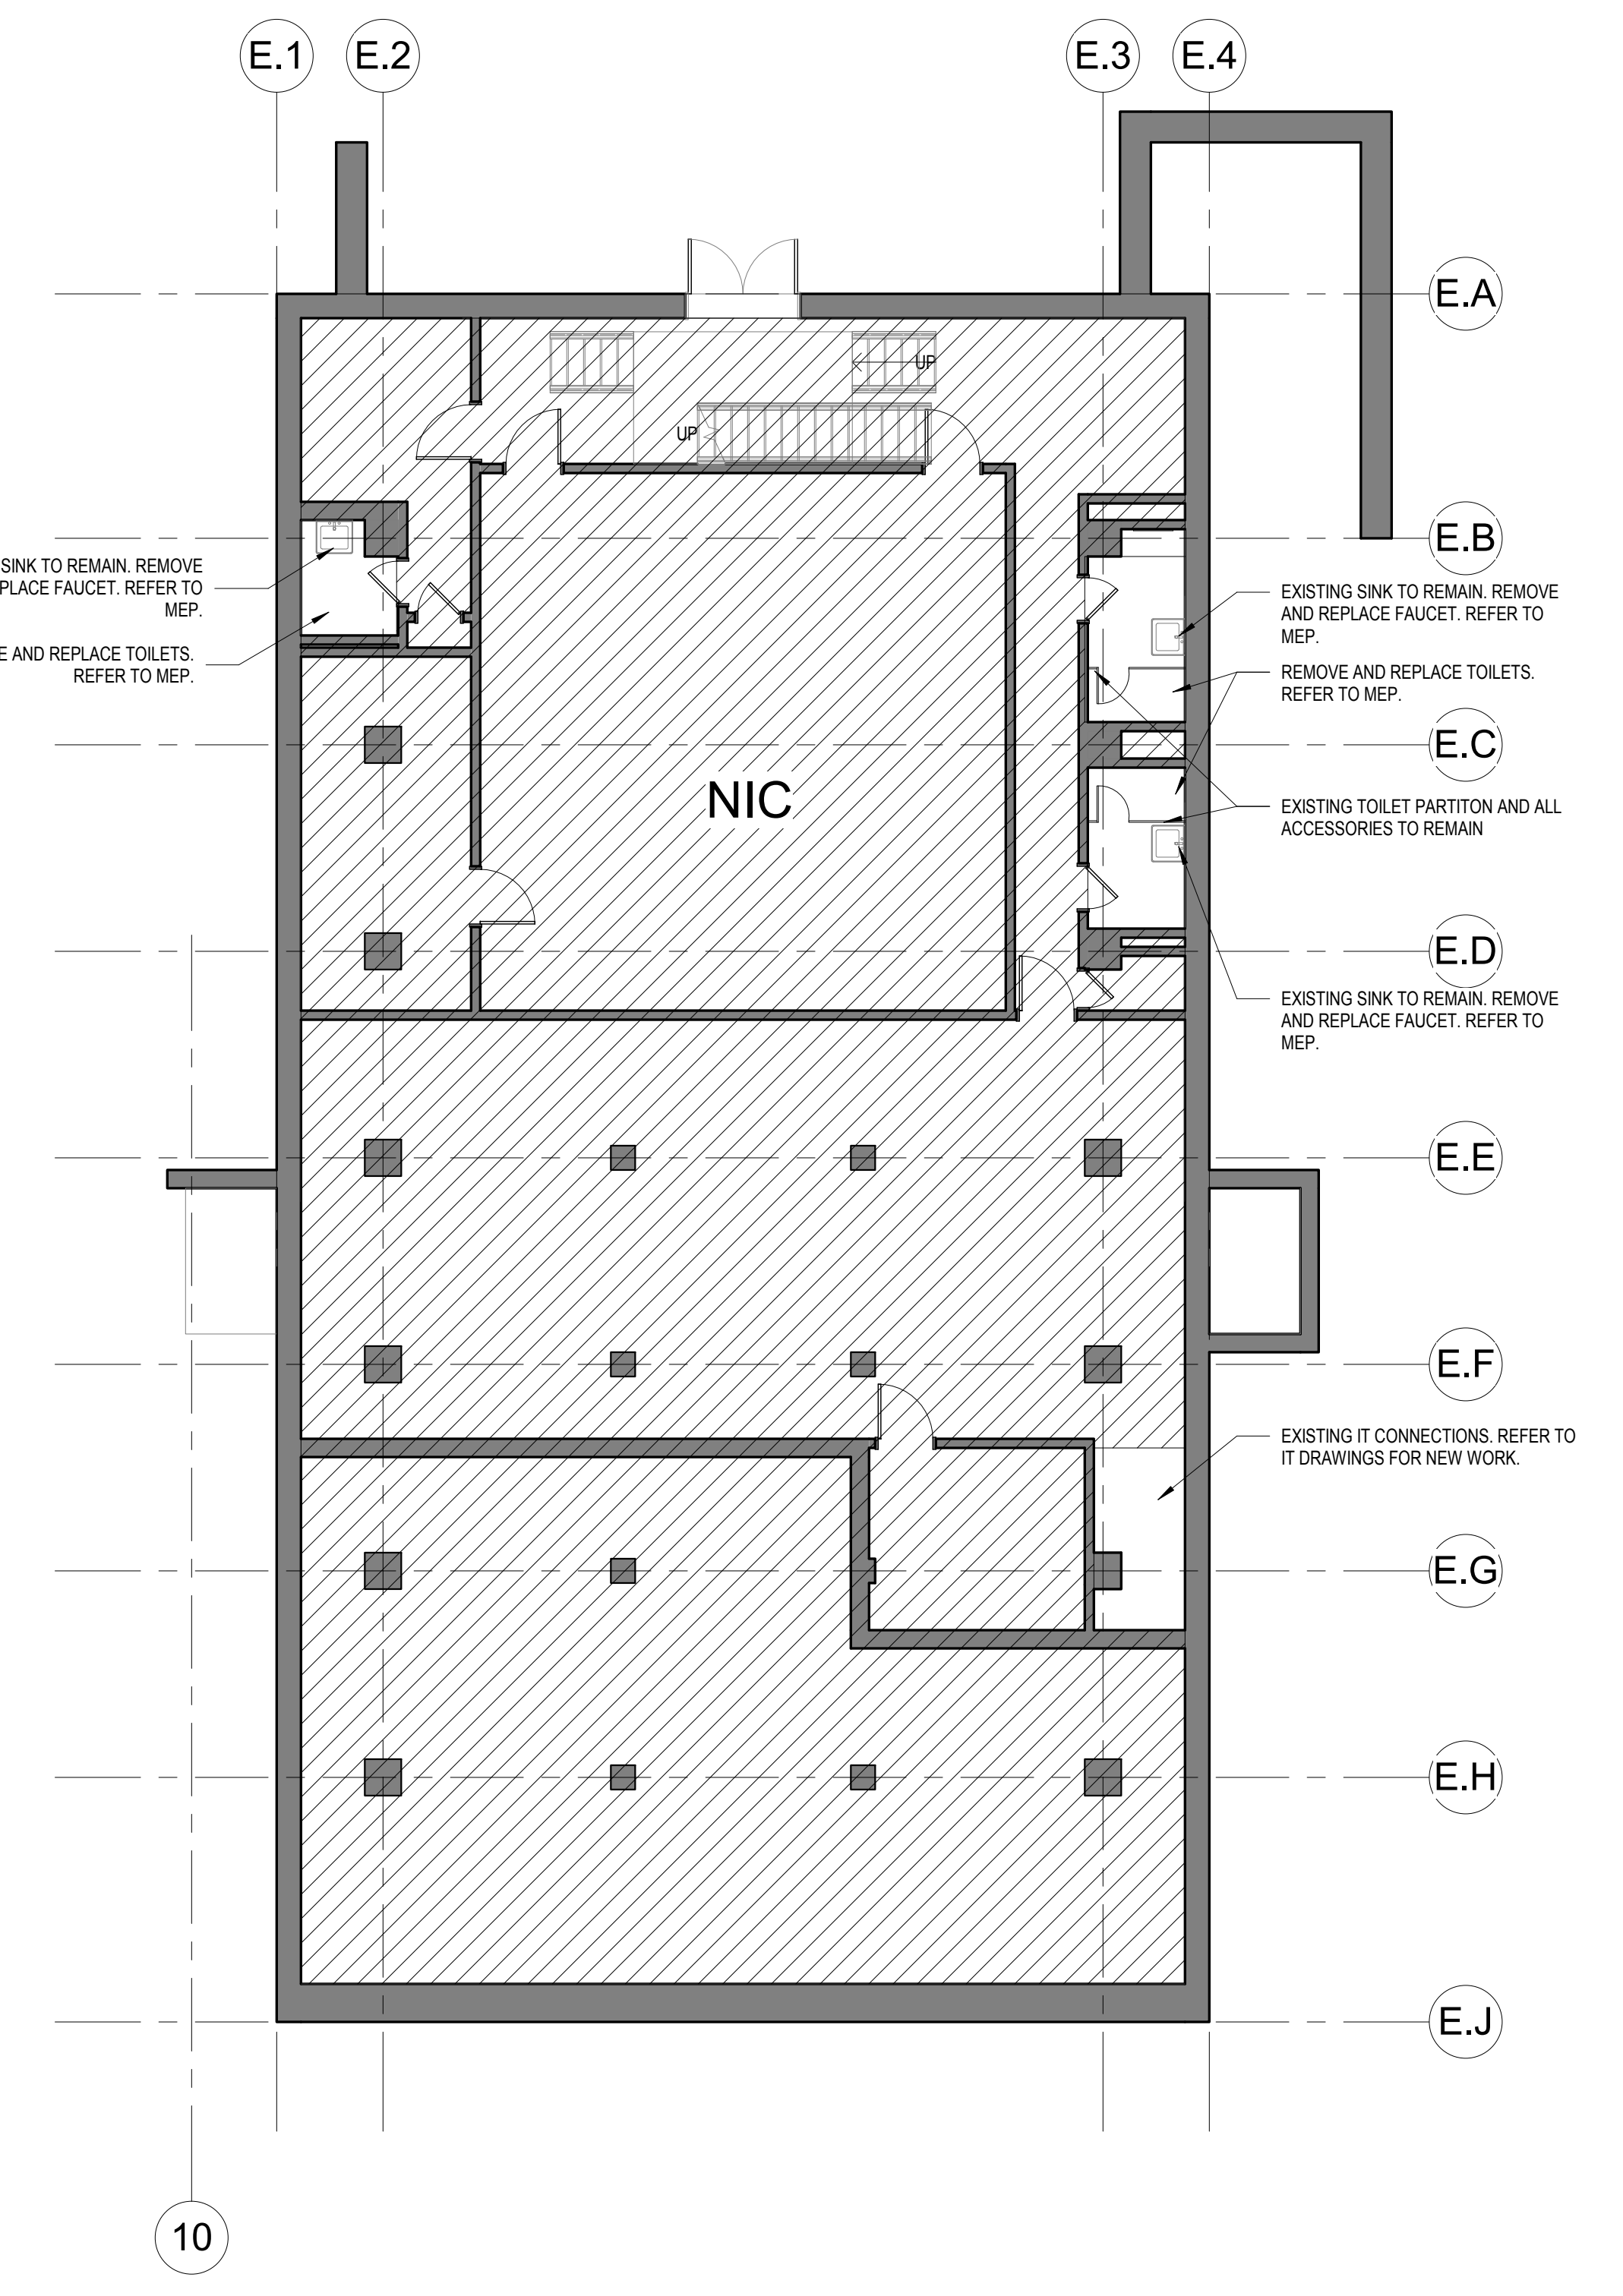
7G WINDOW
1/4" = 1'-0"



7A DEMOLITION - LEVEL 1
1/8" = 1'-0"

DEMOLITION GENERAL NOTES


- 1. DEMOLITION PLANS ARE PROVIDED FOR THE SOLE BENEFIT OF THE CONTRACTOR AND SHALL NOT DETERMINE THE TOTAL SCOPE OR LIMITS OF DEMOLITION...
2. ALL DEMOLITION WORK SHALL BE DONE IN ACCORDANCE WITH STATE AND LOCAL REGULATIONS AND CODES...
3. WHERE DEMOLITION IS REQUIRED, BUT NOT INDICATED FOR INSTALLATION OF NEW WORK INDICATED, DEMOLITION SHALL BE COMPLETED AS F. INDICATED, AT NO ADDITIONAL COST TO THE OWNER...
19. DO NOT REMOVE EXISTING COLUMNS WITHOUT CROSS REFERENCING STRUCTURAL PLANS. IF A DISCREPANCY EXIST BETWEEN PLANS CONTACT ARCHITECT PRIOR REMOVAL.



3A DEMOLITION PLAN - CHAPEL BASEMENT
1/8" = 1'-0"

REVISIONS		
REV. #	DESCRIPTION	DATE

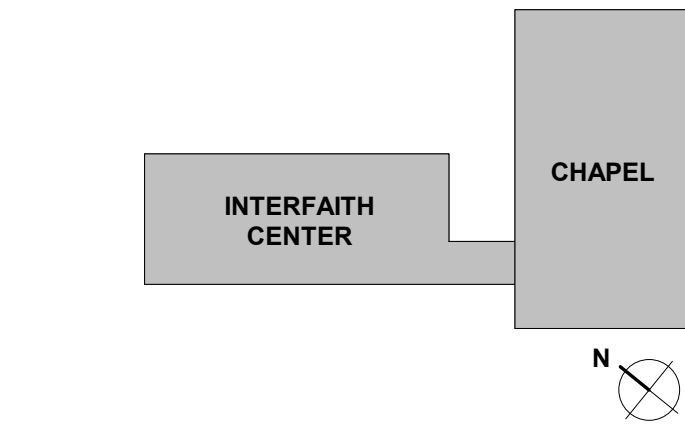KEY PLAN



ARCHITECTS + PLANNERS


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ISSUE DATE:	04/28/17
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DRAWN BY:	ASG


PROJECT DESIGN PHASE
50% CONSTRUCTION DOCUMENTS

DRAWING NAME
FLOOR PLAN - LOWER LEVEL & LEVEL 1

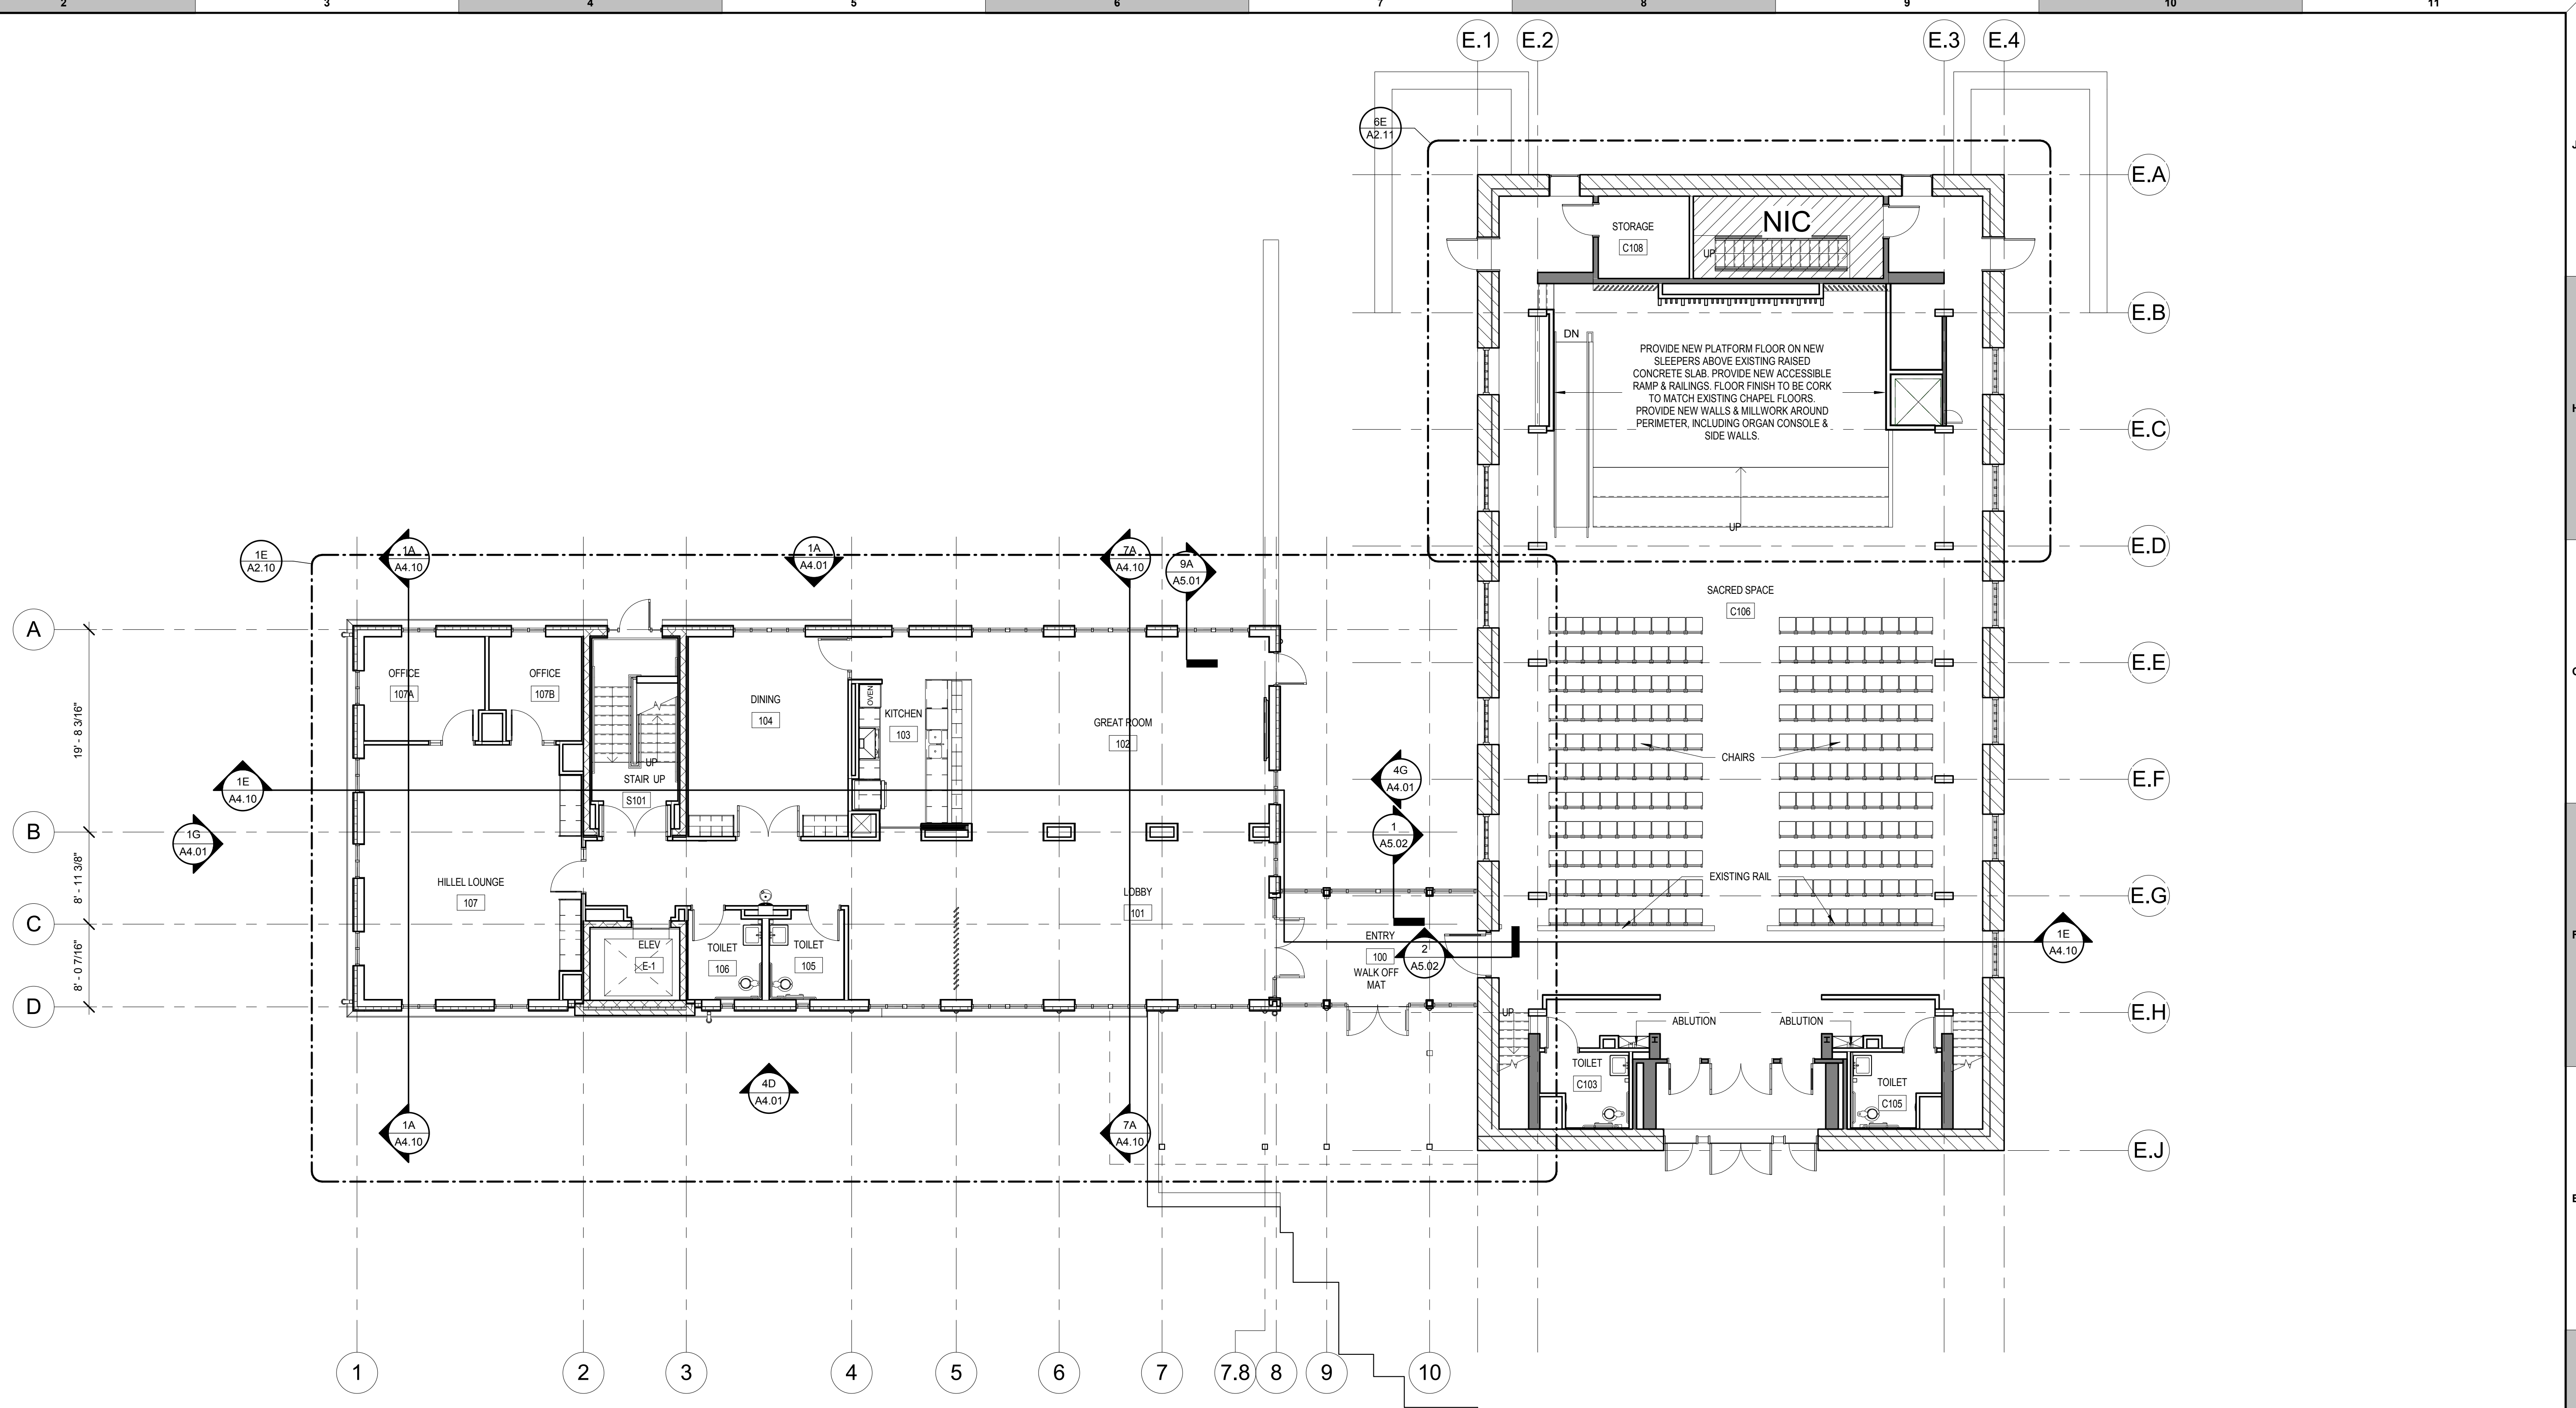DRAWING NUMBER
A2.00



1D LEVEL 1 FLOOR - PLAN
1/8" = 1'-0"

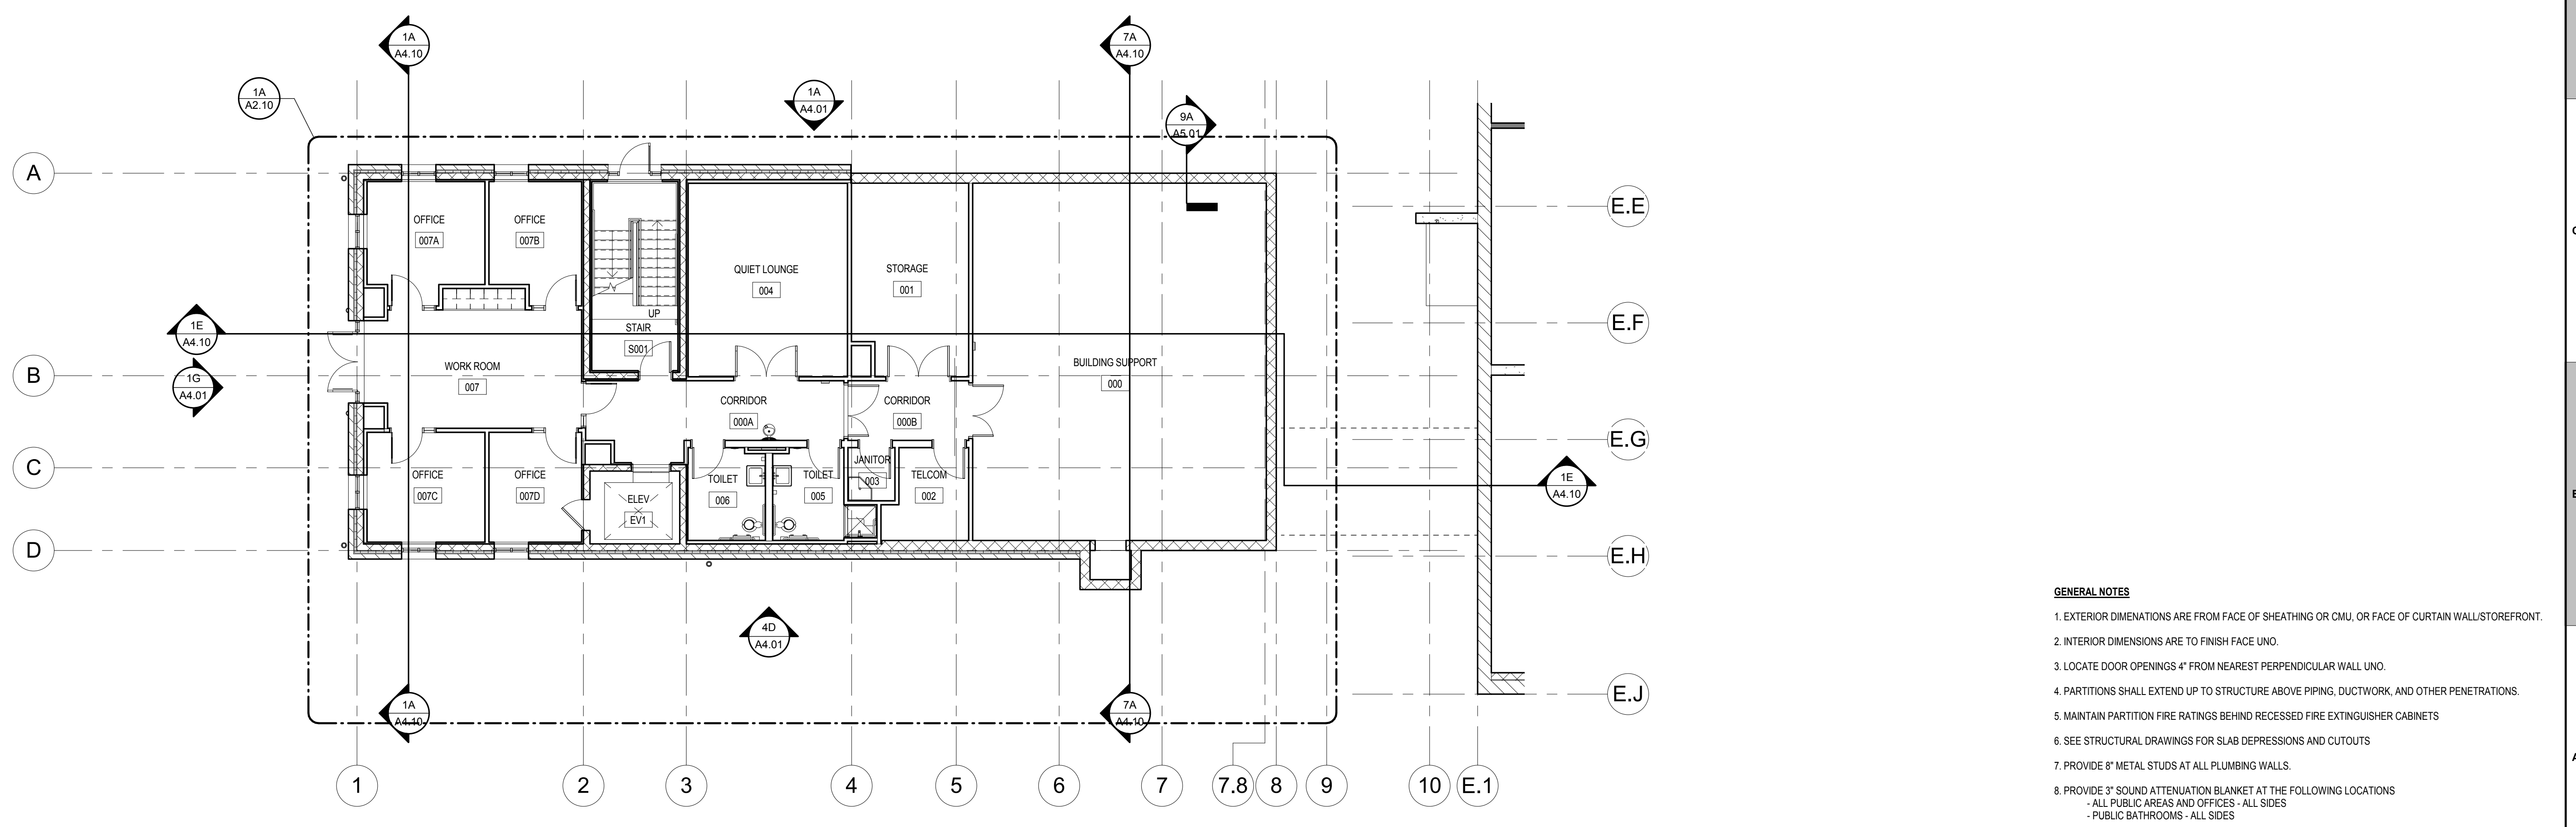

1A LOWER LEVEL - PLAN
1/8" = 1'-0"

- GENERAL NOTES**
- EXTERIOR DIMENSIONS ARE FROM FACE OF SHEATHING OR CMU, OR FACE OF CURTAIN WALL/STOREFRONT.
 - INTERIOR DIMENSIONS ARE TO FINISH FACE UNO.
 - LOCATE DOOR OPENINGS 4" FROM NEAREST PERPENDICULAR WALL UNO.
 - PARTITIONS SHALL EXTEND UP TO STRUCTURE ABOVE PIPING, DUCTWORK, AND OTHER PENETRATIONS.
 - MAINTAIN PARTITION FIRE RATINGS BEHIND RECESSED FIRE EXTINGUISHER CABINETS
 - SEE STRUCTURAL DRAWINGS FOR SLAB DEPRESSIONS AND CUTOUTS
 - PROVIDE 8" METAL STUDS AT ALL PLUMBING WALLS.
 - PROVIDE 3" SOUND ATTENUATION BLANKET AT THE FOLLOWING LOCATIONS
- ALL PUBLIC AREAS AND OFFICES - ALL SIDES
- PUBLIC BATHROOMS - ALL SIDES
 - INSTALL BLOCKING IN PARTITIONS FOR ALL CASEWORK, WALL-MOUNTED EQUIPMENT, TRIM, GRAB BARS, ETC.
 - SEE LIFE SAFETY PLANS FOR REQUIRED HOUR FIRE SEPARATIONS.

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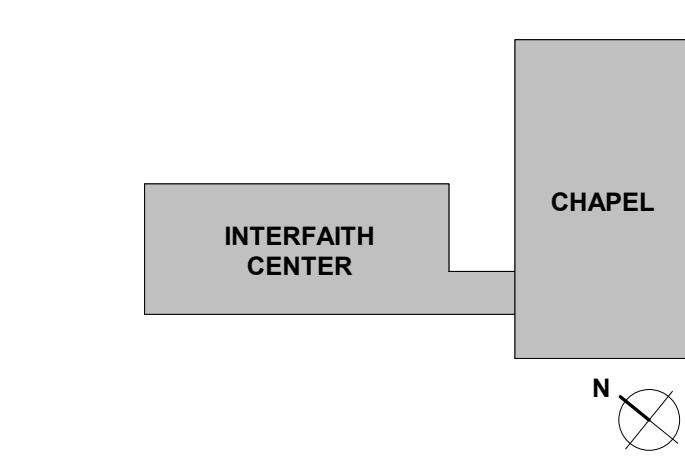
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REVISIONS		
REV. #	DESCRIPTION	DATE

KEY PLAN



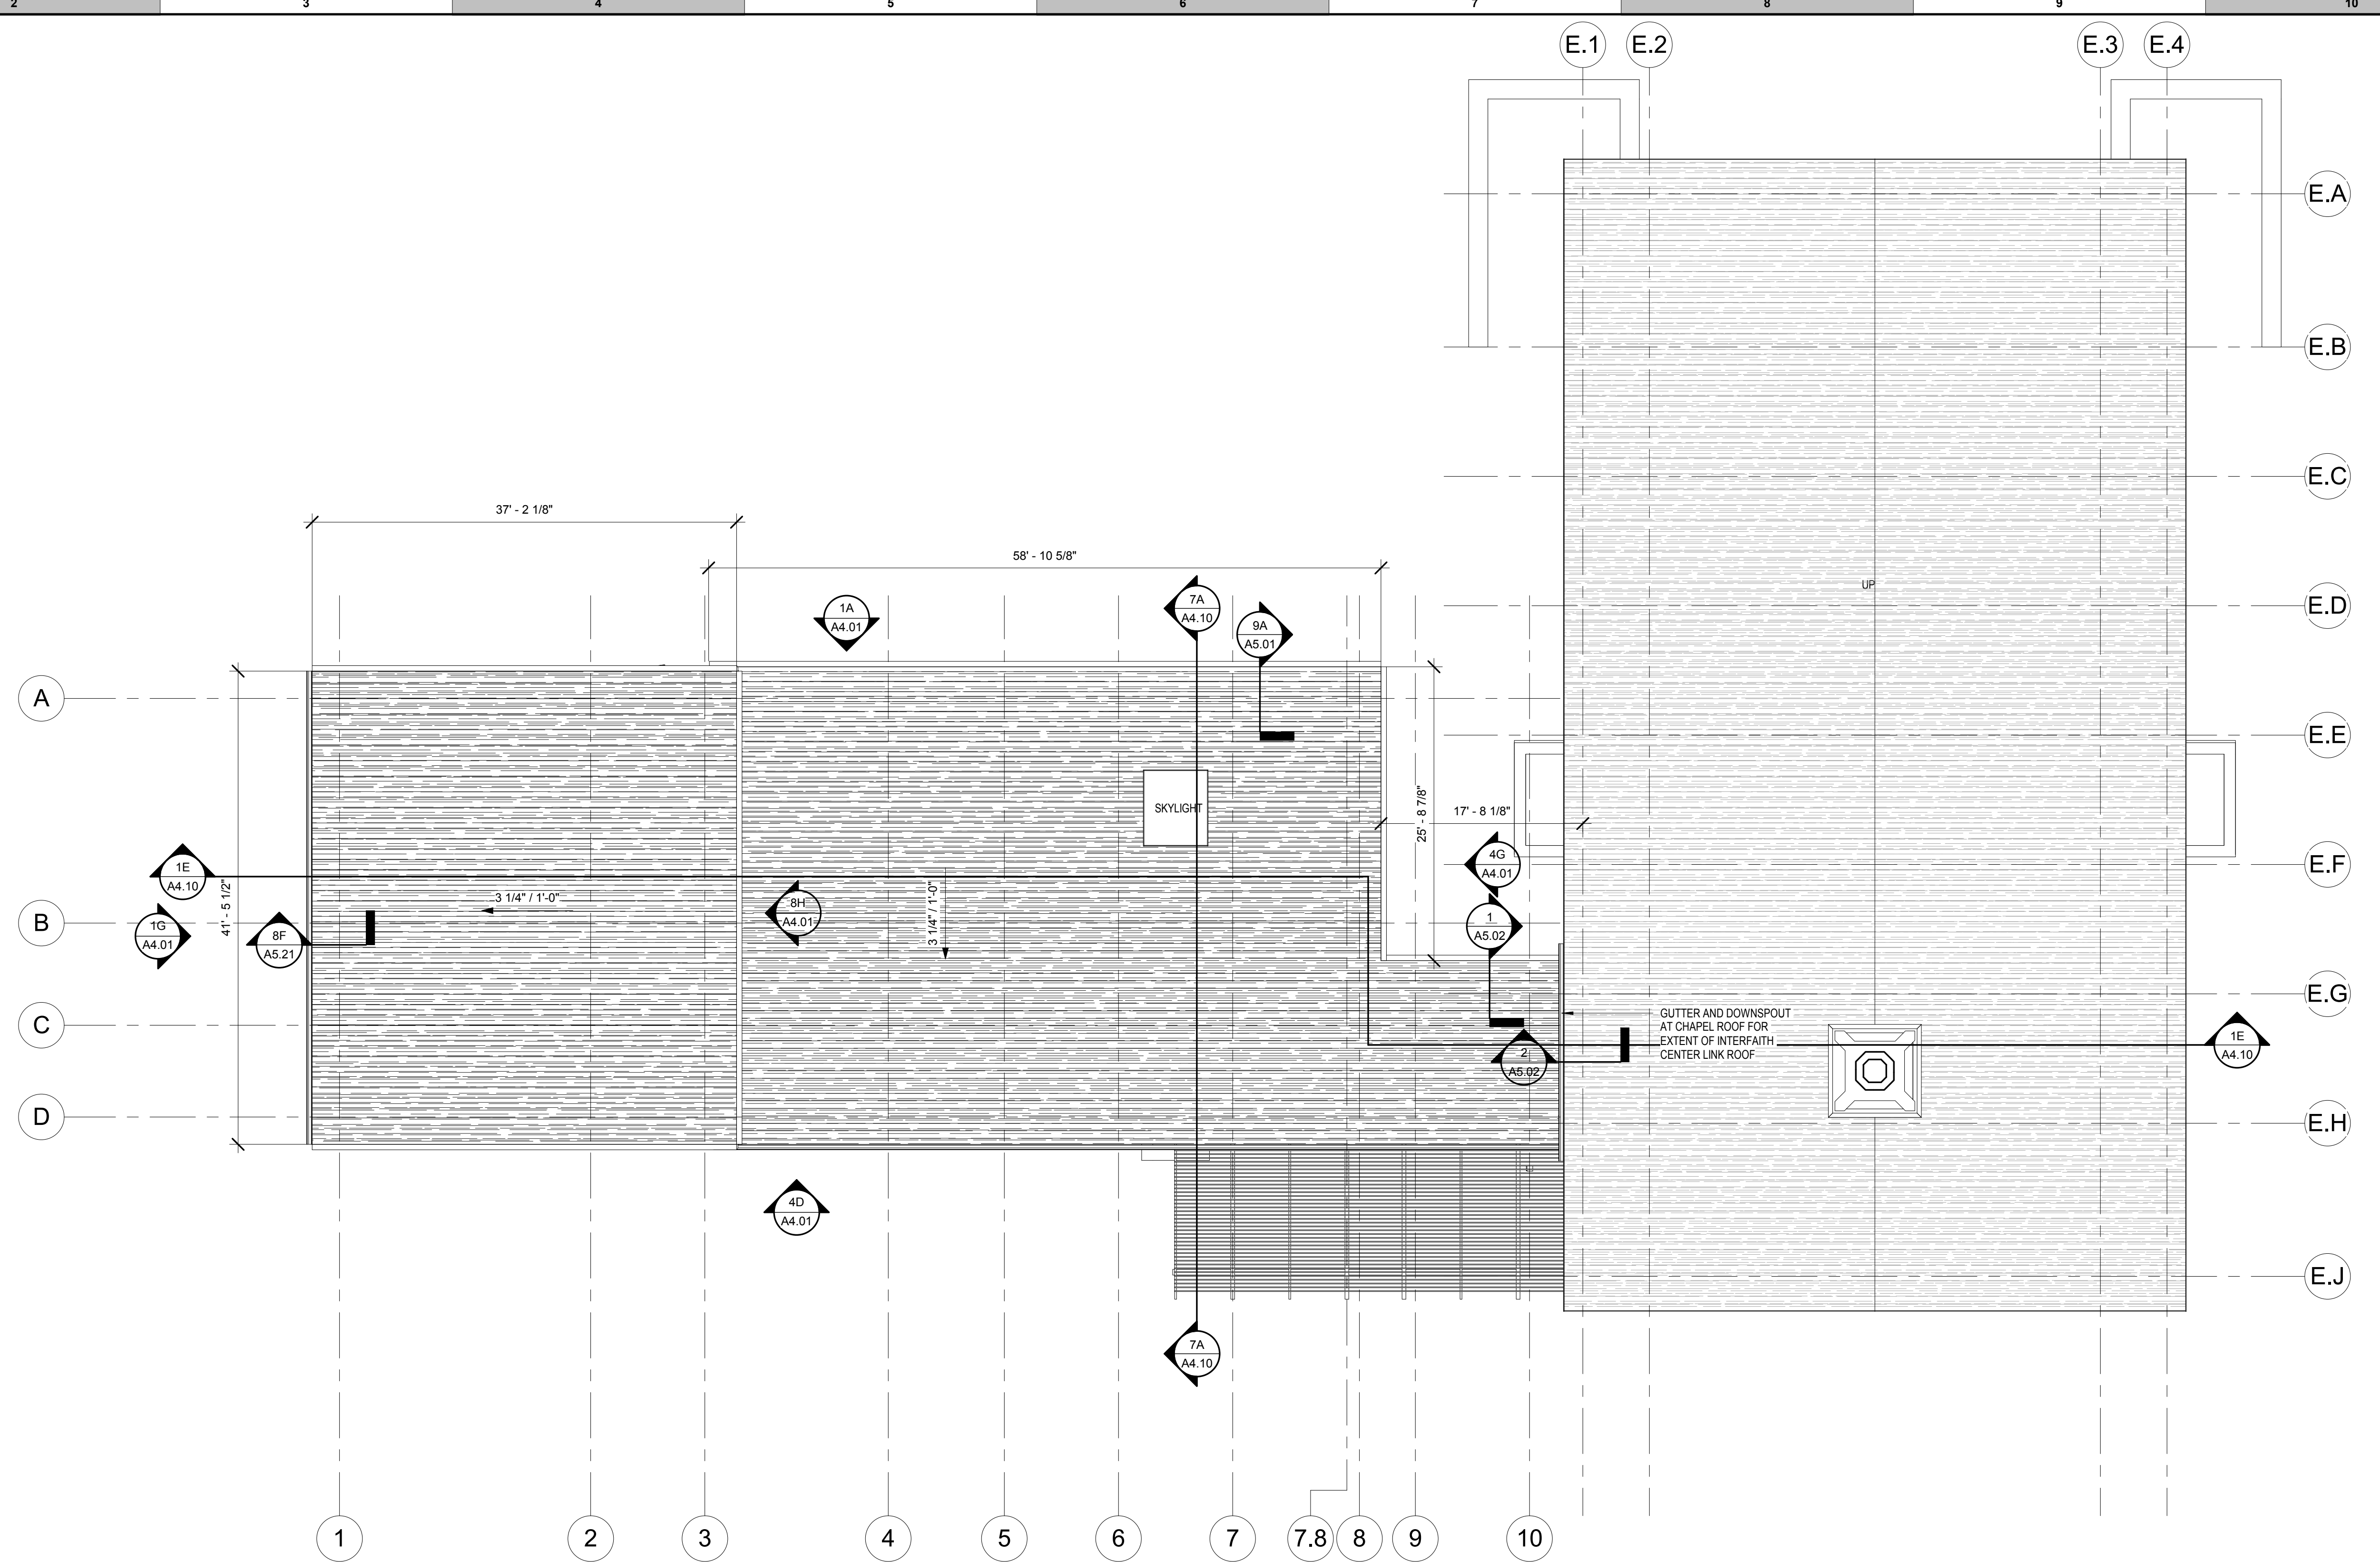
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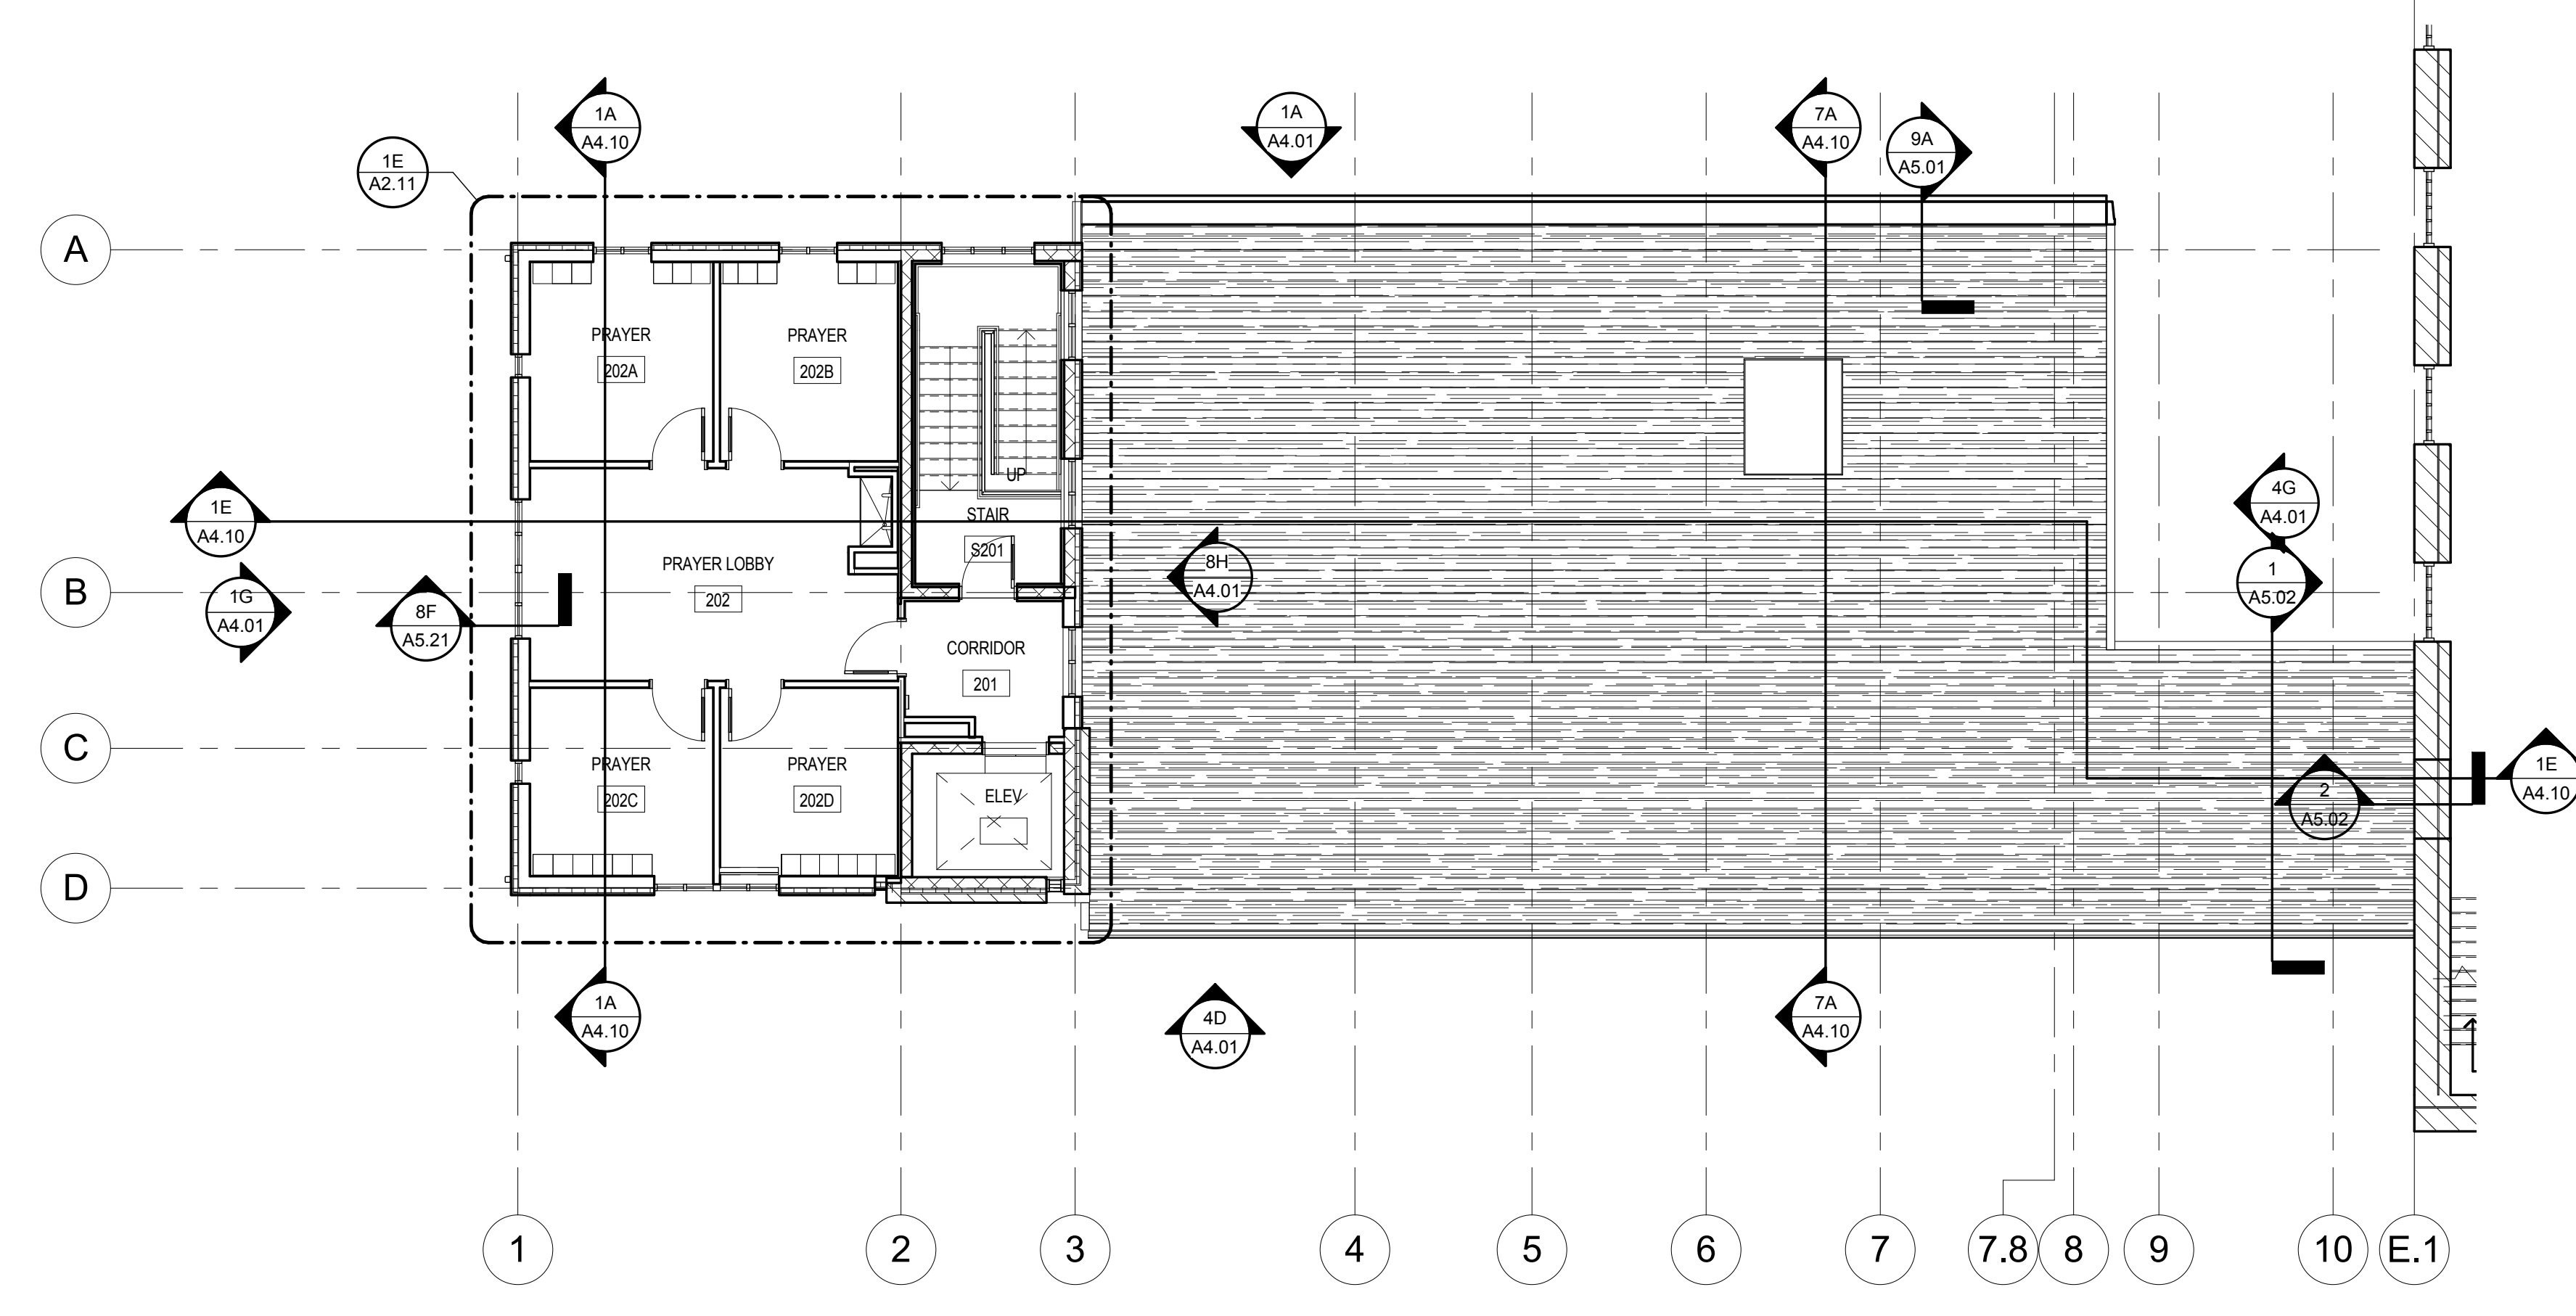
PROJECT DESIGN PHASE
50% CONSTRUCTION DOCUMENTS

DRAWING NAME
FLOOR PLAN - LEVEL 2 & ROOF

DRAWING NUMBER
A2.01



1D ROOF PLAN
1/8" = 1'-0"




1A LEVEL 2 FLOOR - PLAN
1/8" = 1'-0"

GENERAL NOTES

- EXTERIOR DIMENSIONS ARE FROM FACE OF SHEATHING OR CMU, OR FACE OF CURTAIN WALL/STOREFRONT.
- INTERIOR DIMENSIONS ARE TO FINISH FACE UNO.
- LOCATE DOOR OPENINGS 4" FROM NEAREST PERPENDICULAR WALL UNO.
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REVISIONS		
REV. #	DESCRIPTION	DATE

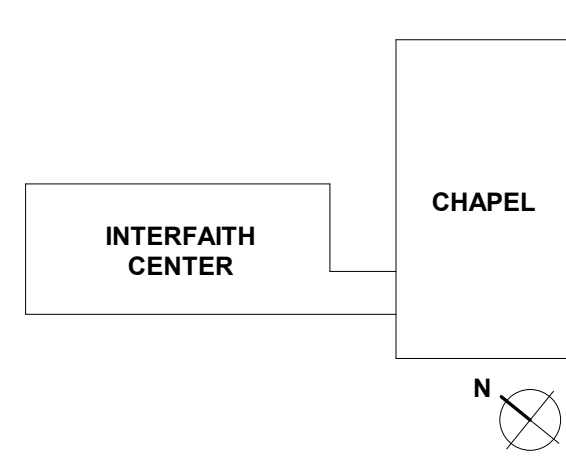KEY PLAN




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SCALE:	1/4" = 1'-0"
JOB NO.:	21641.00
DRAWN BY:	ASG

PROJECT DESIGN PHASE
50% CONSTRUCTION DOCUMENTS

DRAWING NAME
ENLARGED PLANS - INTERFAITH CENTER BASEMENT & GROUND LEVEL

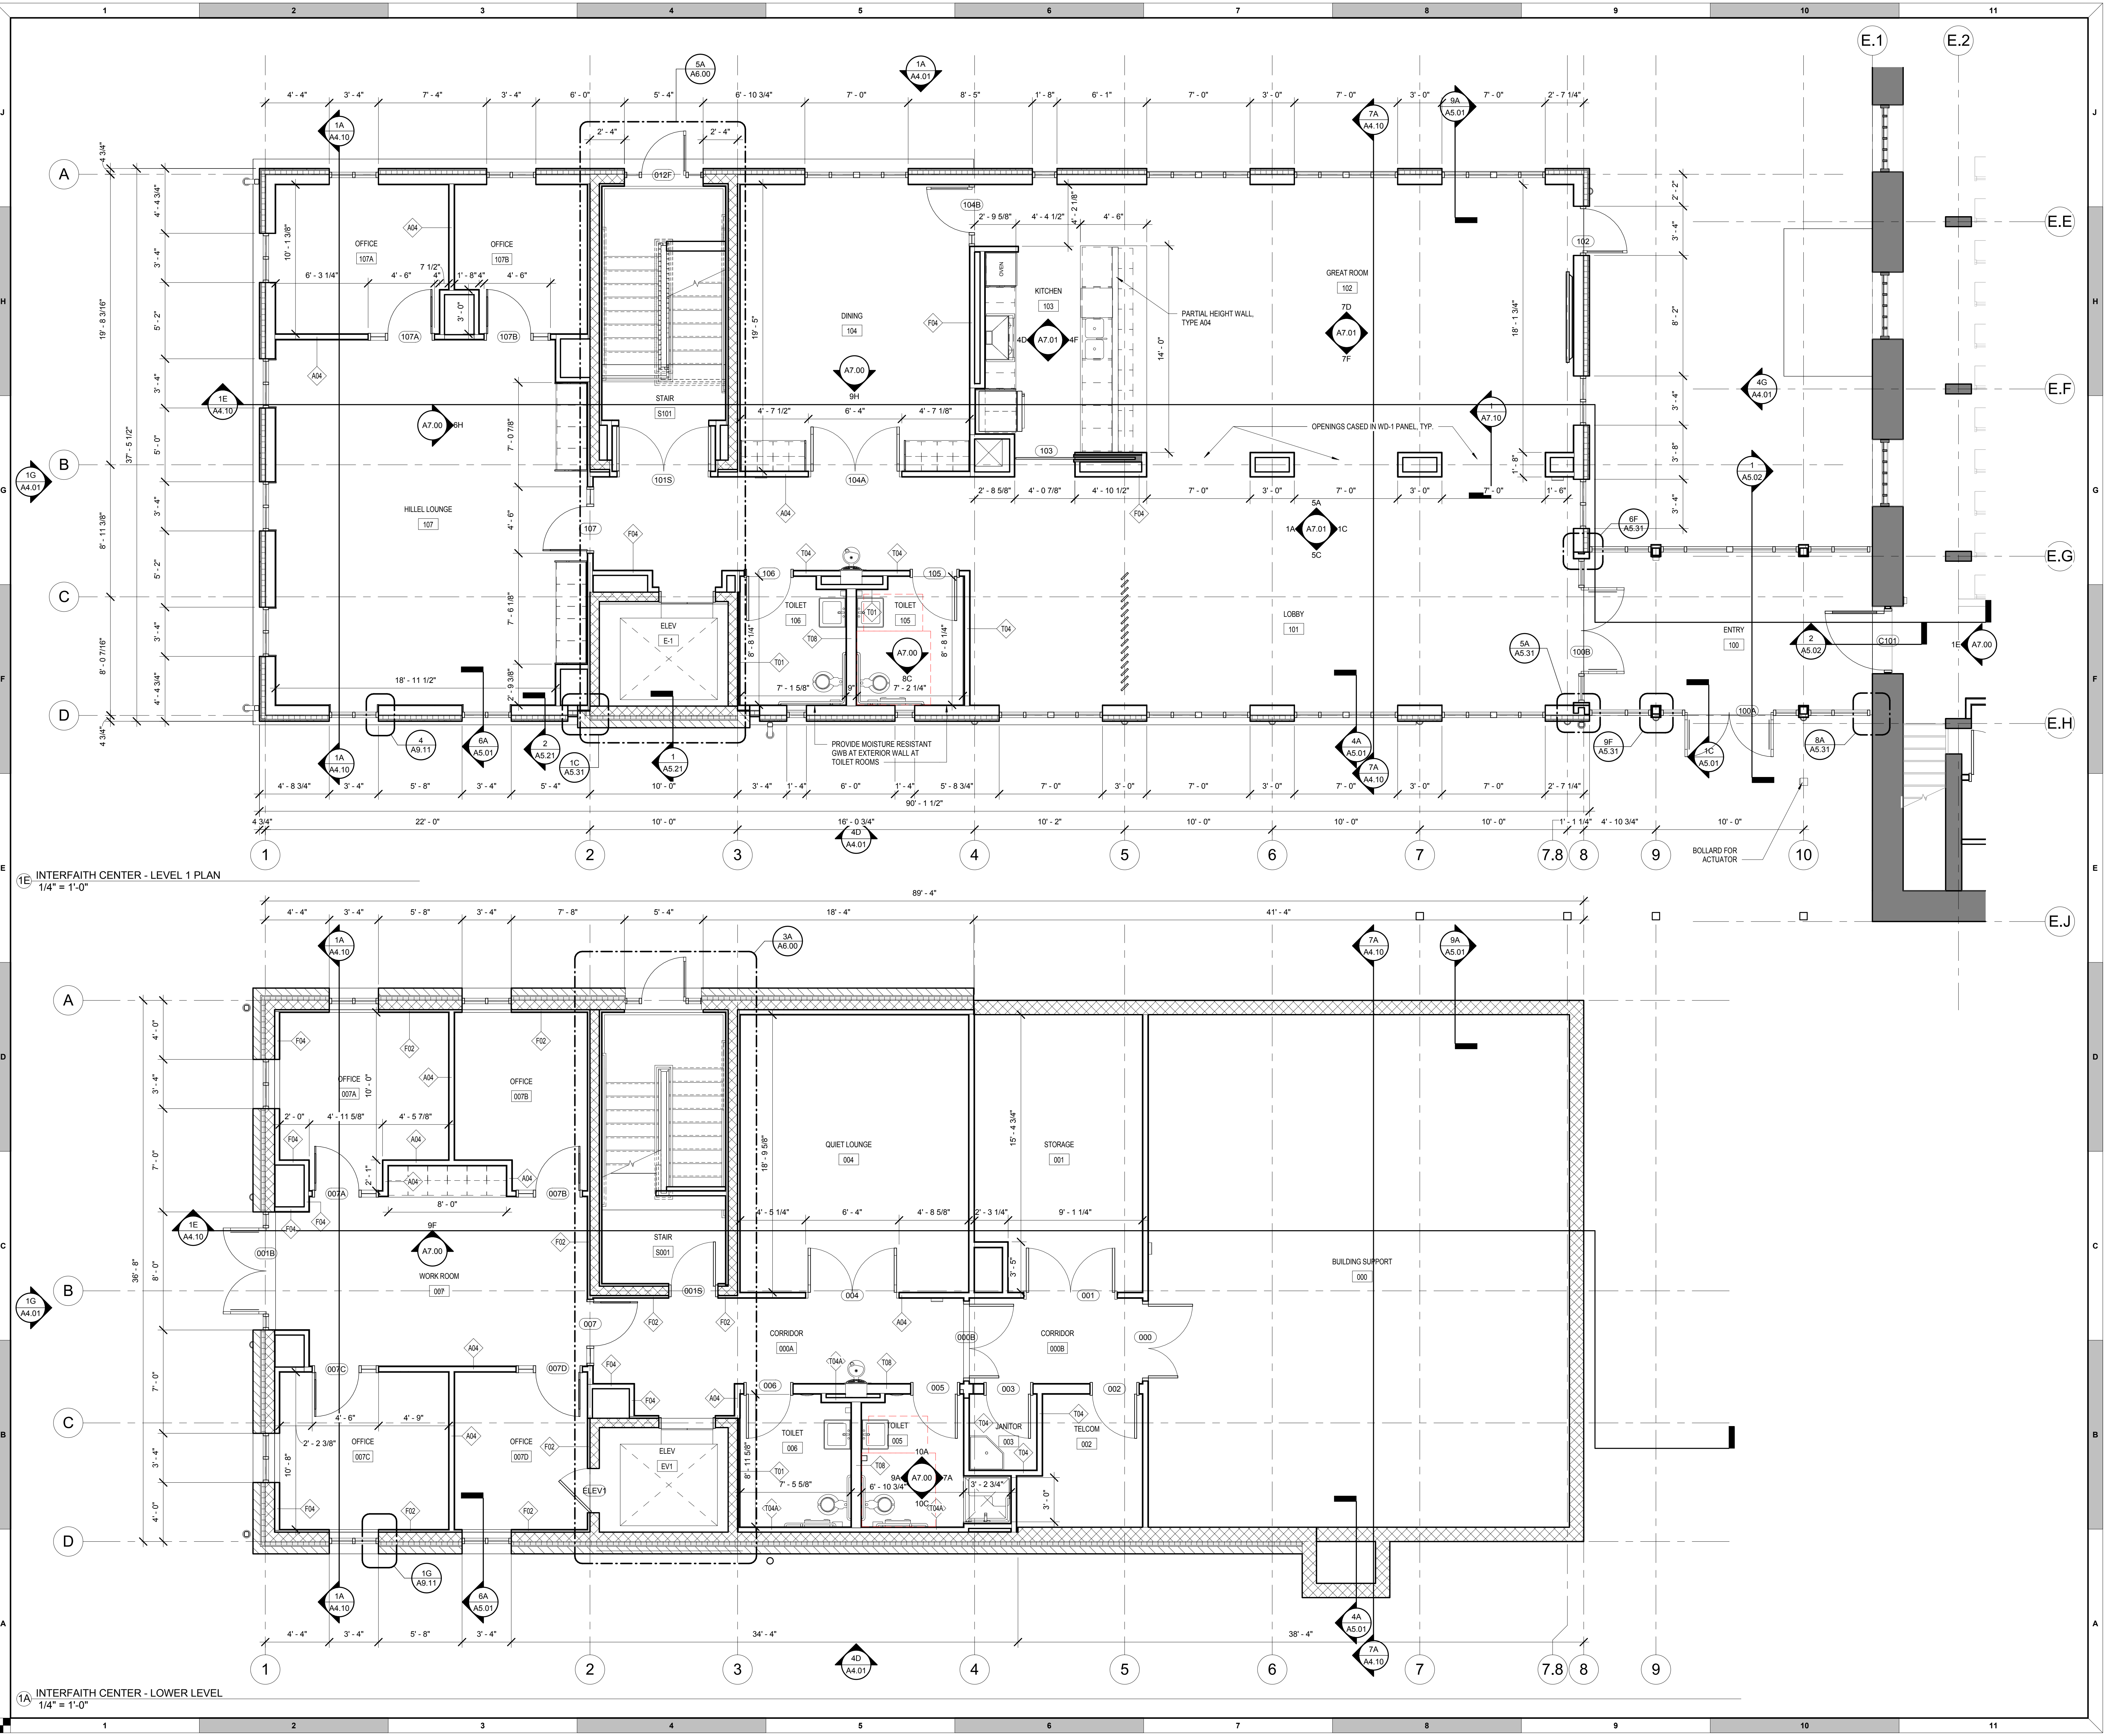DRAWING NUMBER
A2.10



1E INTERFAITH CENTER - LEVEL 1 PLAN
1/4" = 1'-0"


1A INTERFAITH CENTER - LOWER LEVEL
1/4" = 1'-0"

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REVISIONS		
REV. #	DESCRIPTION	DATE

KEY PLAN



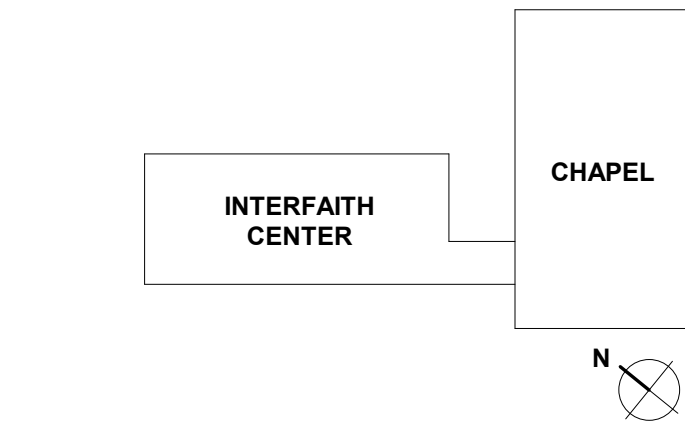ARCHITECTS + PLANNERS


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SCALE:	1/4" = 1'-0"
JOB NO.:	21641.00
DRAWN BY:	ASG


PROJECT DESIGN PHASE
50% CONSTRUCTION DOCUMENTS

DRAWING NAME
ENLARGED PLANS - INTERFAITH CENTER LEVEL 2 & CHAPEL

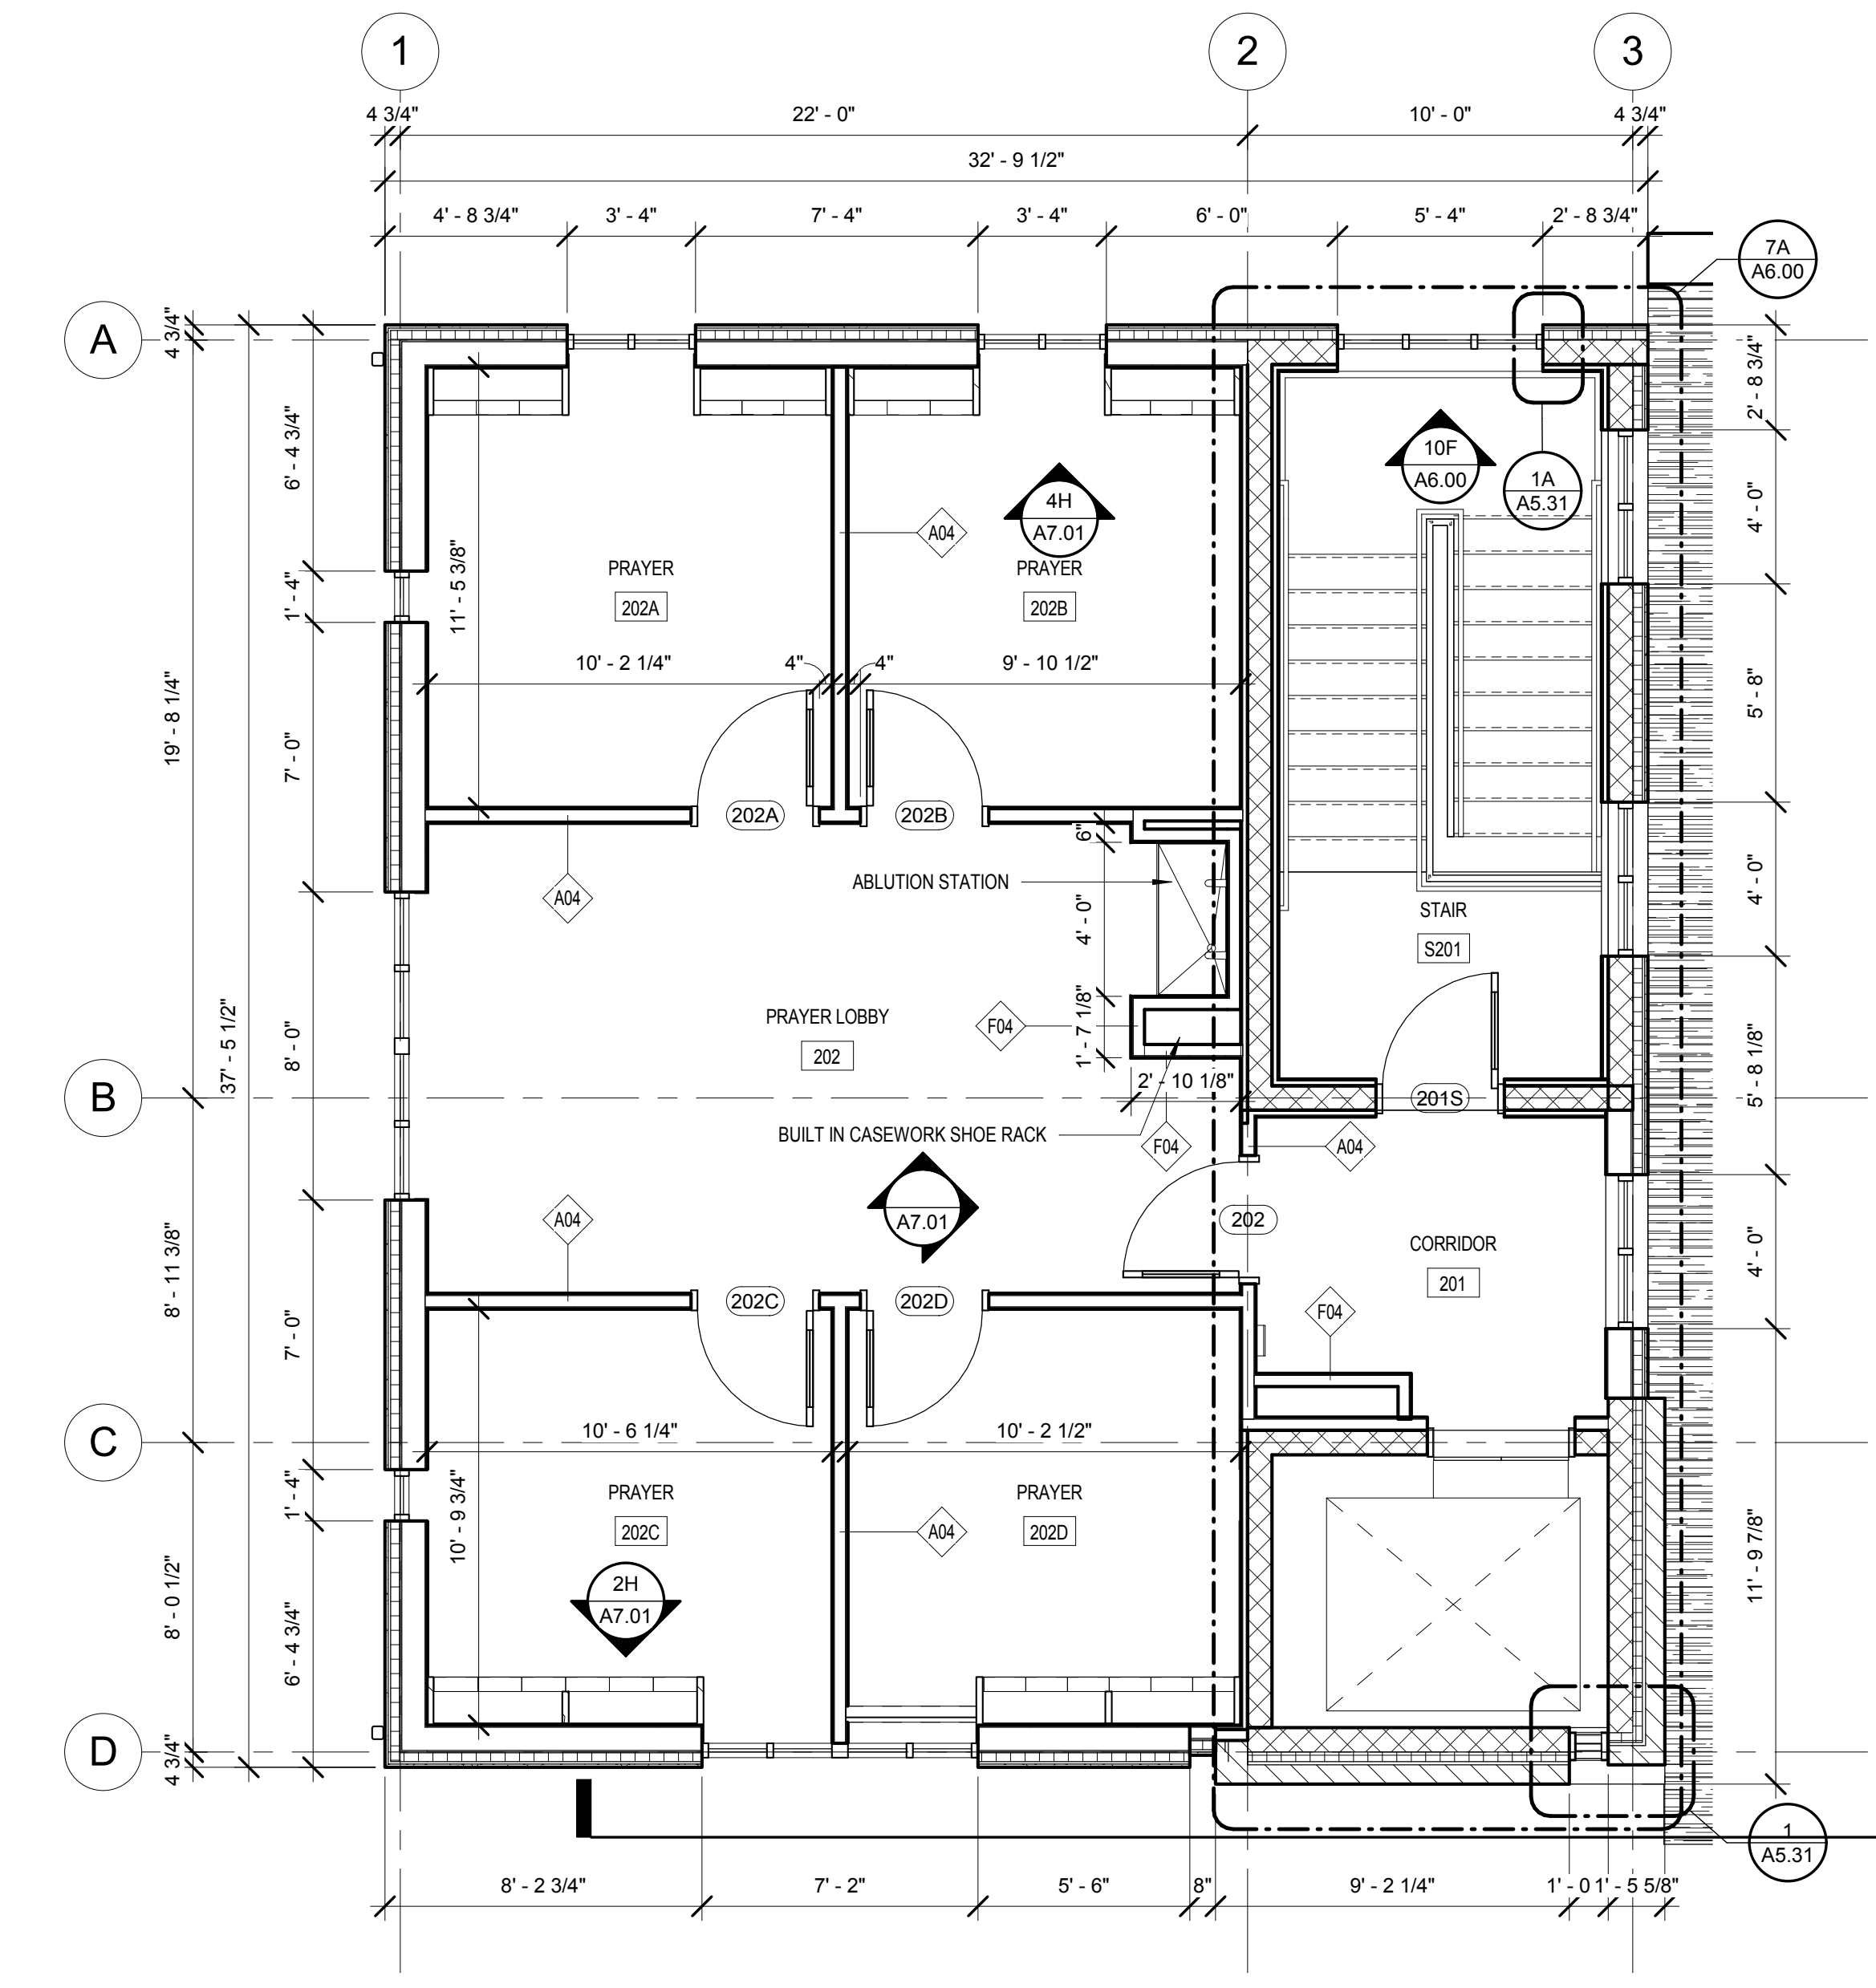
DRAWING NUMBER
A2.11



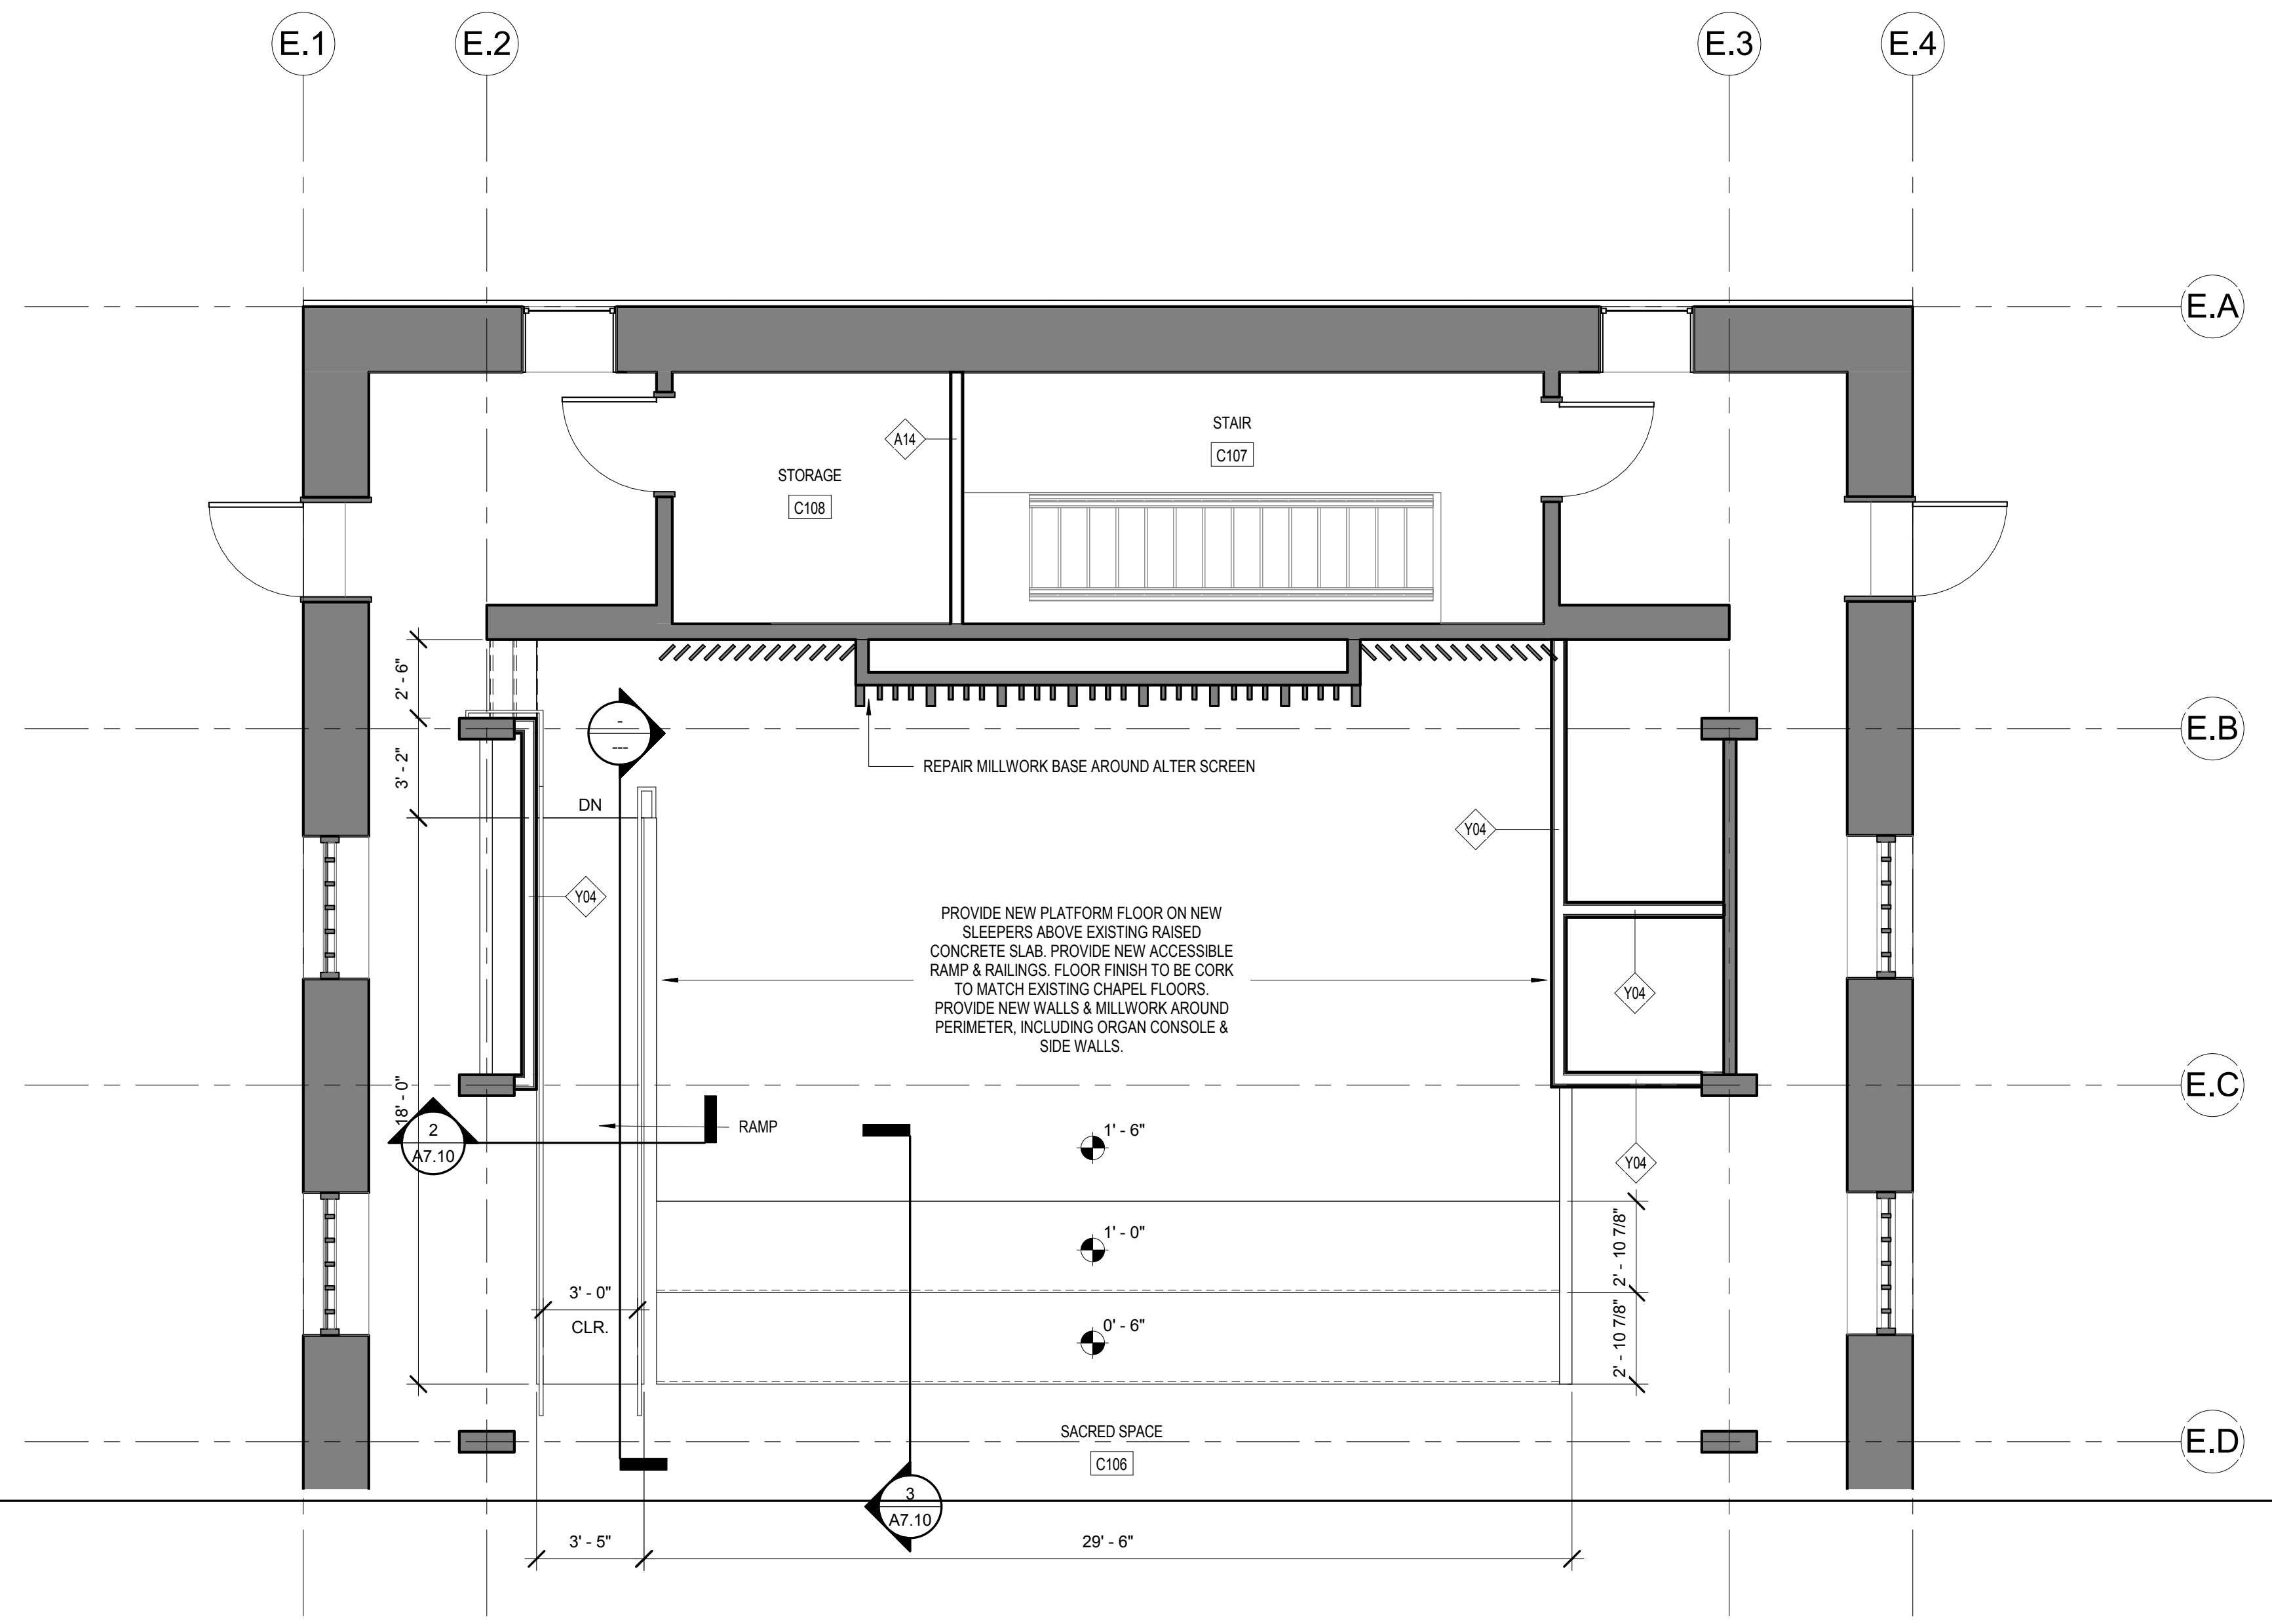1E INTERFAITH CENTER - LEVEL 2
1/4" = 1'-0"




1E CHAPEL - LEVEL 1 ALTER
1/4" = 1'-0"

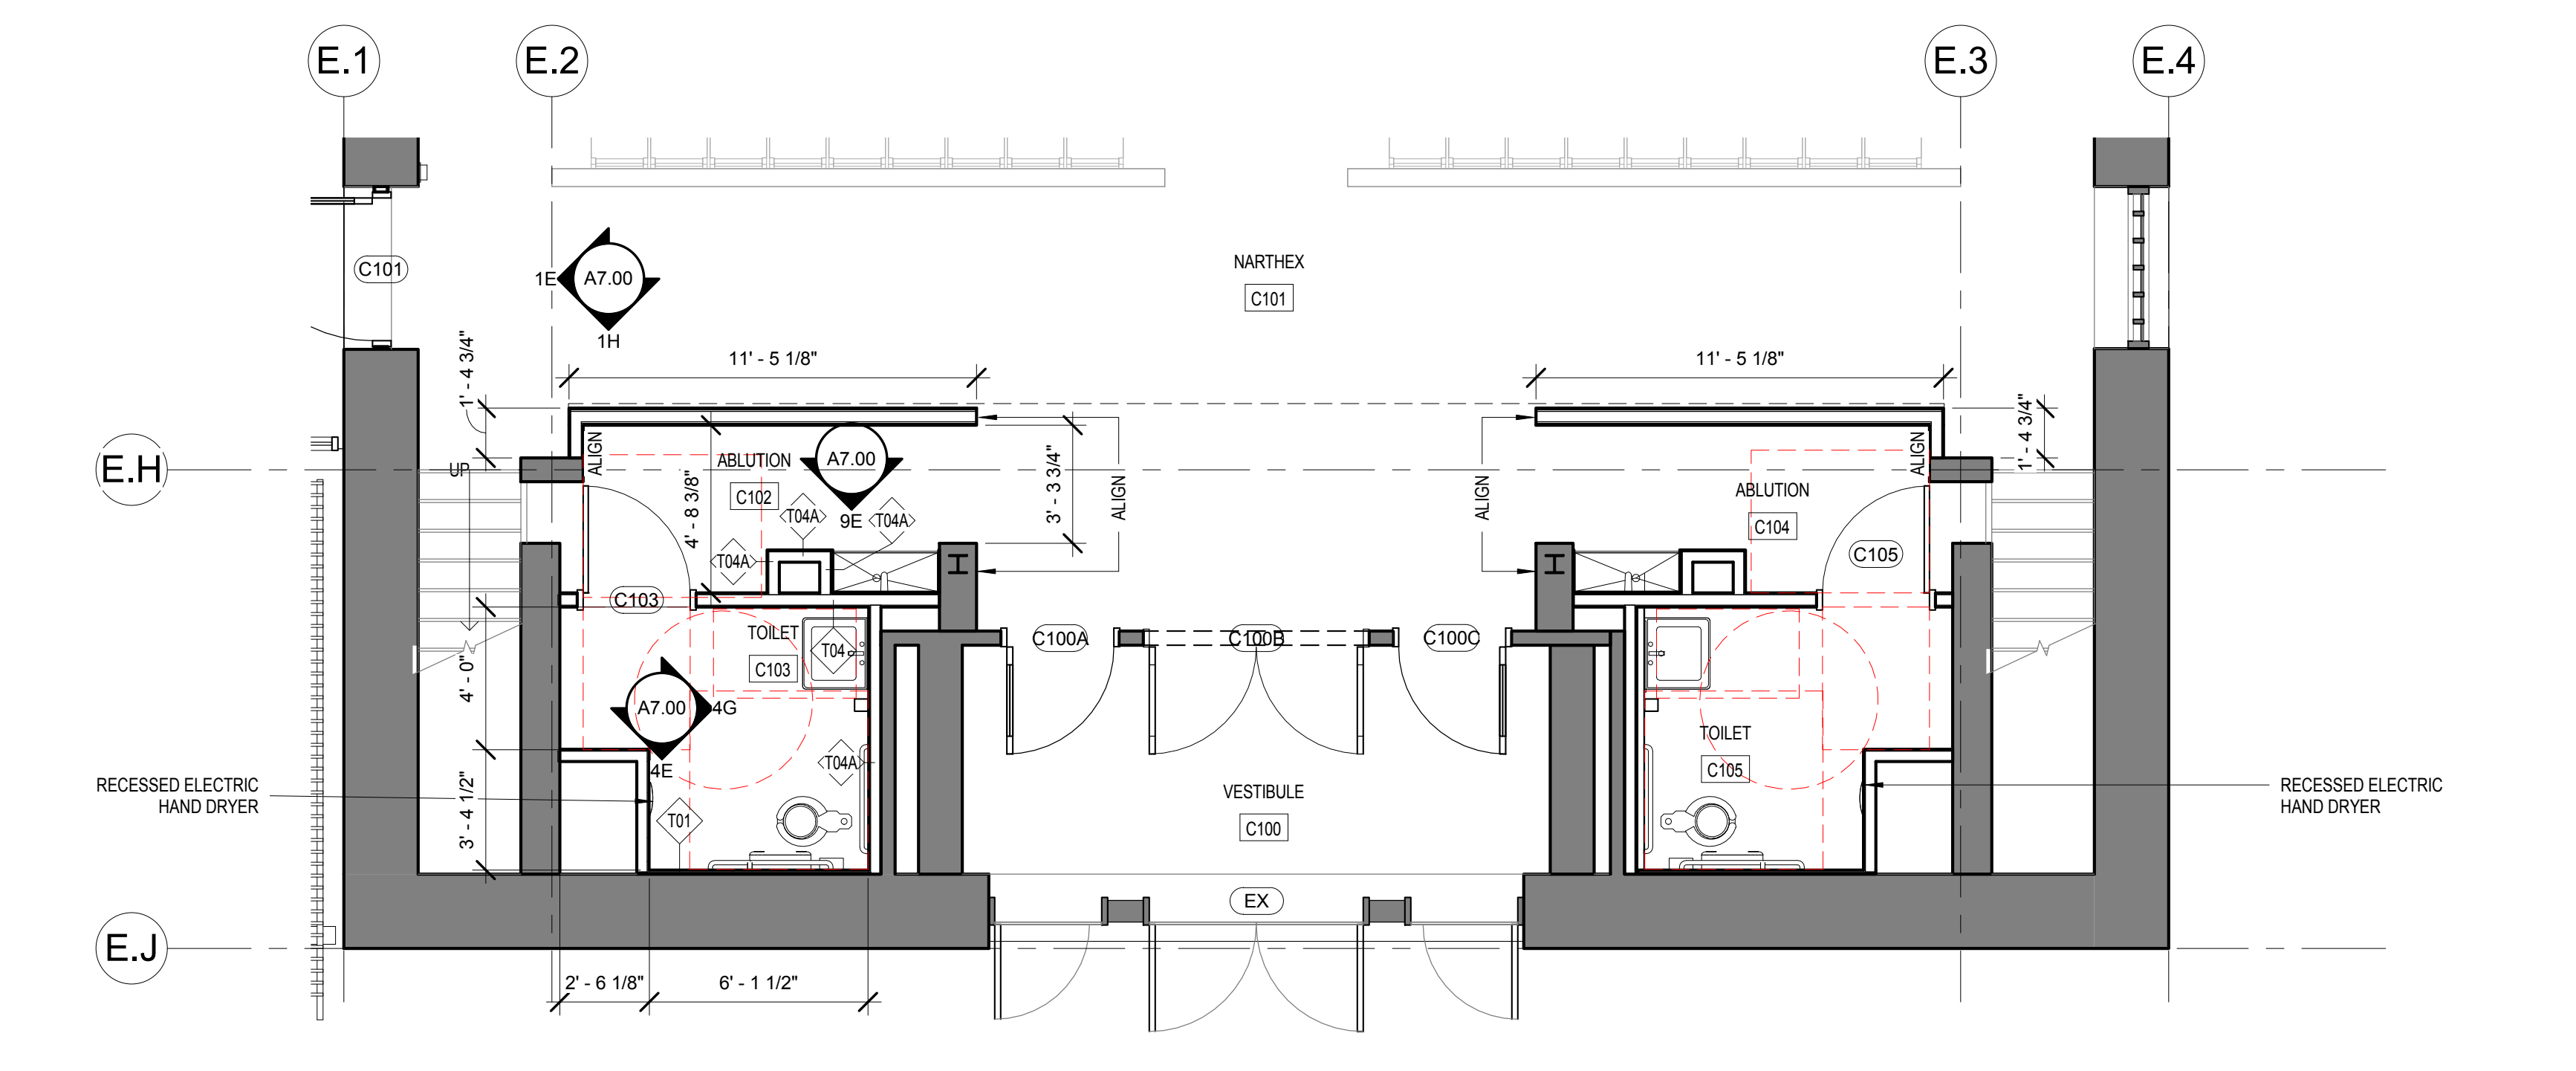

1E CHAPEL - LEVEL 1 ENTRY AND TOILET ROOMS
1/4" = 1'-0"

REVISIONS		
REV. #	DESCRIPTION	DATE

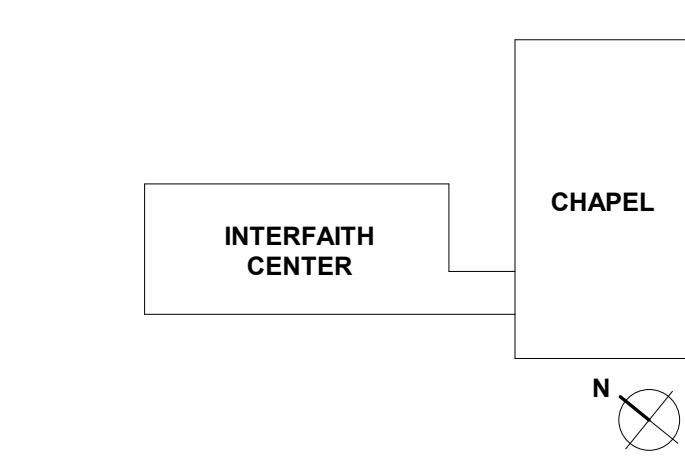KEY PLAN



ARCHITECTS + PLANNERS

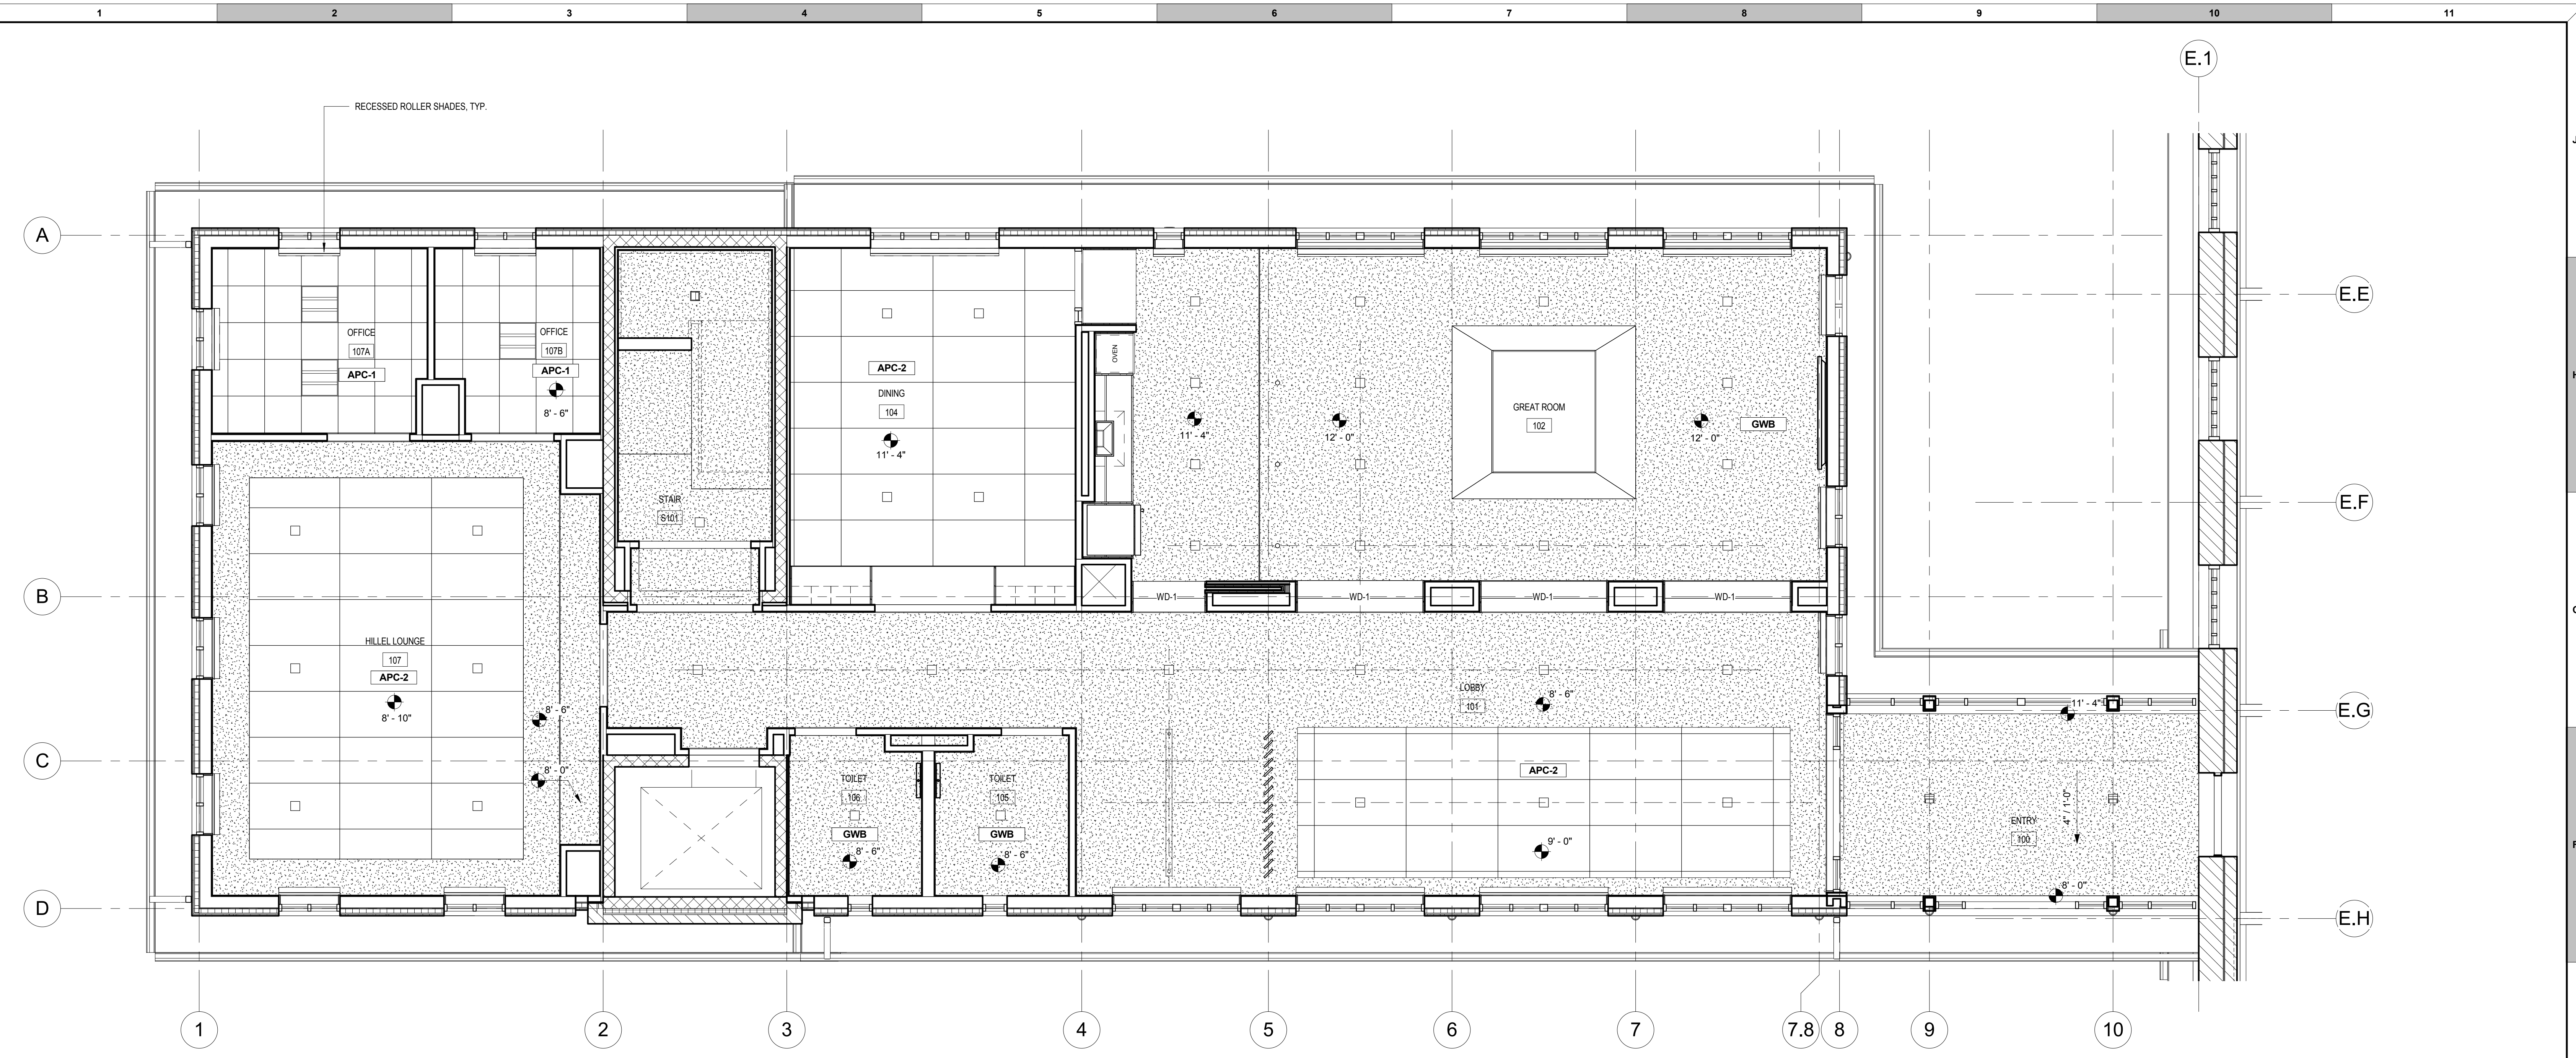
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DRAWING INFORMATION	
ISSUE DATE:	04/28/17
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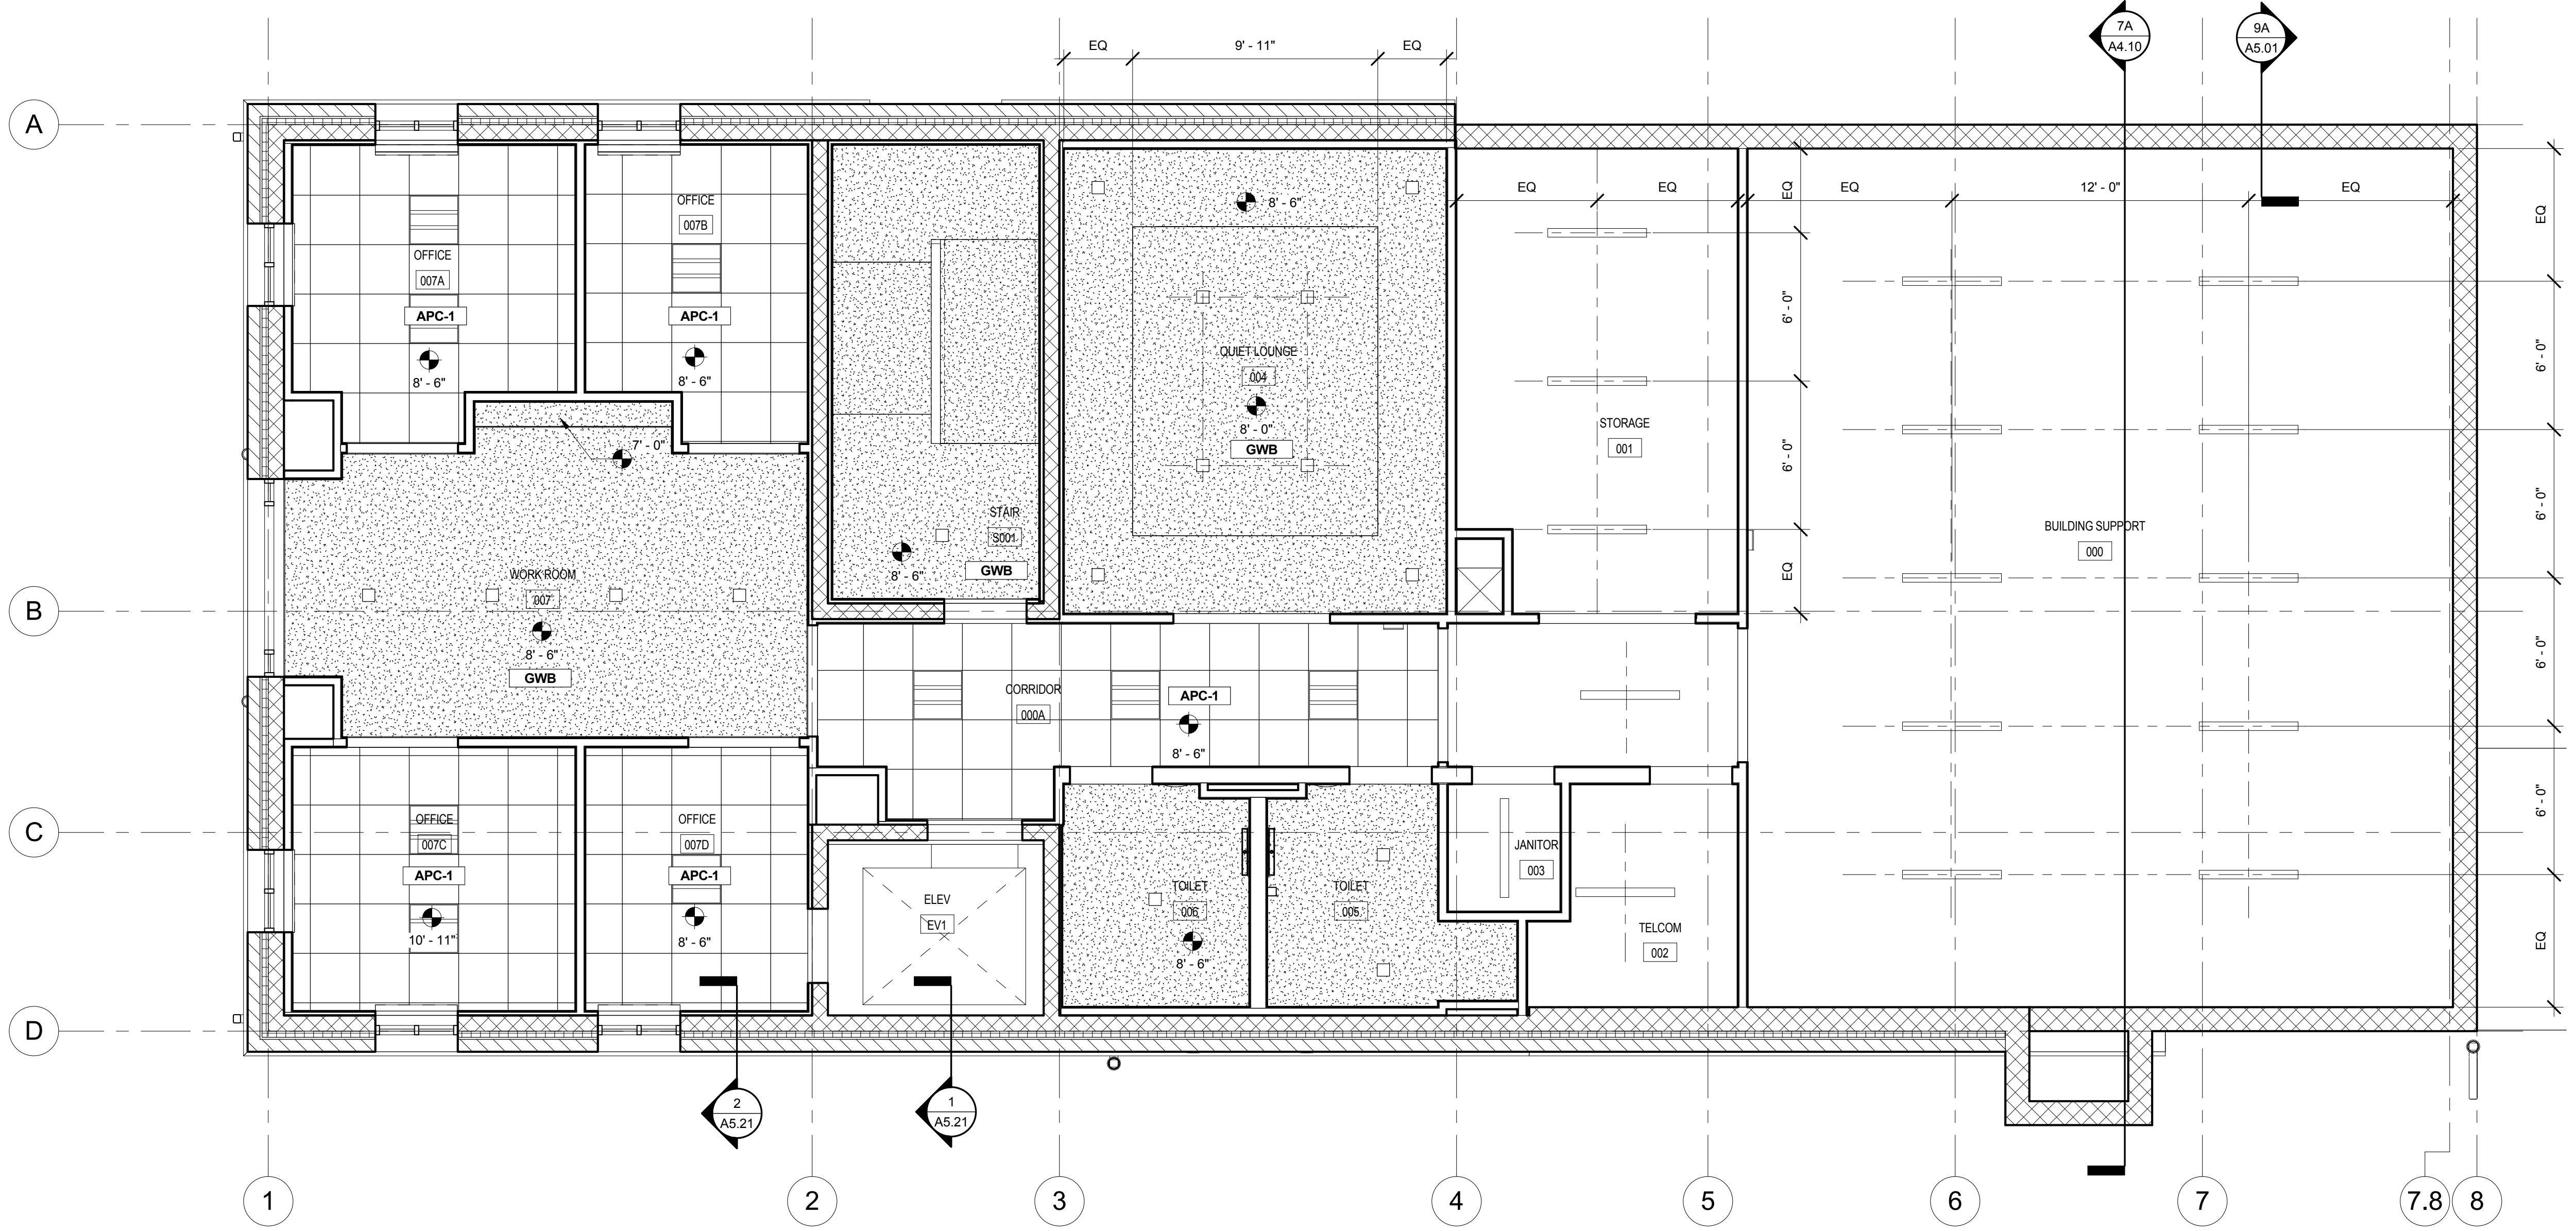
PROJECT DESIGN PHASE
50% CONSTRUCTION DOCUMENTS

DRAWING NAME
REFLECTED CEILING PLAN - LOWER LEVEL & LEVEL 1

DRAWING NUMBER
A3.10



1E LEVEL 1 - REFLECTED CEILING PLAN
1/4" = 1'-0"



1A LOWER LEVEL - REFLECTED CEILING PLAN
1/4" = 1'-0"

REFLECTED CEILING NOTES


- Borders at lay-in acoustic ceiling panels shall be cut to match factory edge profile. No exposed fasteners shall be permitted including pop rivets and tappers.
- Height of ceilings shall be measured from top of slab to finish face of GWB or face of ceiling grid as indicated on the Reflected Ceiling Plan, UON.
- All light fixtures are to be installed according to the Architectural Reflected Ceiling Plan. Architect to review ceiling layout including bulkheads and grid prior to installation.
- Light fixture types, quantities and locations only are noted on Architectural Reflected Ceiling Plans. Specifications, switching, exit lights, emergency lighting, life safety equipment, and circuiting are noted on Engineering documents.
- Dimensioned light fixtures are from finished face of partitions to centerline of fixture and from centerline of fixture to centerline of fixture. All fixtures shall be installed in center of ceiling tile unless noted otherwise. Any discrepancies with light fixtures, switches, thermostats, or diffusers as to location between architectural and engineering drawings or between the drawings and existing field conditions shall be clarified with the Architect before proceeding with installation.
- Existing wood slat ceiling and square recessed light fixtures at underside of choir loft in Chapel to remain. Patch and repair the ceiling where demolition occurred to match existing.
- Provide and install manual recessed roller shades at all windows, UON.
- Provide and install motorized recessed roller shades at windows in double height Great Room.
- Provide and install K-13 Spray On Acoustic Treatment to underside of structural deck throughout the Lower Level.

LIGHT FIXTURE LEGEND

- 6" SQ. RECESSED LED DOWNLIGHT
- DECORATIVE LED SCONCE - ALLOW \$300 PER FIXTURE
- 2X2 RECESSED DIRECT/INDIRECT LED
- DECORATIVE VANITY SCONCE
- 8"-0" UTILITY LINEAR LED PENDANT FIXTURE
- EXISTING CHAPEL PENDANT FIXTURE - RELAMP WITH LED

REVISIONS		
REV. #	DESCRIPTION	DATE

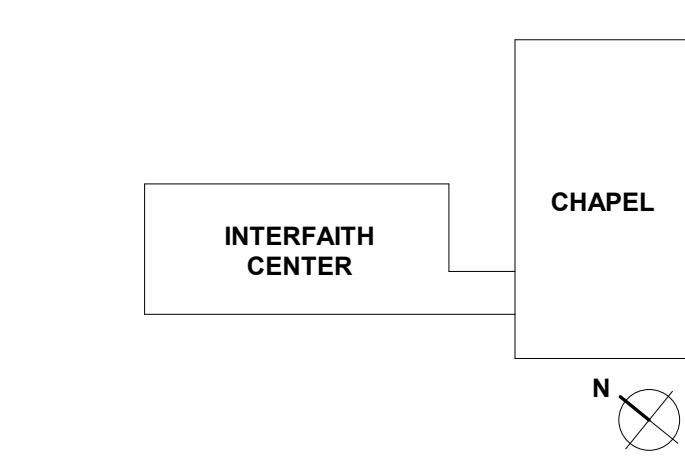KEY PLAN



ARCHITECTS + PLANNERS


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DRAWING INFORMATION	
ISSUE DATE:	04/28/17
SCALE:	1/4" = 1'-0"
JOB NO.:	21641.00
DRAWN BY:	ASG


PROJECT DESIGN PHASE
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DRAWING NAME
REFLECTED CEILING PLAN - LEVEL 2 & CHAPEL


DRAWING NUMBER
A3.11



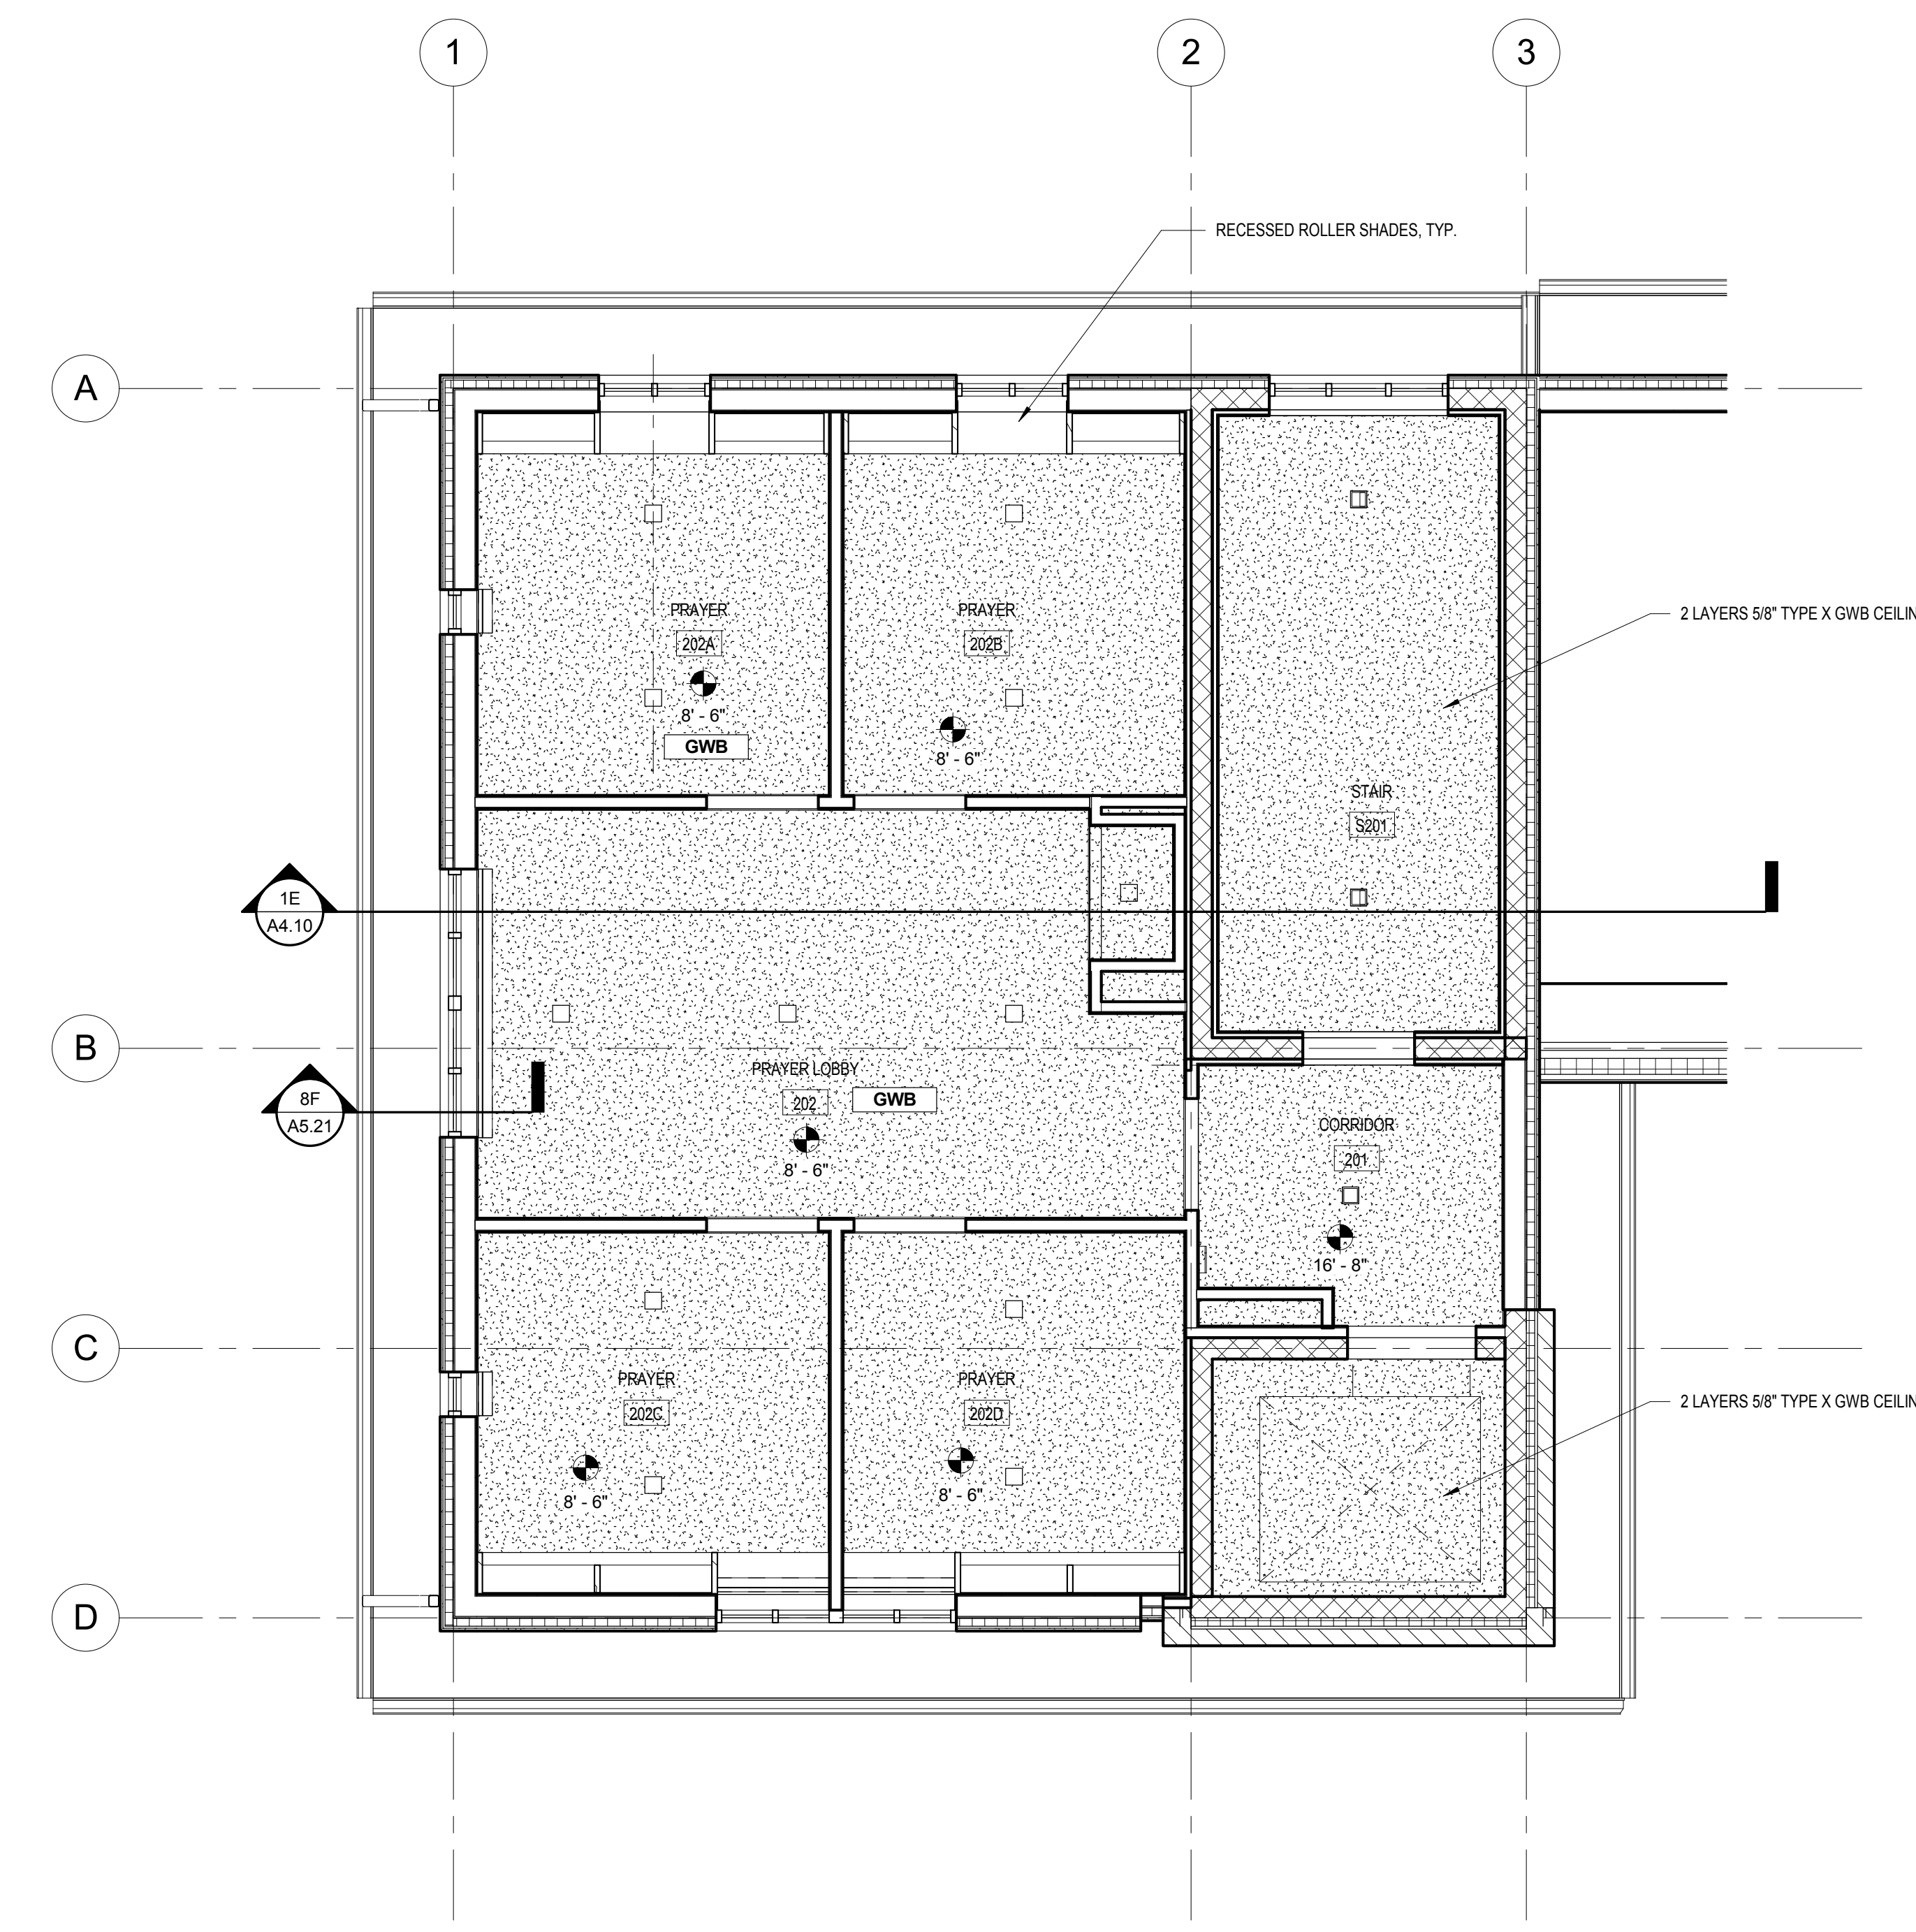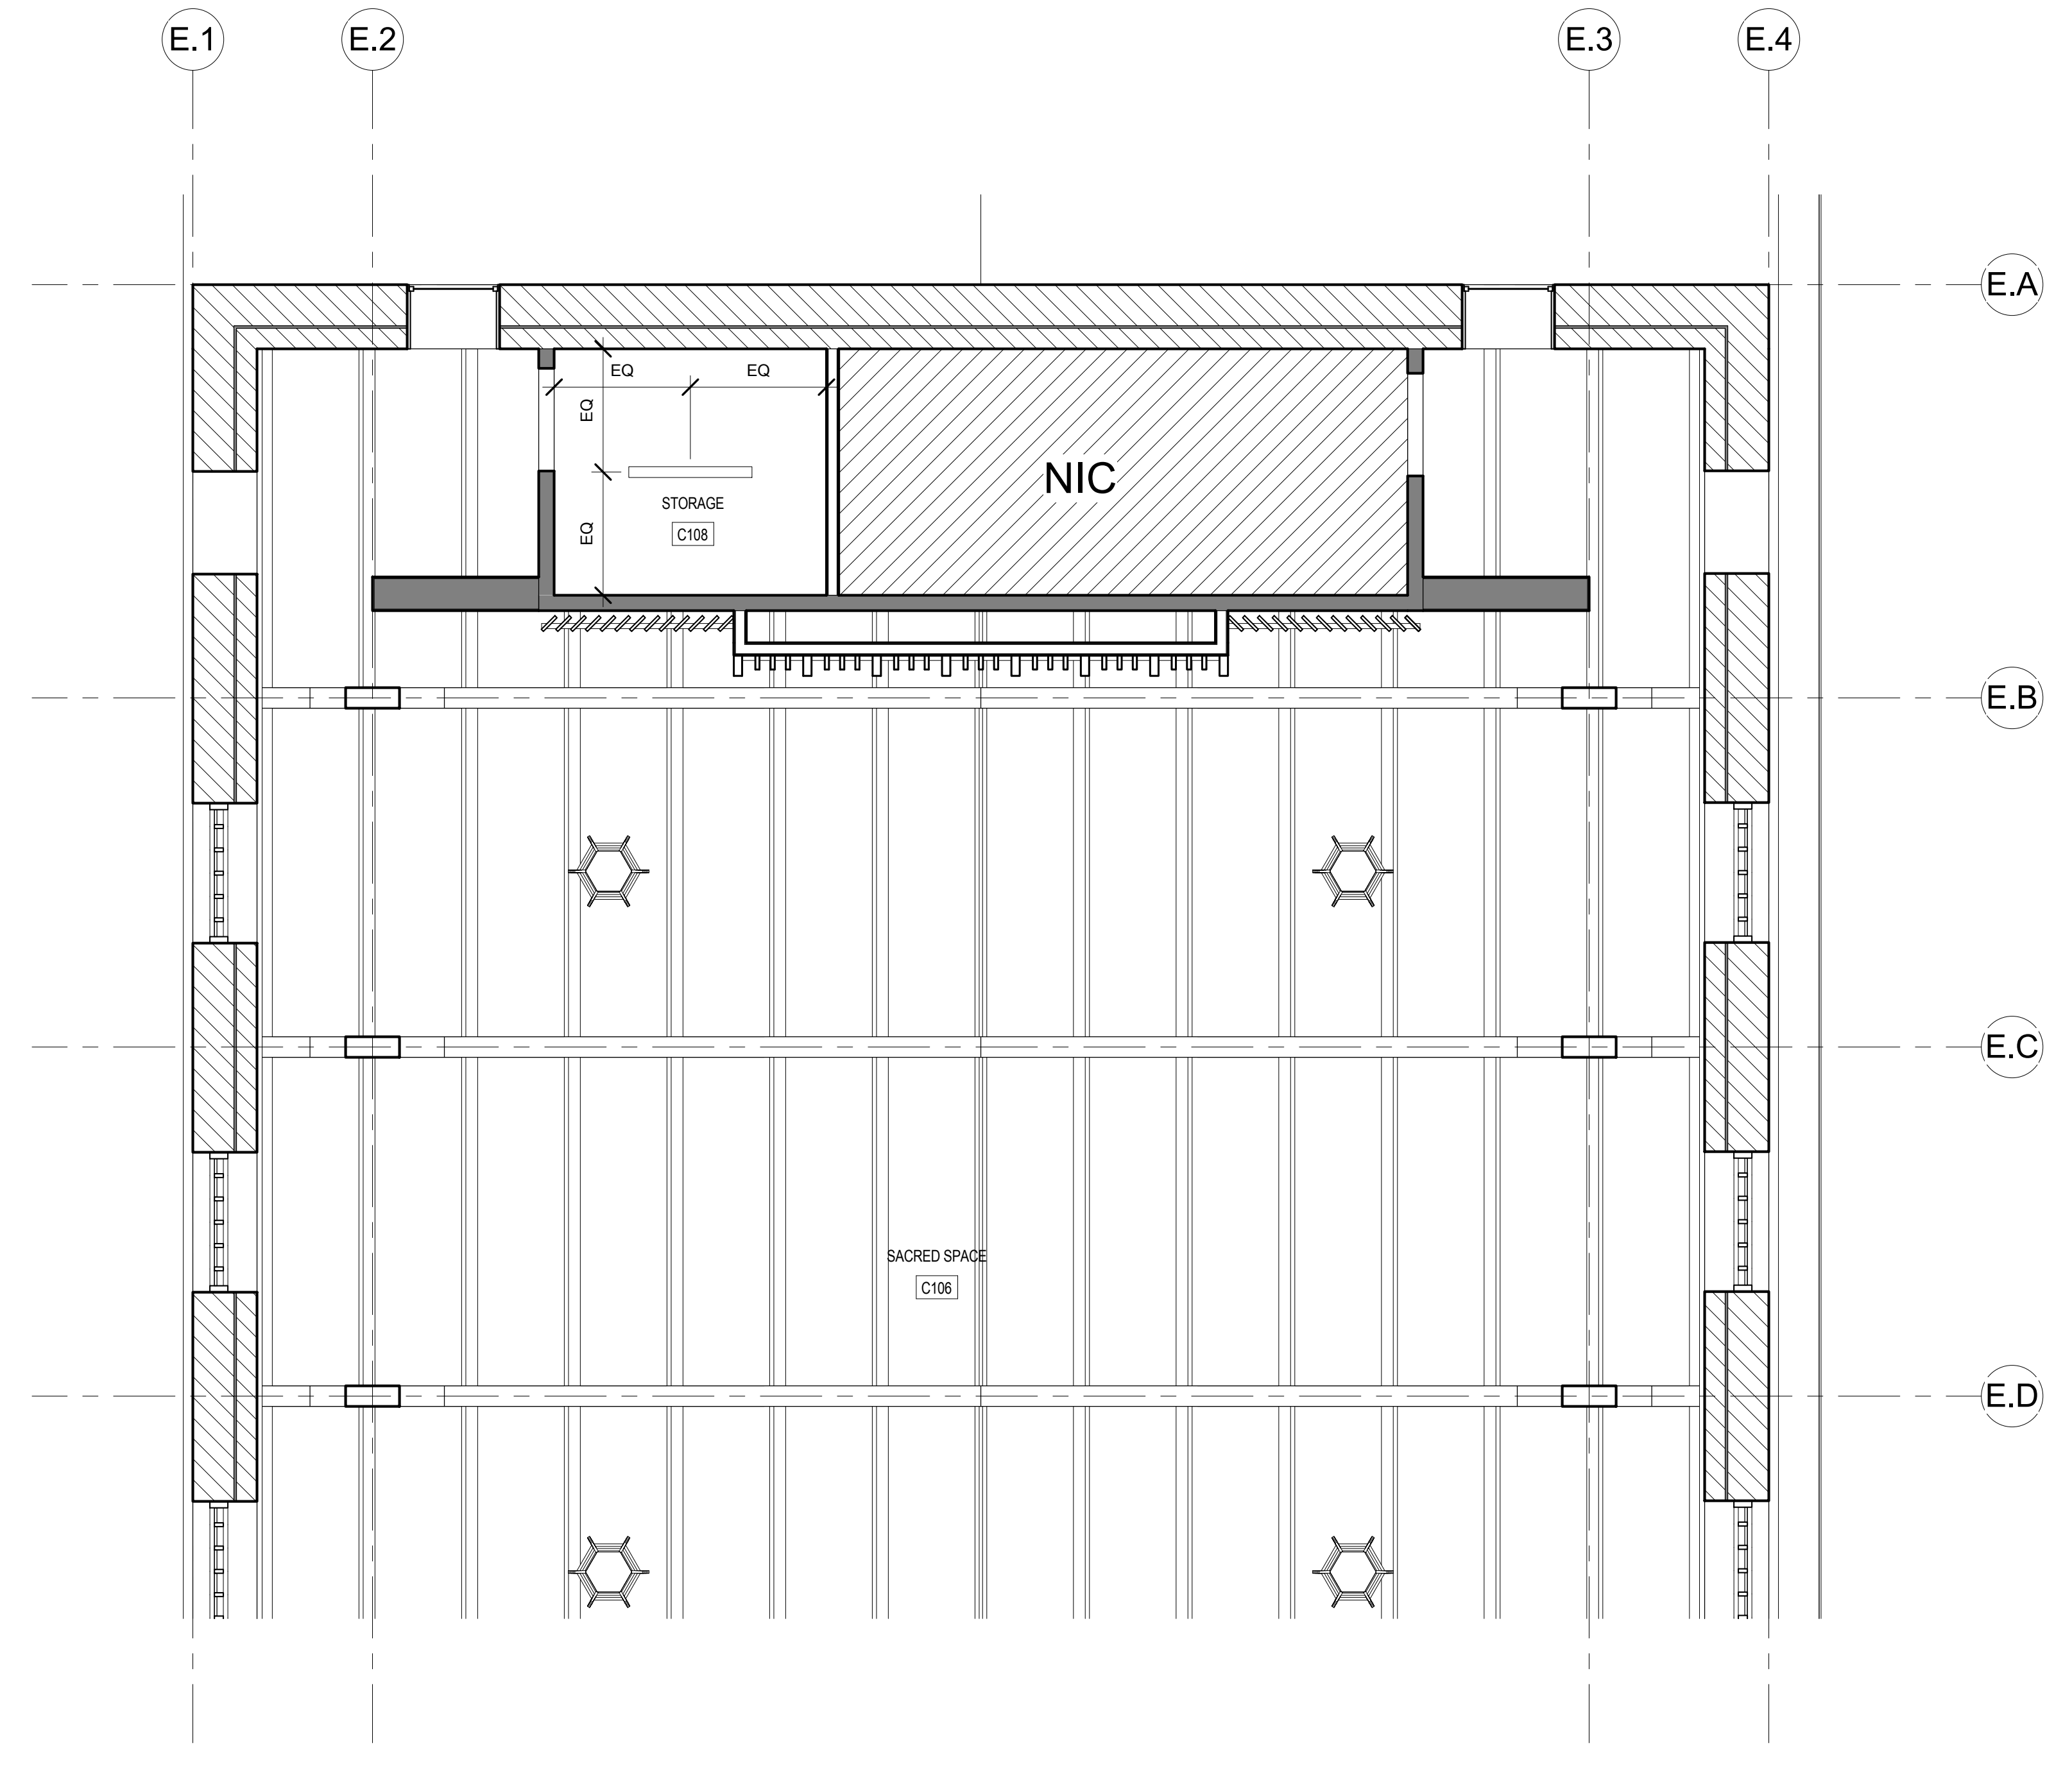1E INTERFAITH CENTER - LEVEL 2 - REFLECTED CEILING PLAN
1/4" = 1'-0"



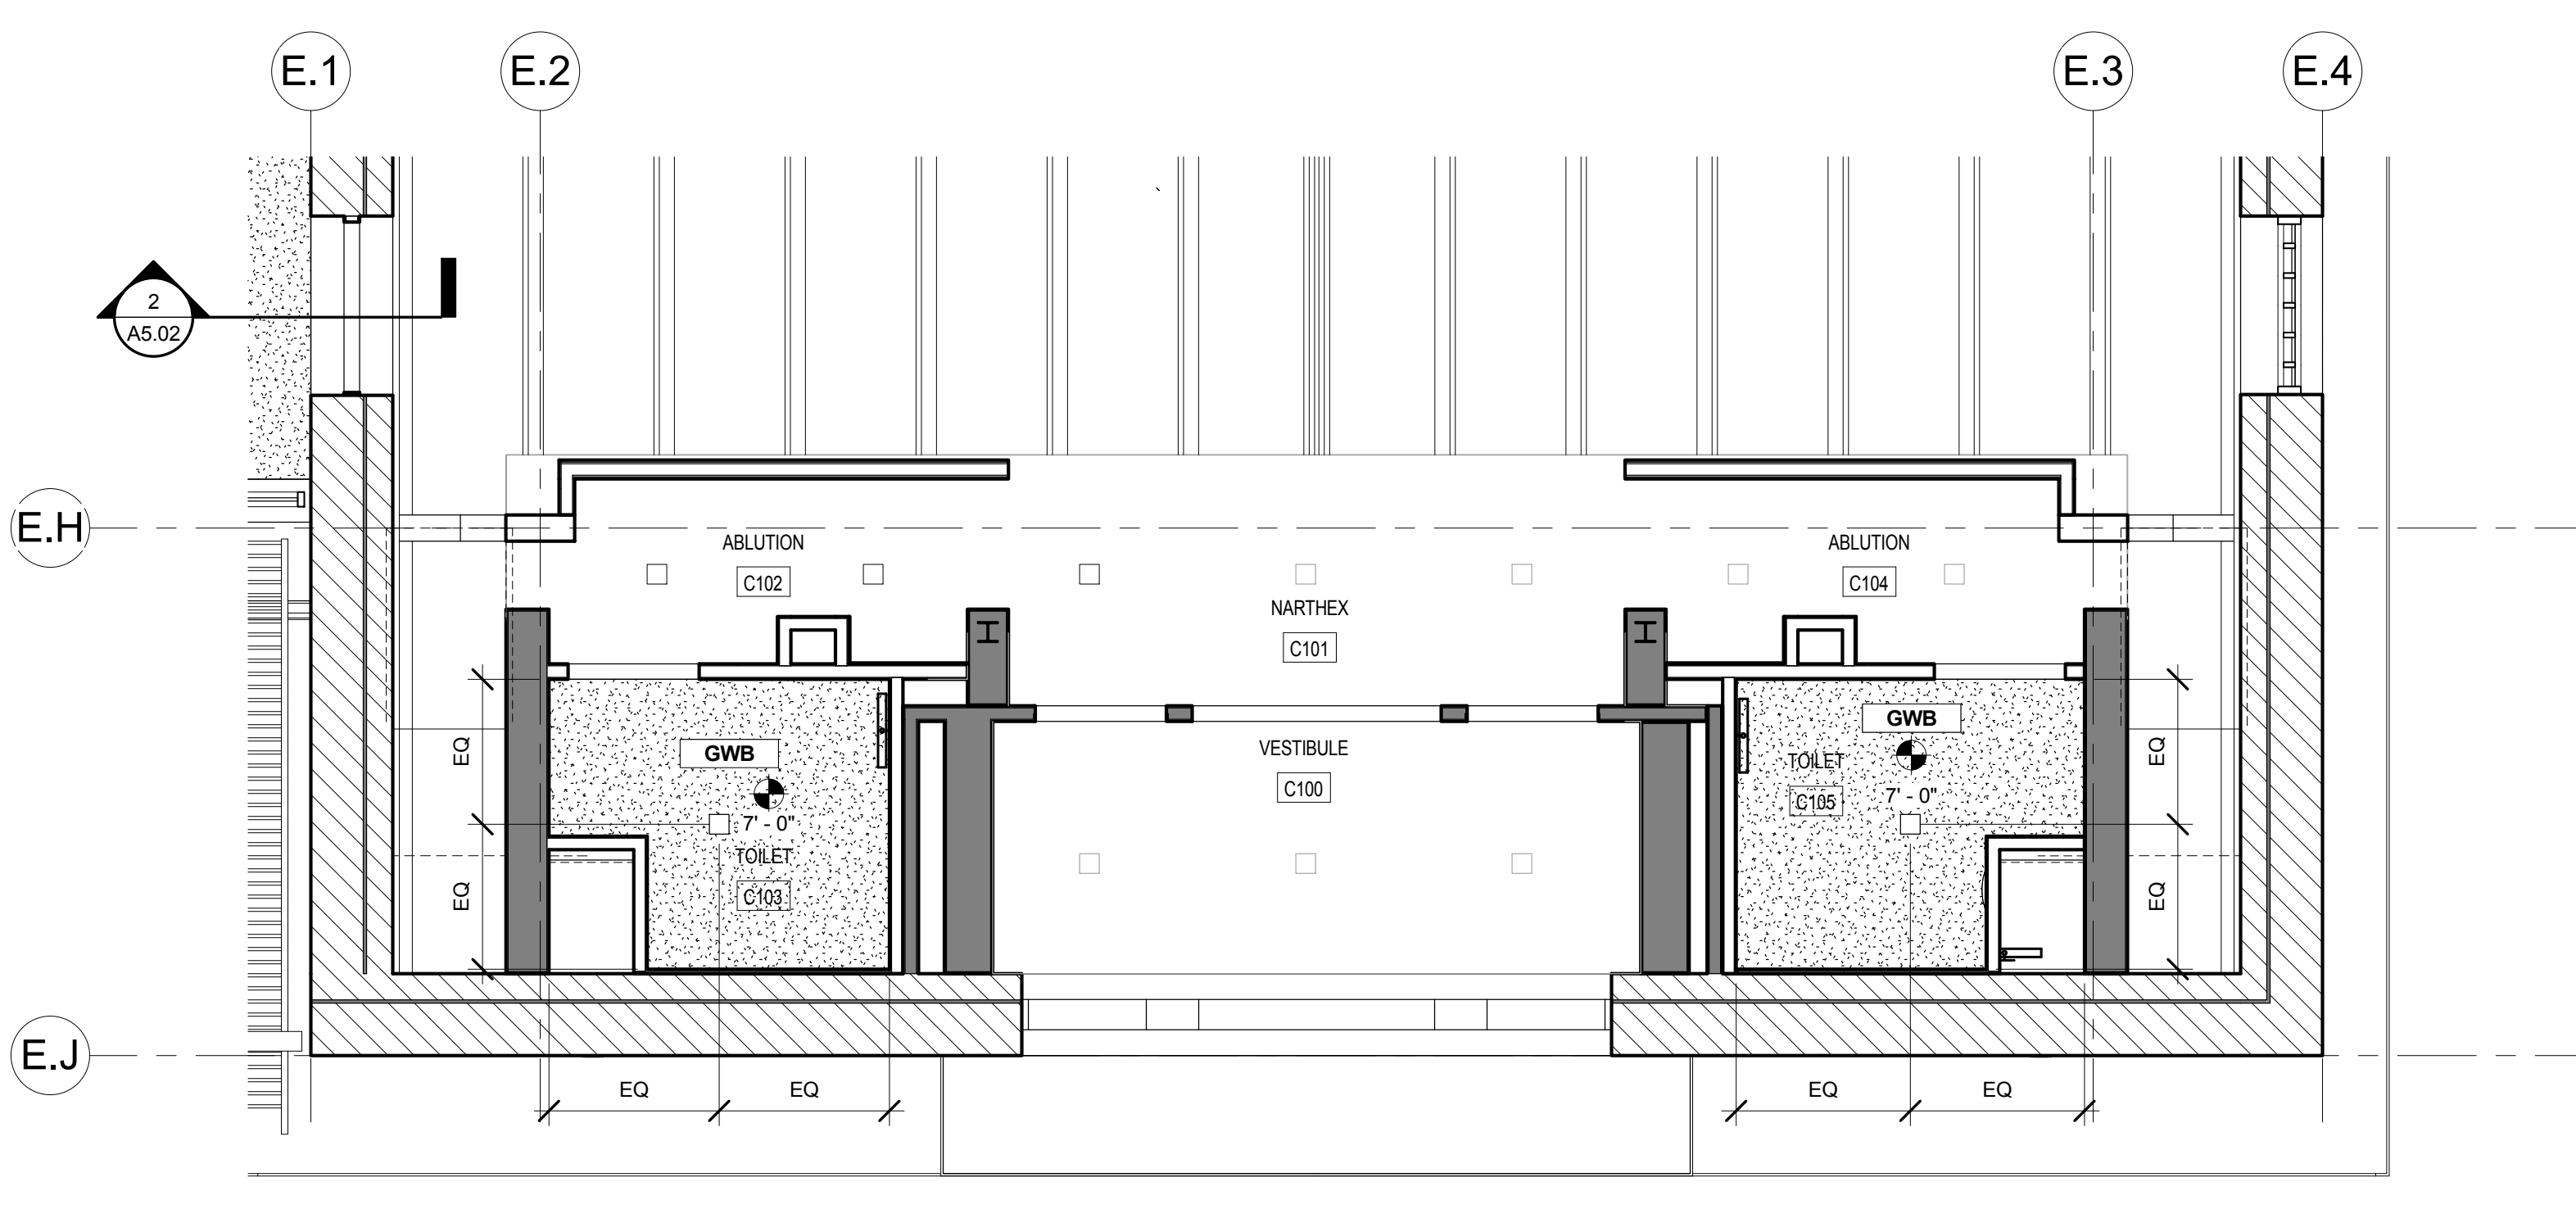
6E CHAPEL ALTER - REFLECTED CEILING PLAN
1/4" = 1'-0"



6A CHAPEL ENTRY AND TOILET ROOMS - REFLECTED CEILING PLAN
1/4" = 1'-0"

REVISIONS		
REV. #	DESCRIPTION	DATE

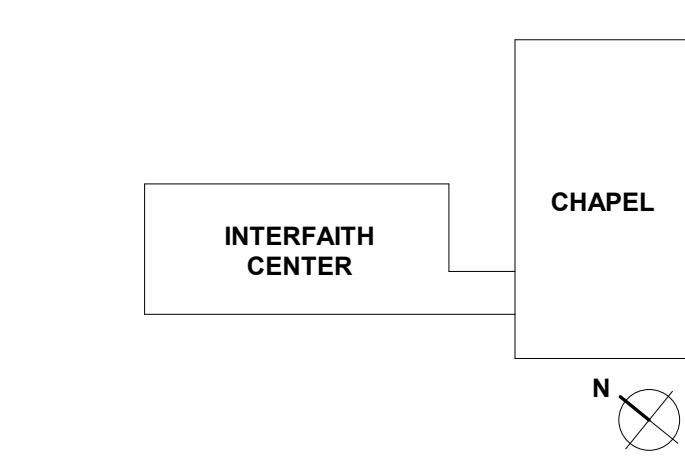KEY PLAN



ARCHITECTS + PLANNERS

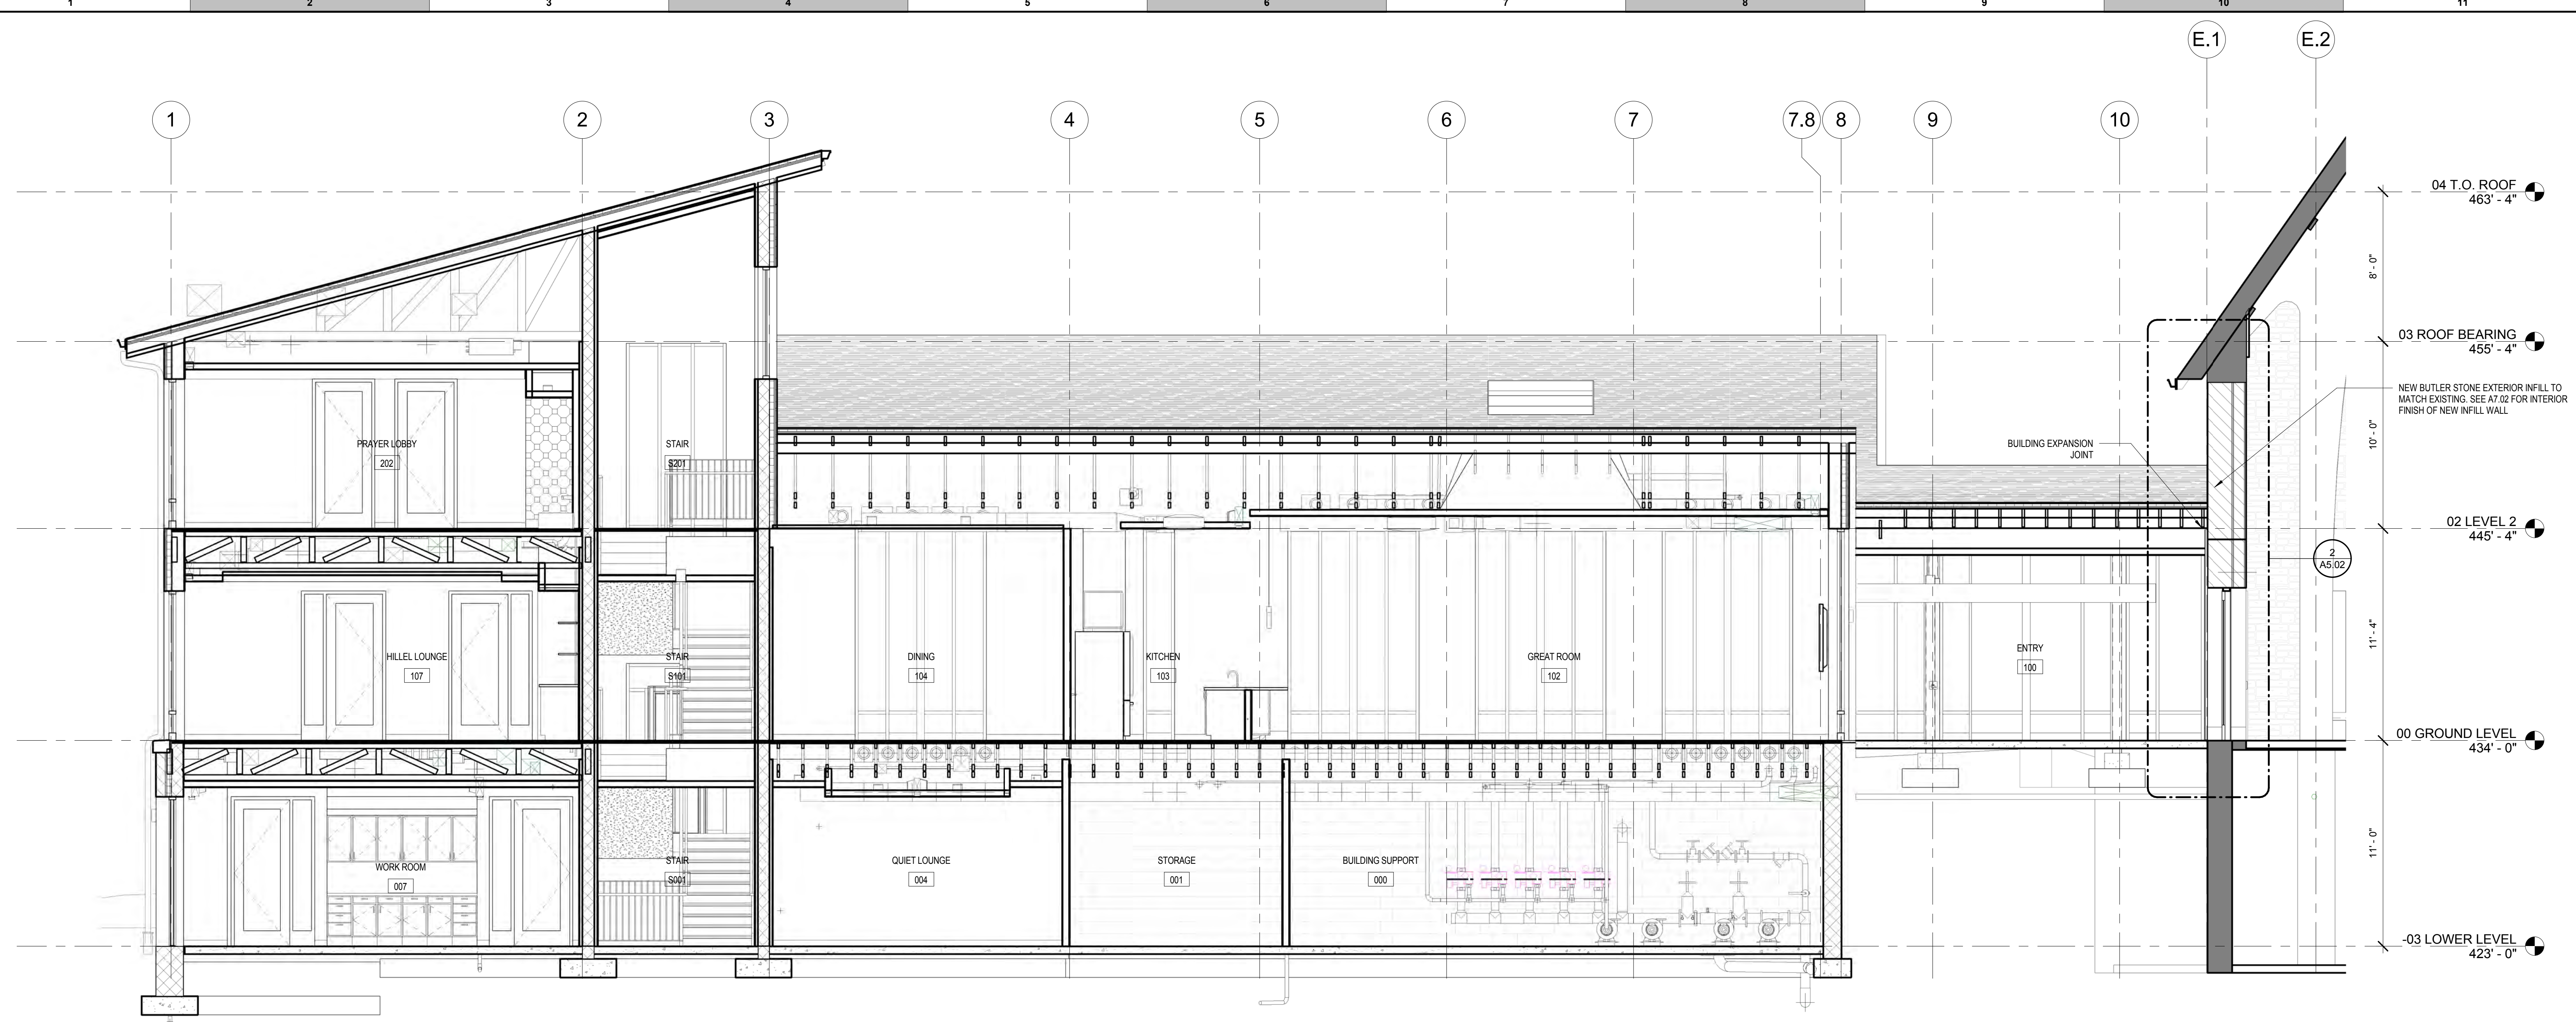
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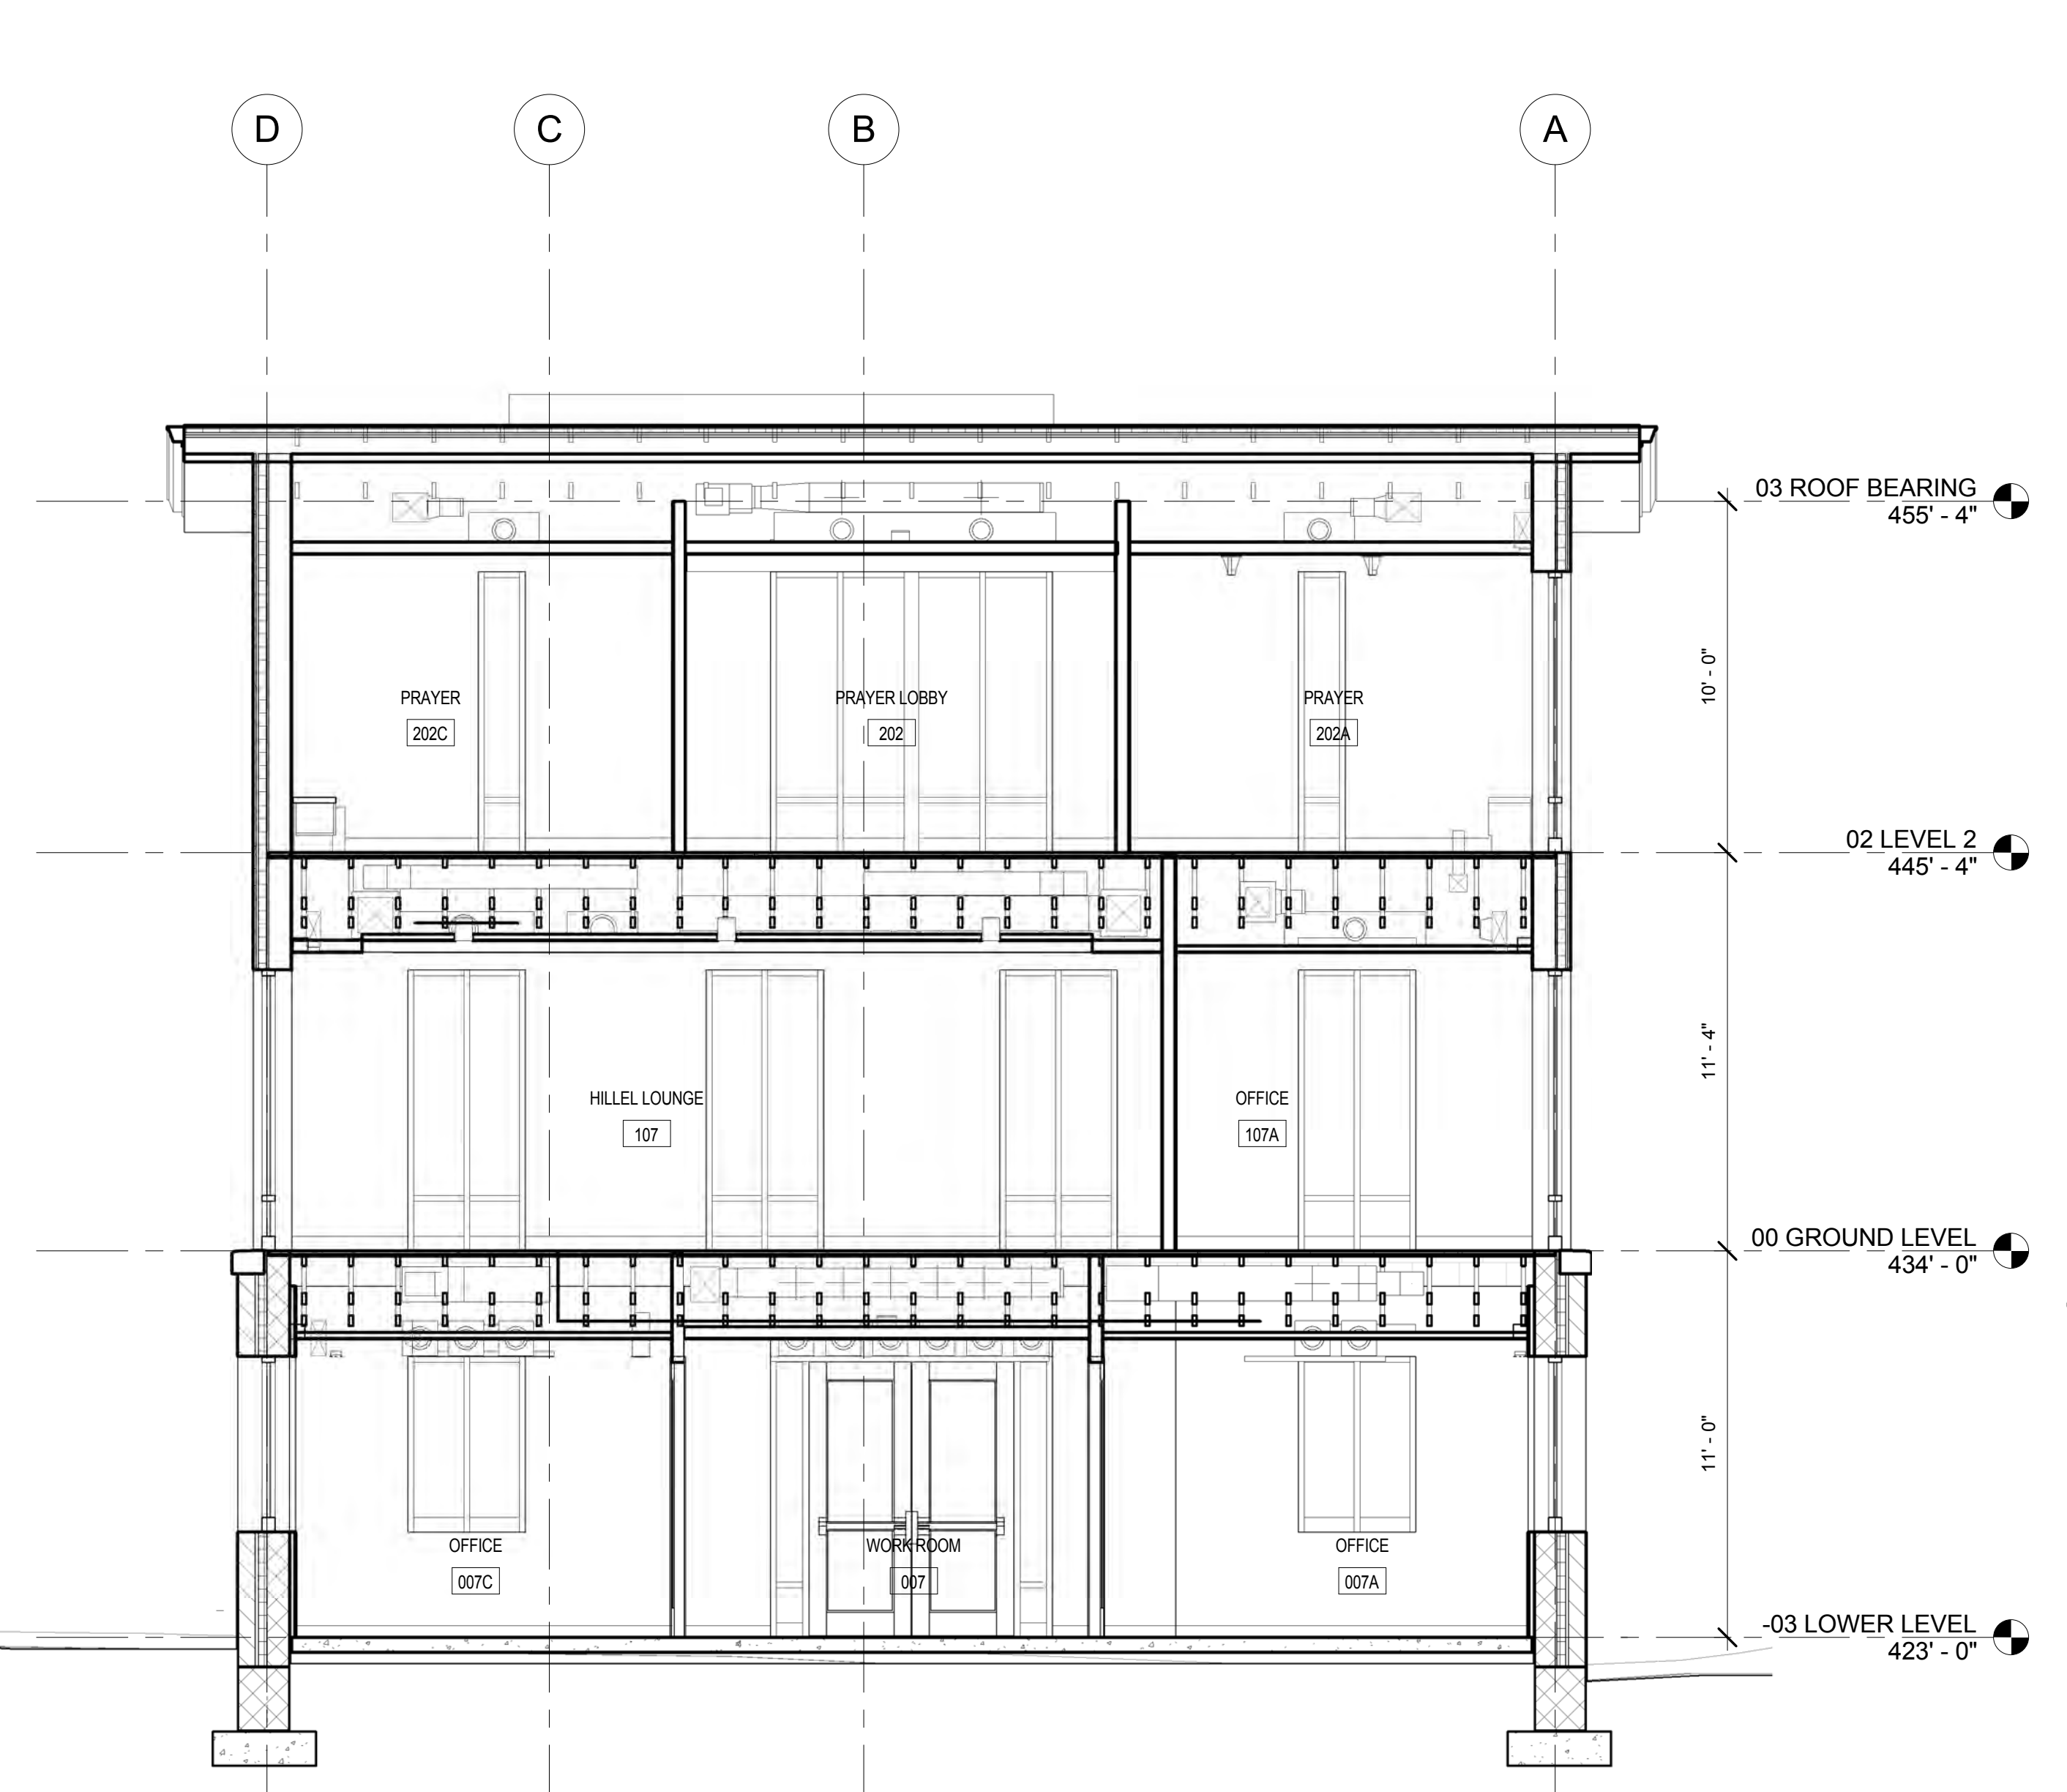
PROJECT DESIGN PHASE
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DRAWING NAME
BUILDING SECTIONS


DRAWING NUMBER
A4.10



1E LONGITUDINAL BUILDING SECTION
1/4" = 1'-0"



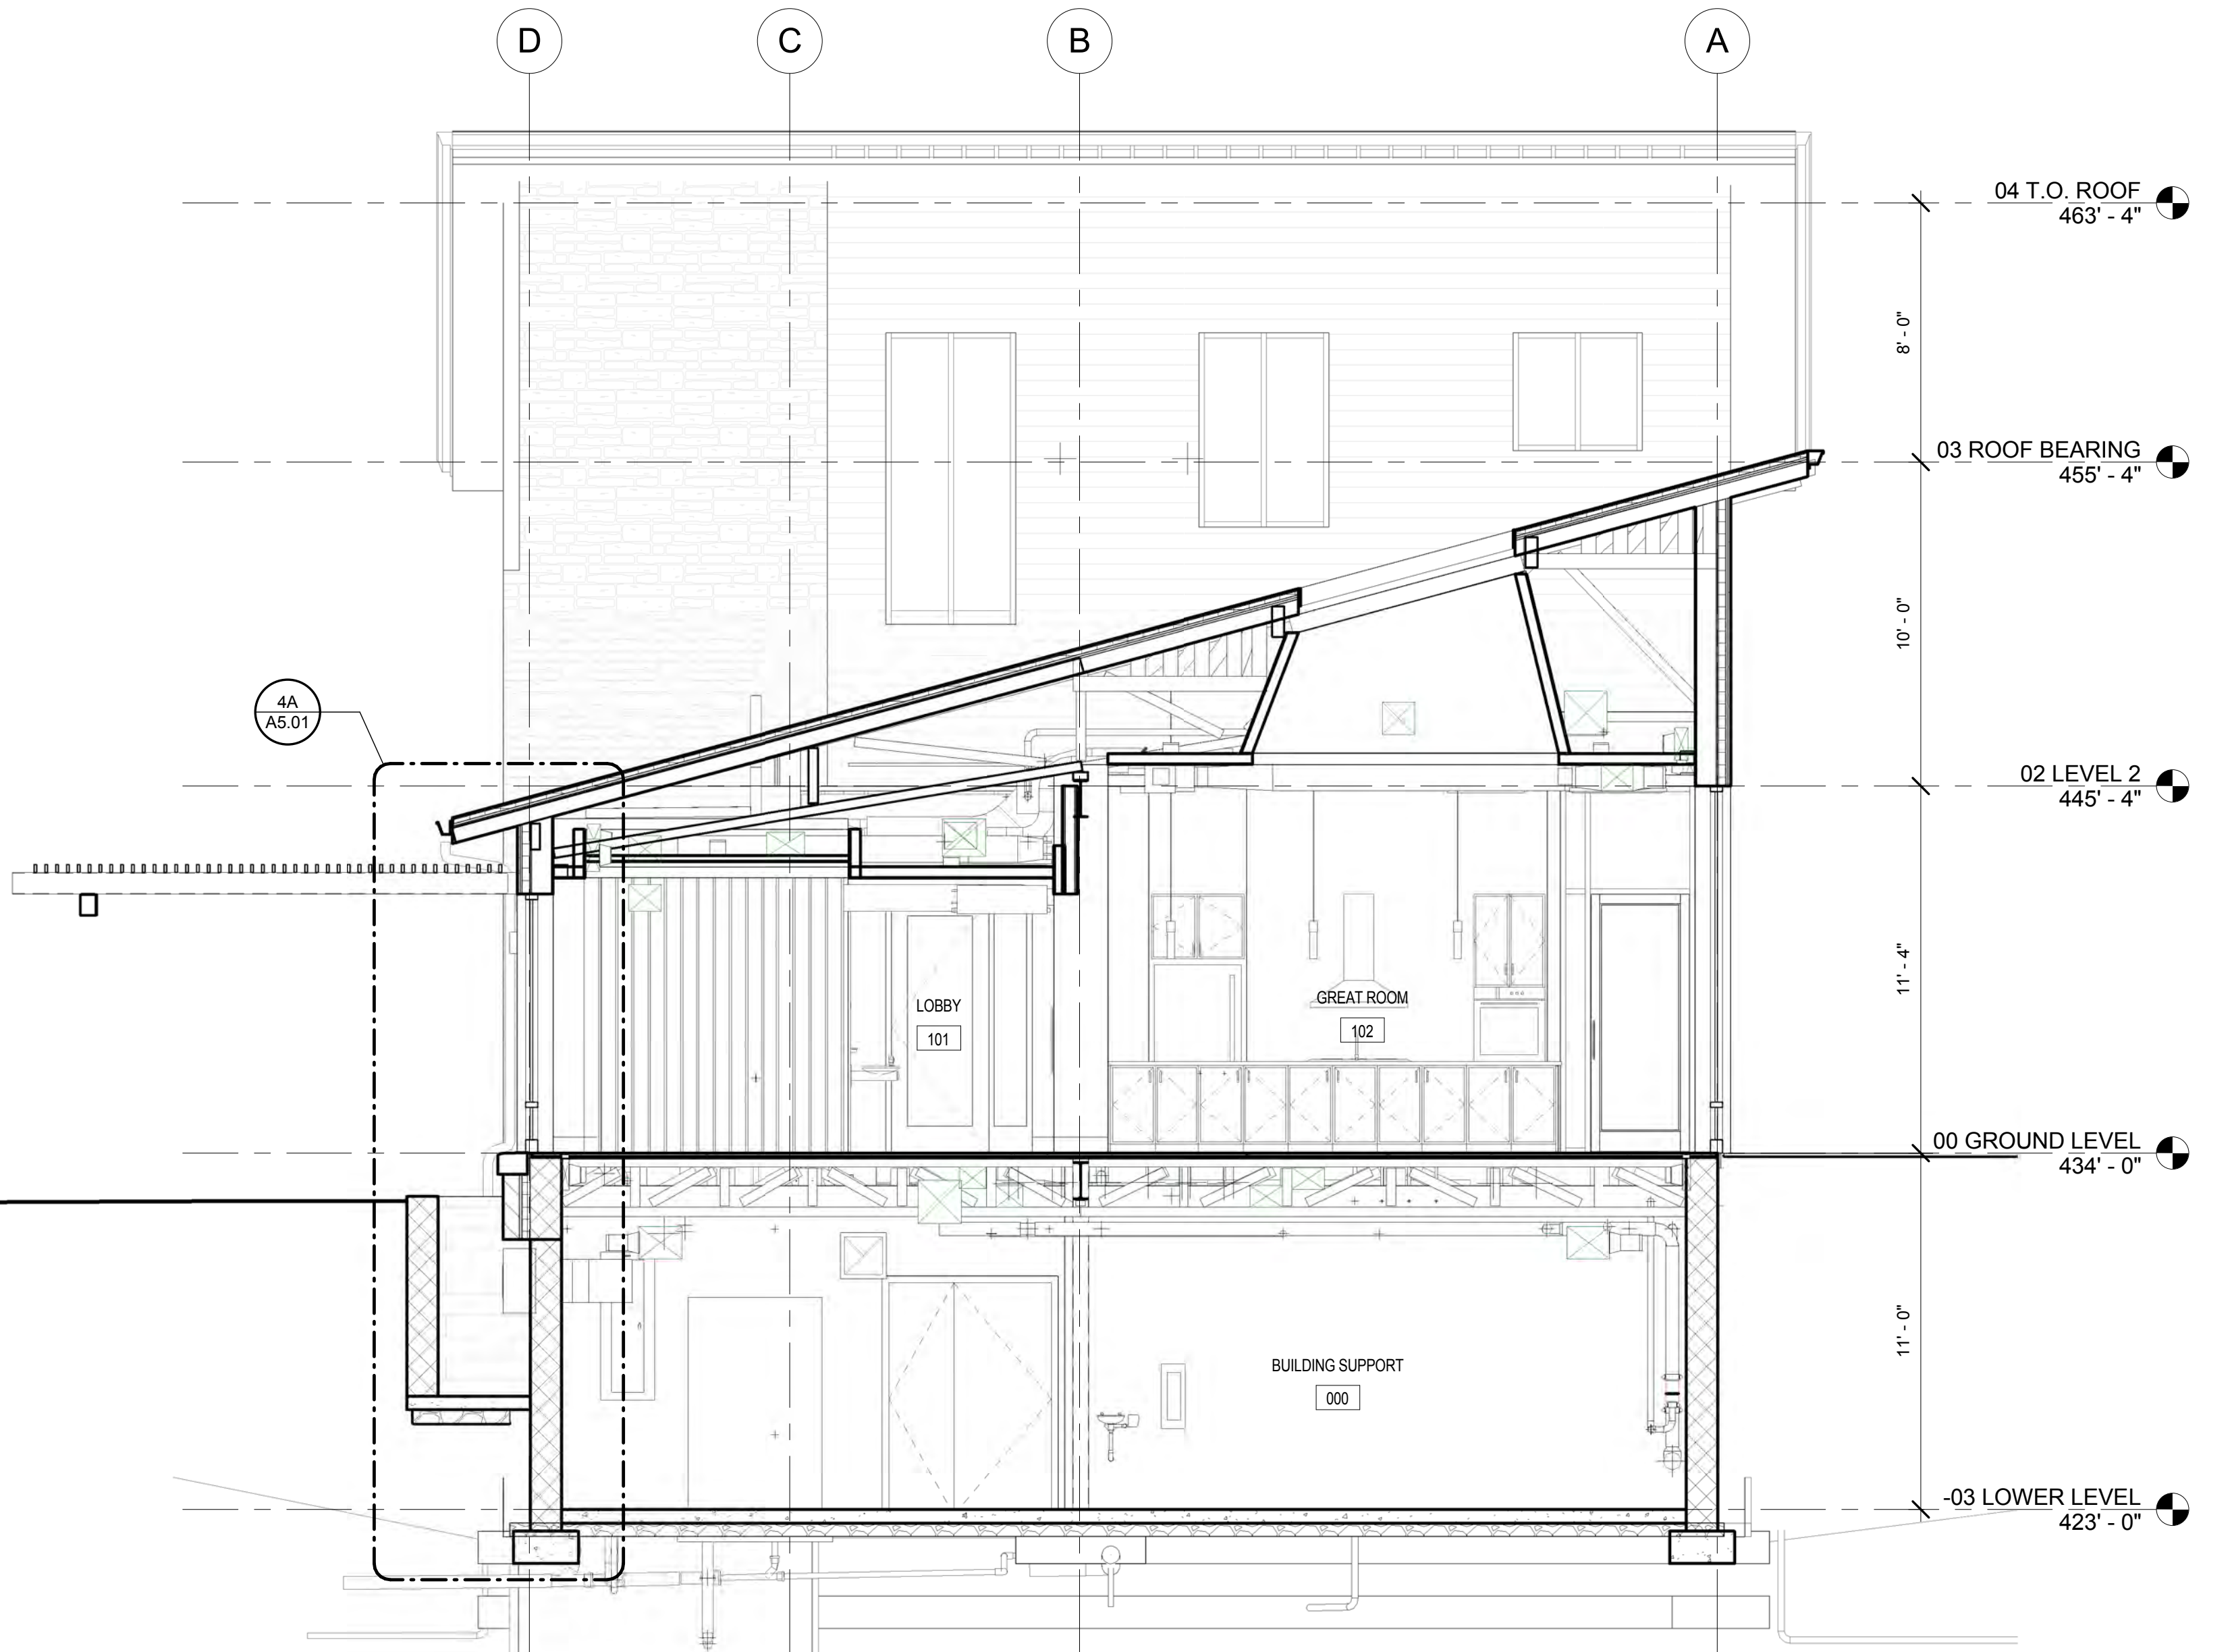
1A BUILDING CROSS SECTION AT OFFICES AND PRAYER ROOMS
1/4" = 1'-0"



1A BUILDING CROSS SECTION AT GREAT ROOM AND LOBBY
1/4" = 1'-0"

REVISIONS		
REV. #	DESCRIPTION	DATE

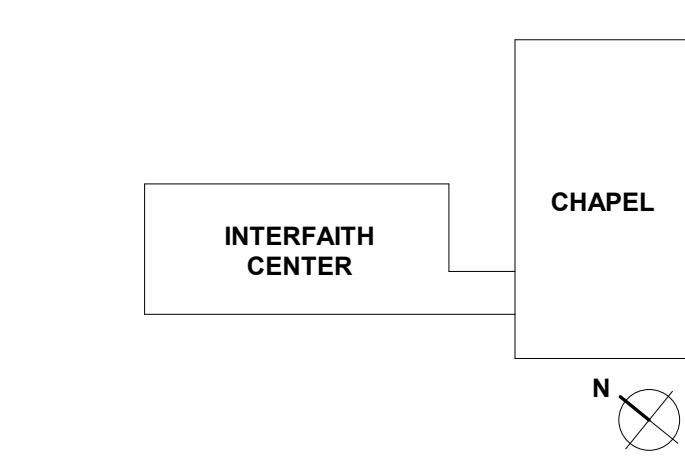KEY PLAN



AYERS SAINT GROSS
ARCHITECTS + PLANNERS


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DRAWING INFORMATION	
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SCALE:	3/4" = 1'-0"
JOB NO.:	21641.00
DRAWN BY:	ASG

PROJECT DESIGN PHASE
50% CONSTRUCTION DOCUMENTS
DRAWING NAME

WALL SECTIONS

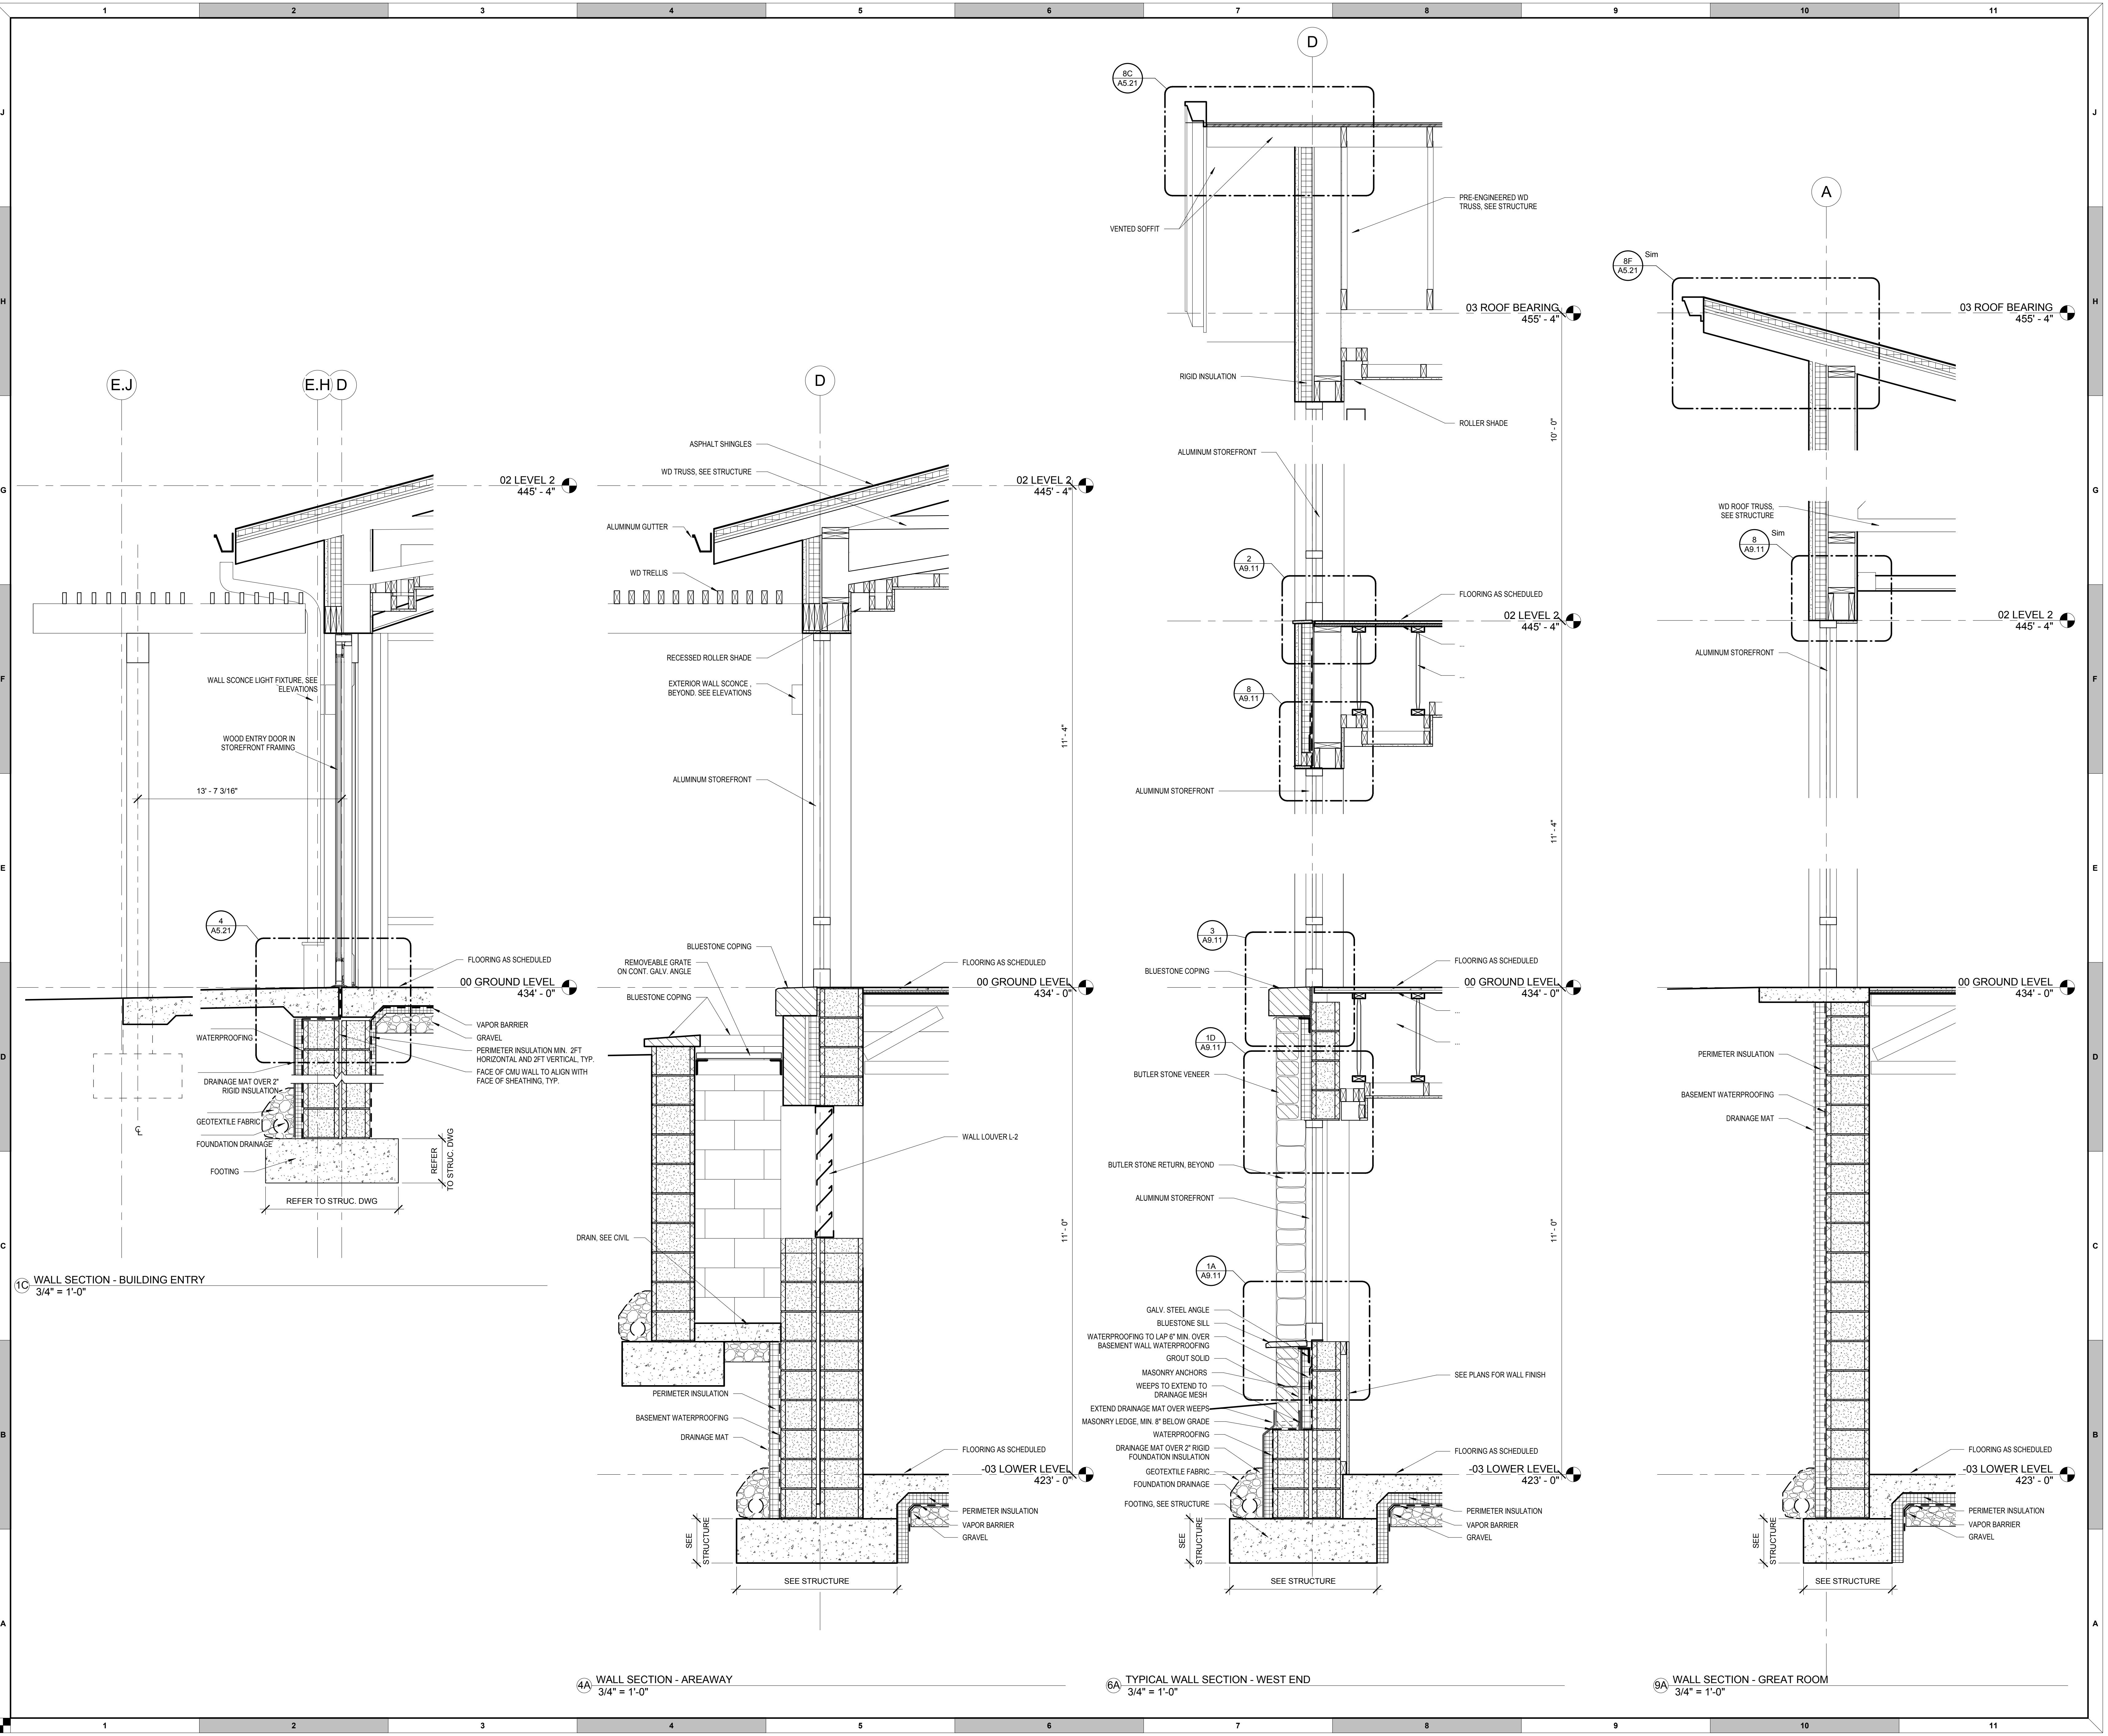DRAWING NUMBER
A5.01




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REV. #	DESCRIPTION	DATE

KEY PLAN



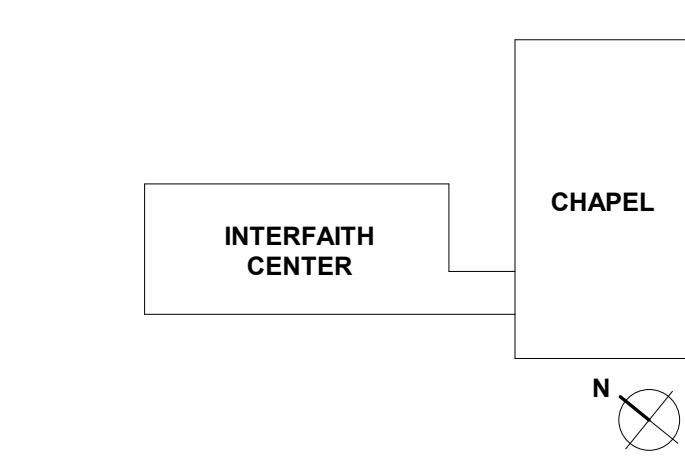ARCHITECTS + PLANNERS


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JOB NO.:	21641.00
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PROJECT DESIGN PHASE
50% CONSTRUCTION DOCUMENTS

DRAWING NAME
WALL SECTIONS

DRAWING NUMBER
A5.02



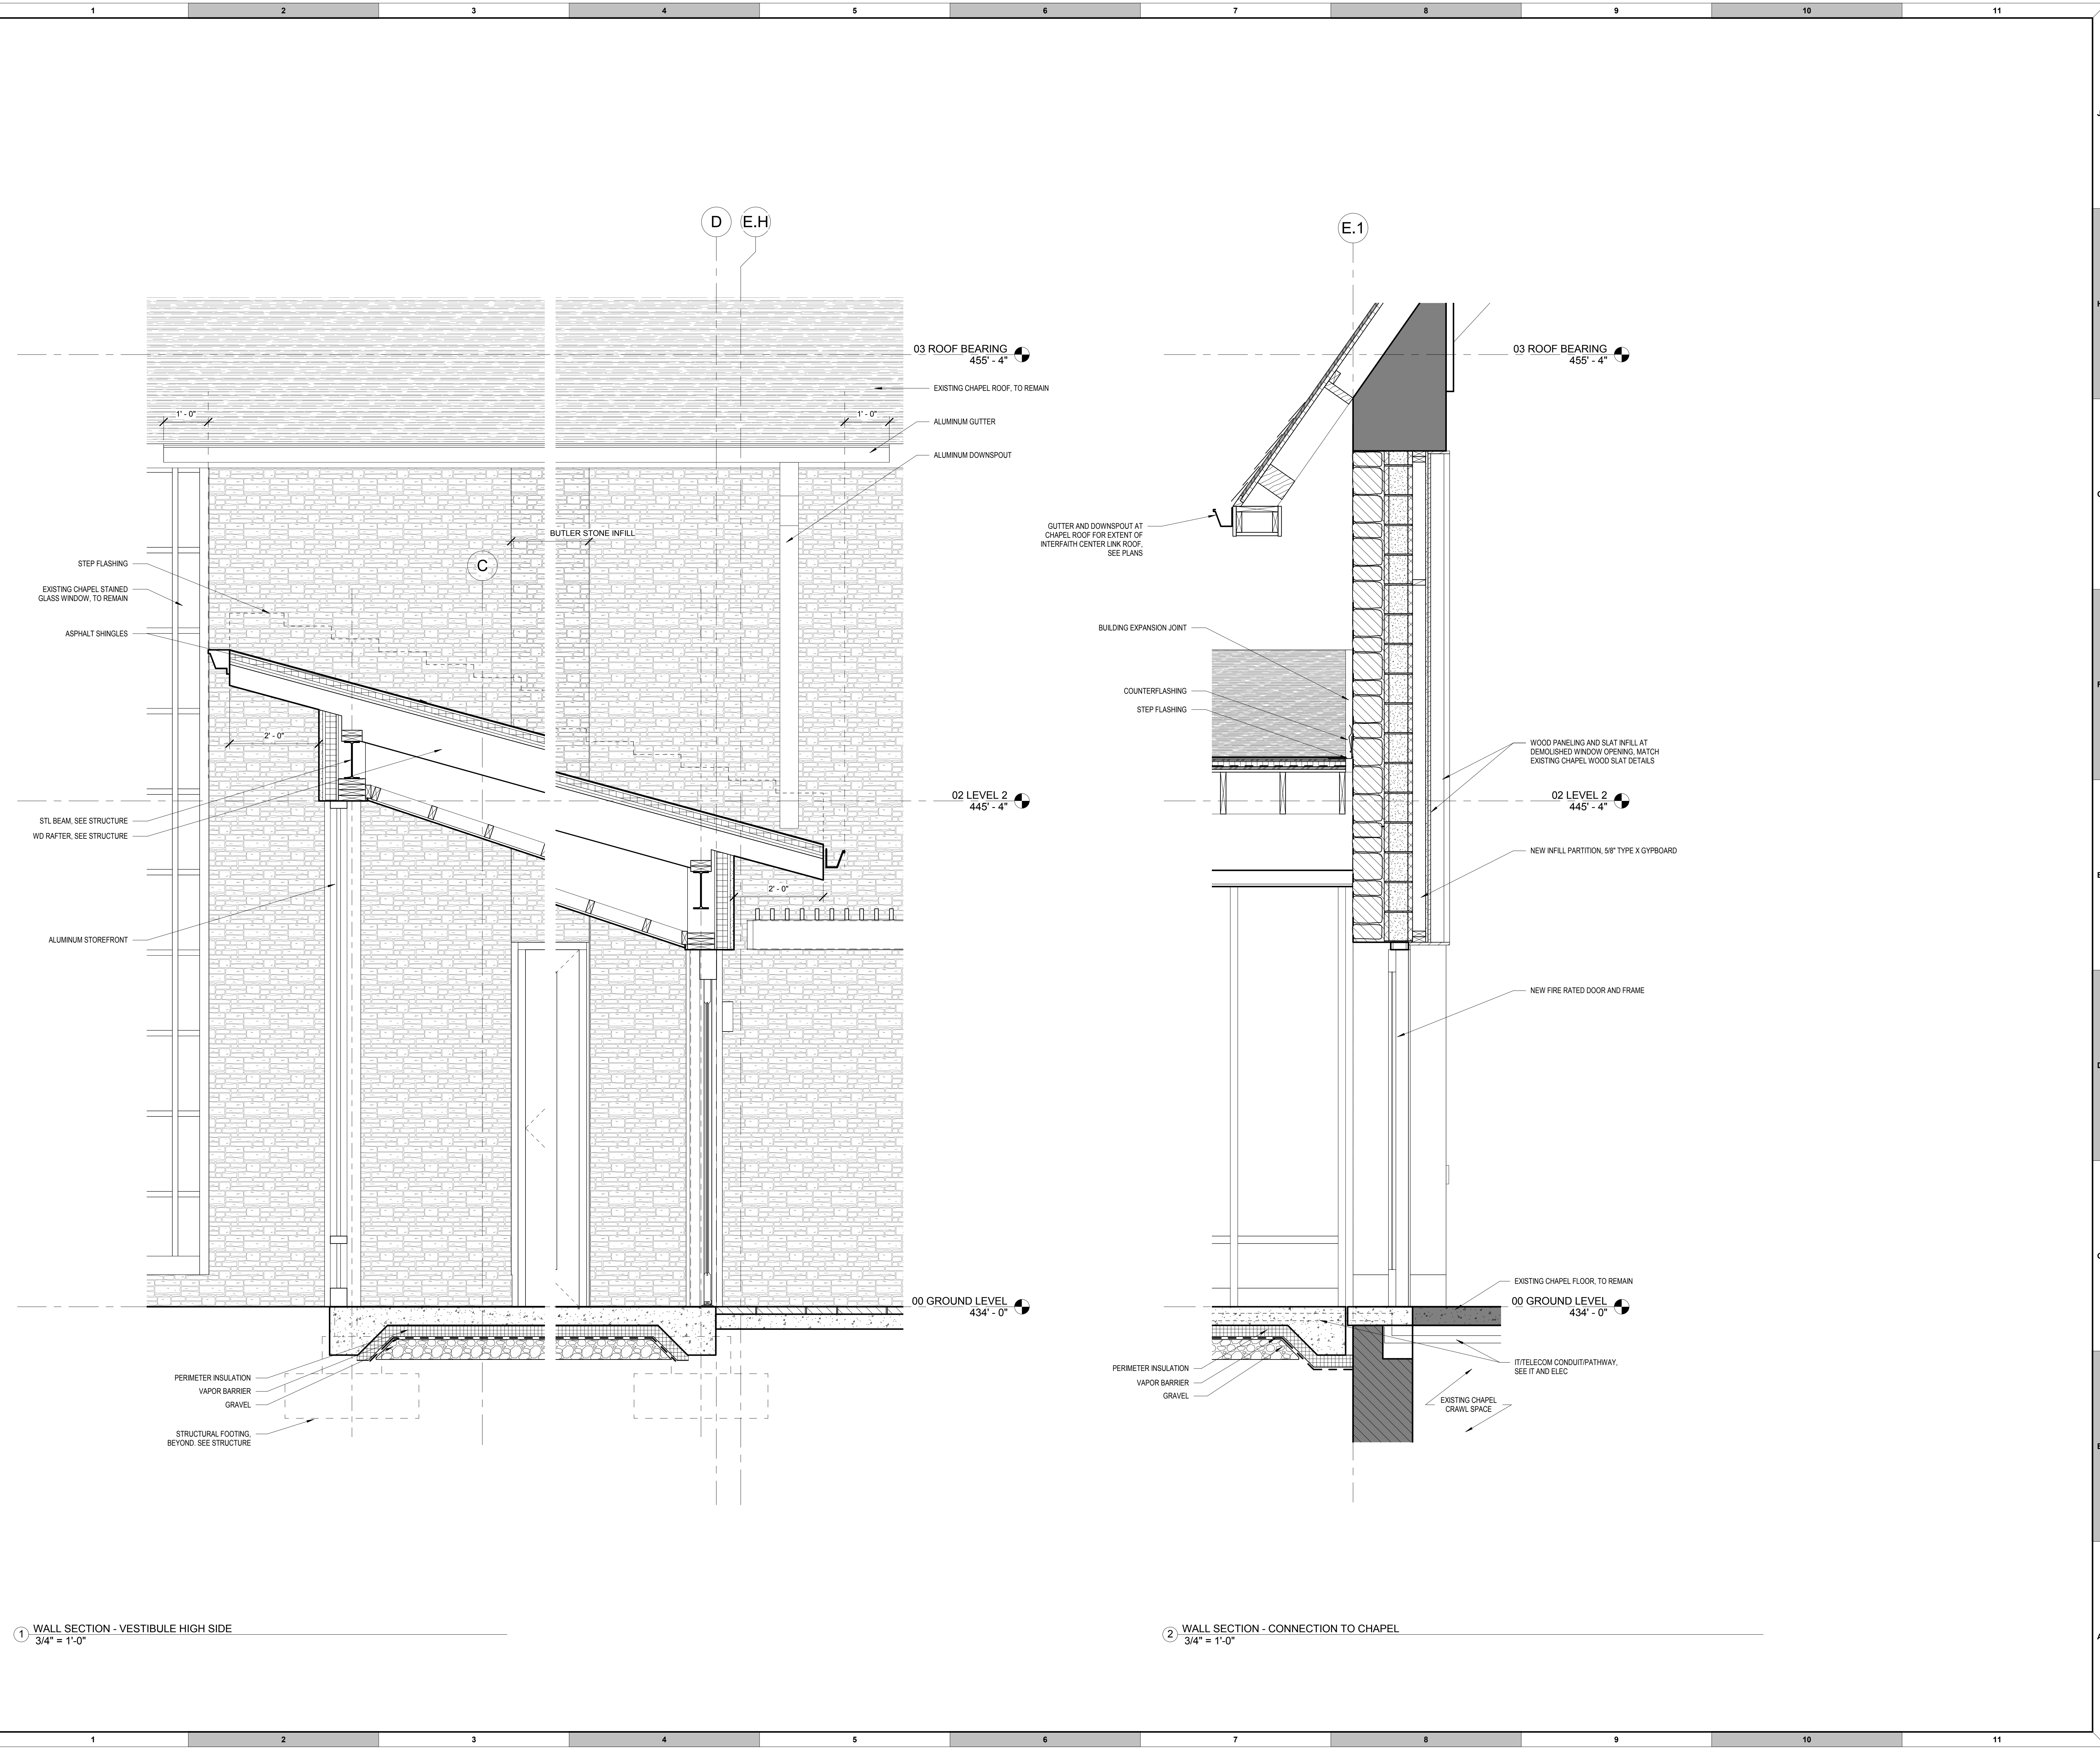1 WALL SECTION - VESTIBULE HIGH SIDE
3/4" = 1'-0"

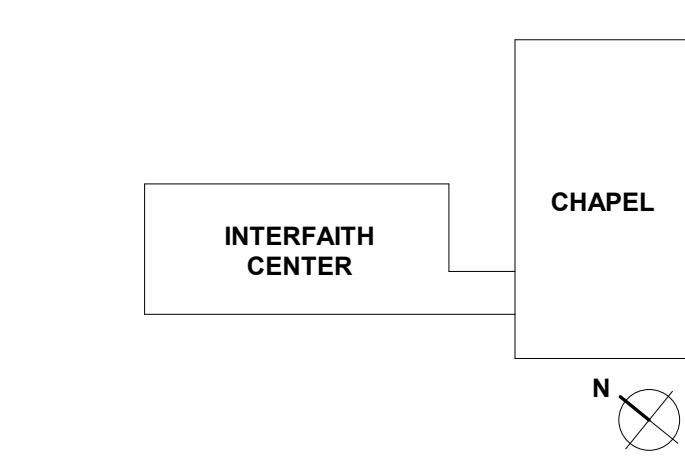
2 WALL SECTION - CONNECTION TO CHAPEL
3/4" = 1'-0"

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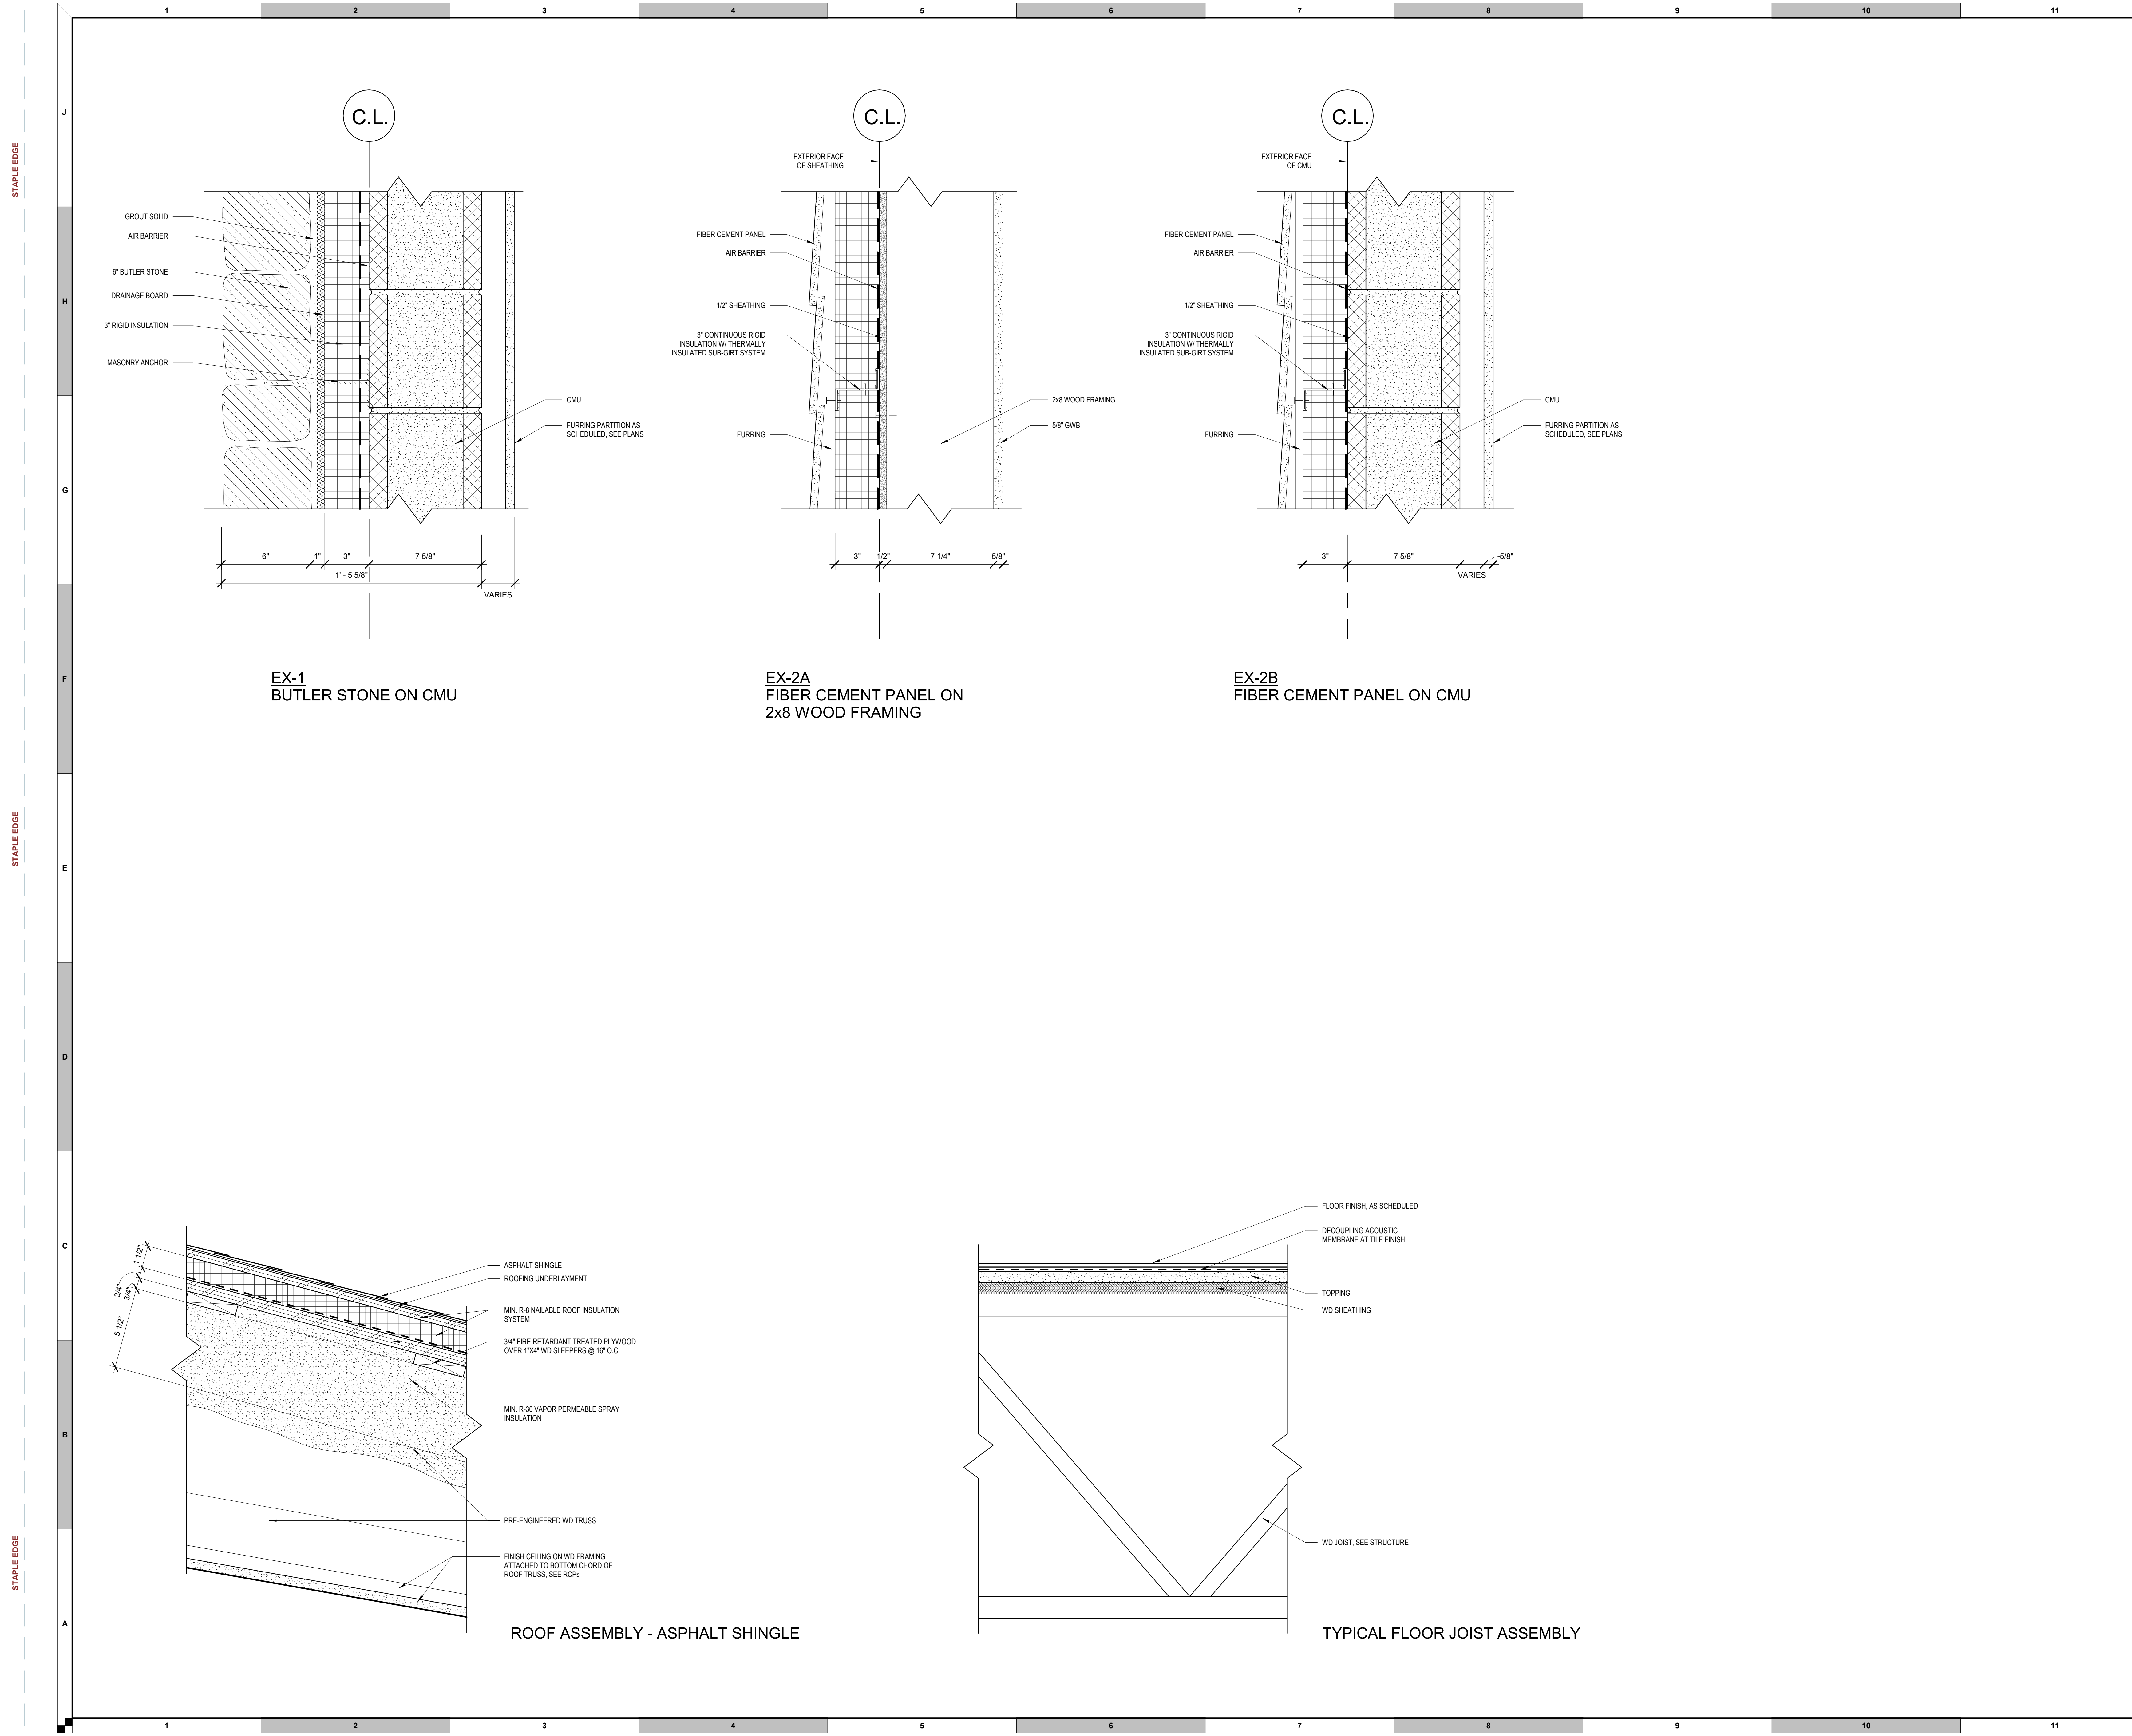
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50% CONSTRUCTION DOCUMENTS

DRAWING NAME
EXTERIOR ASSEMBLIES

DRAWING NUMBER
A5.11



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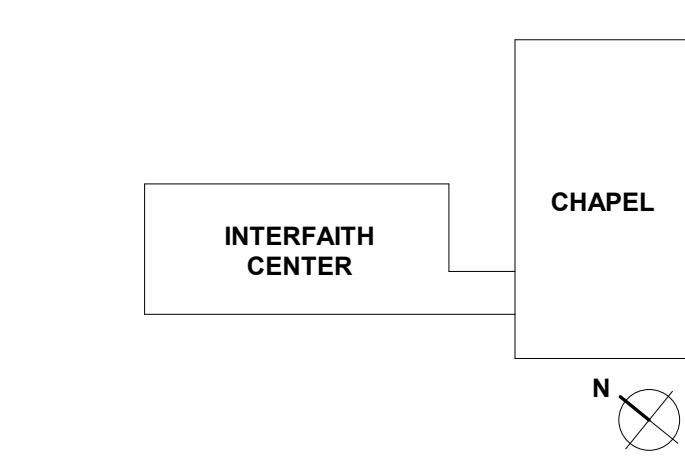
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REV. #	DESCRIPTION	DATE

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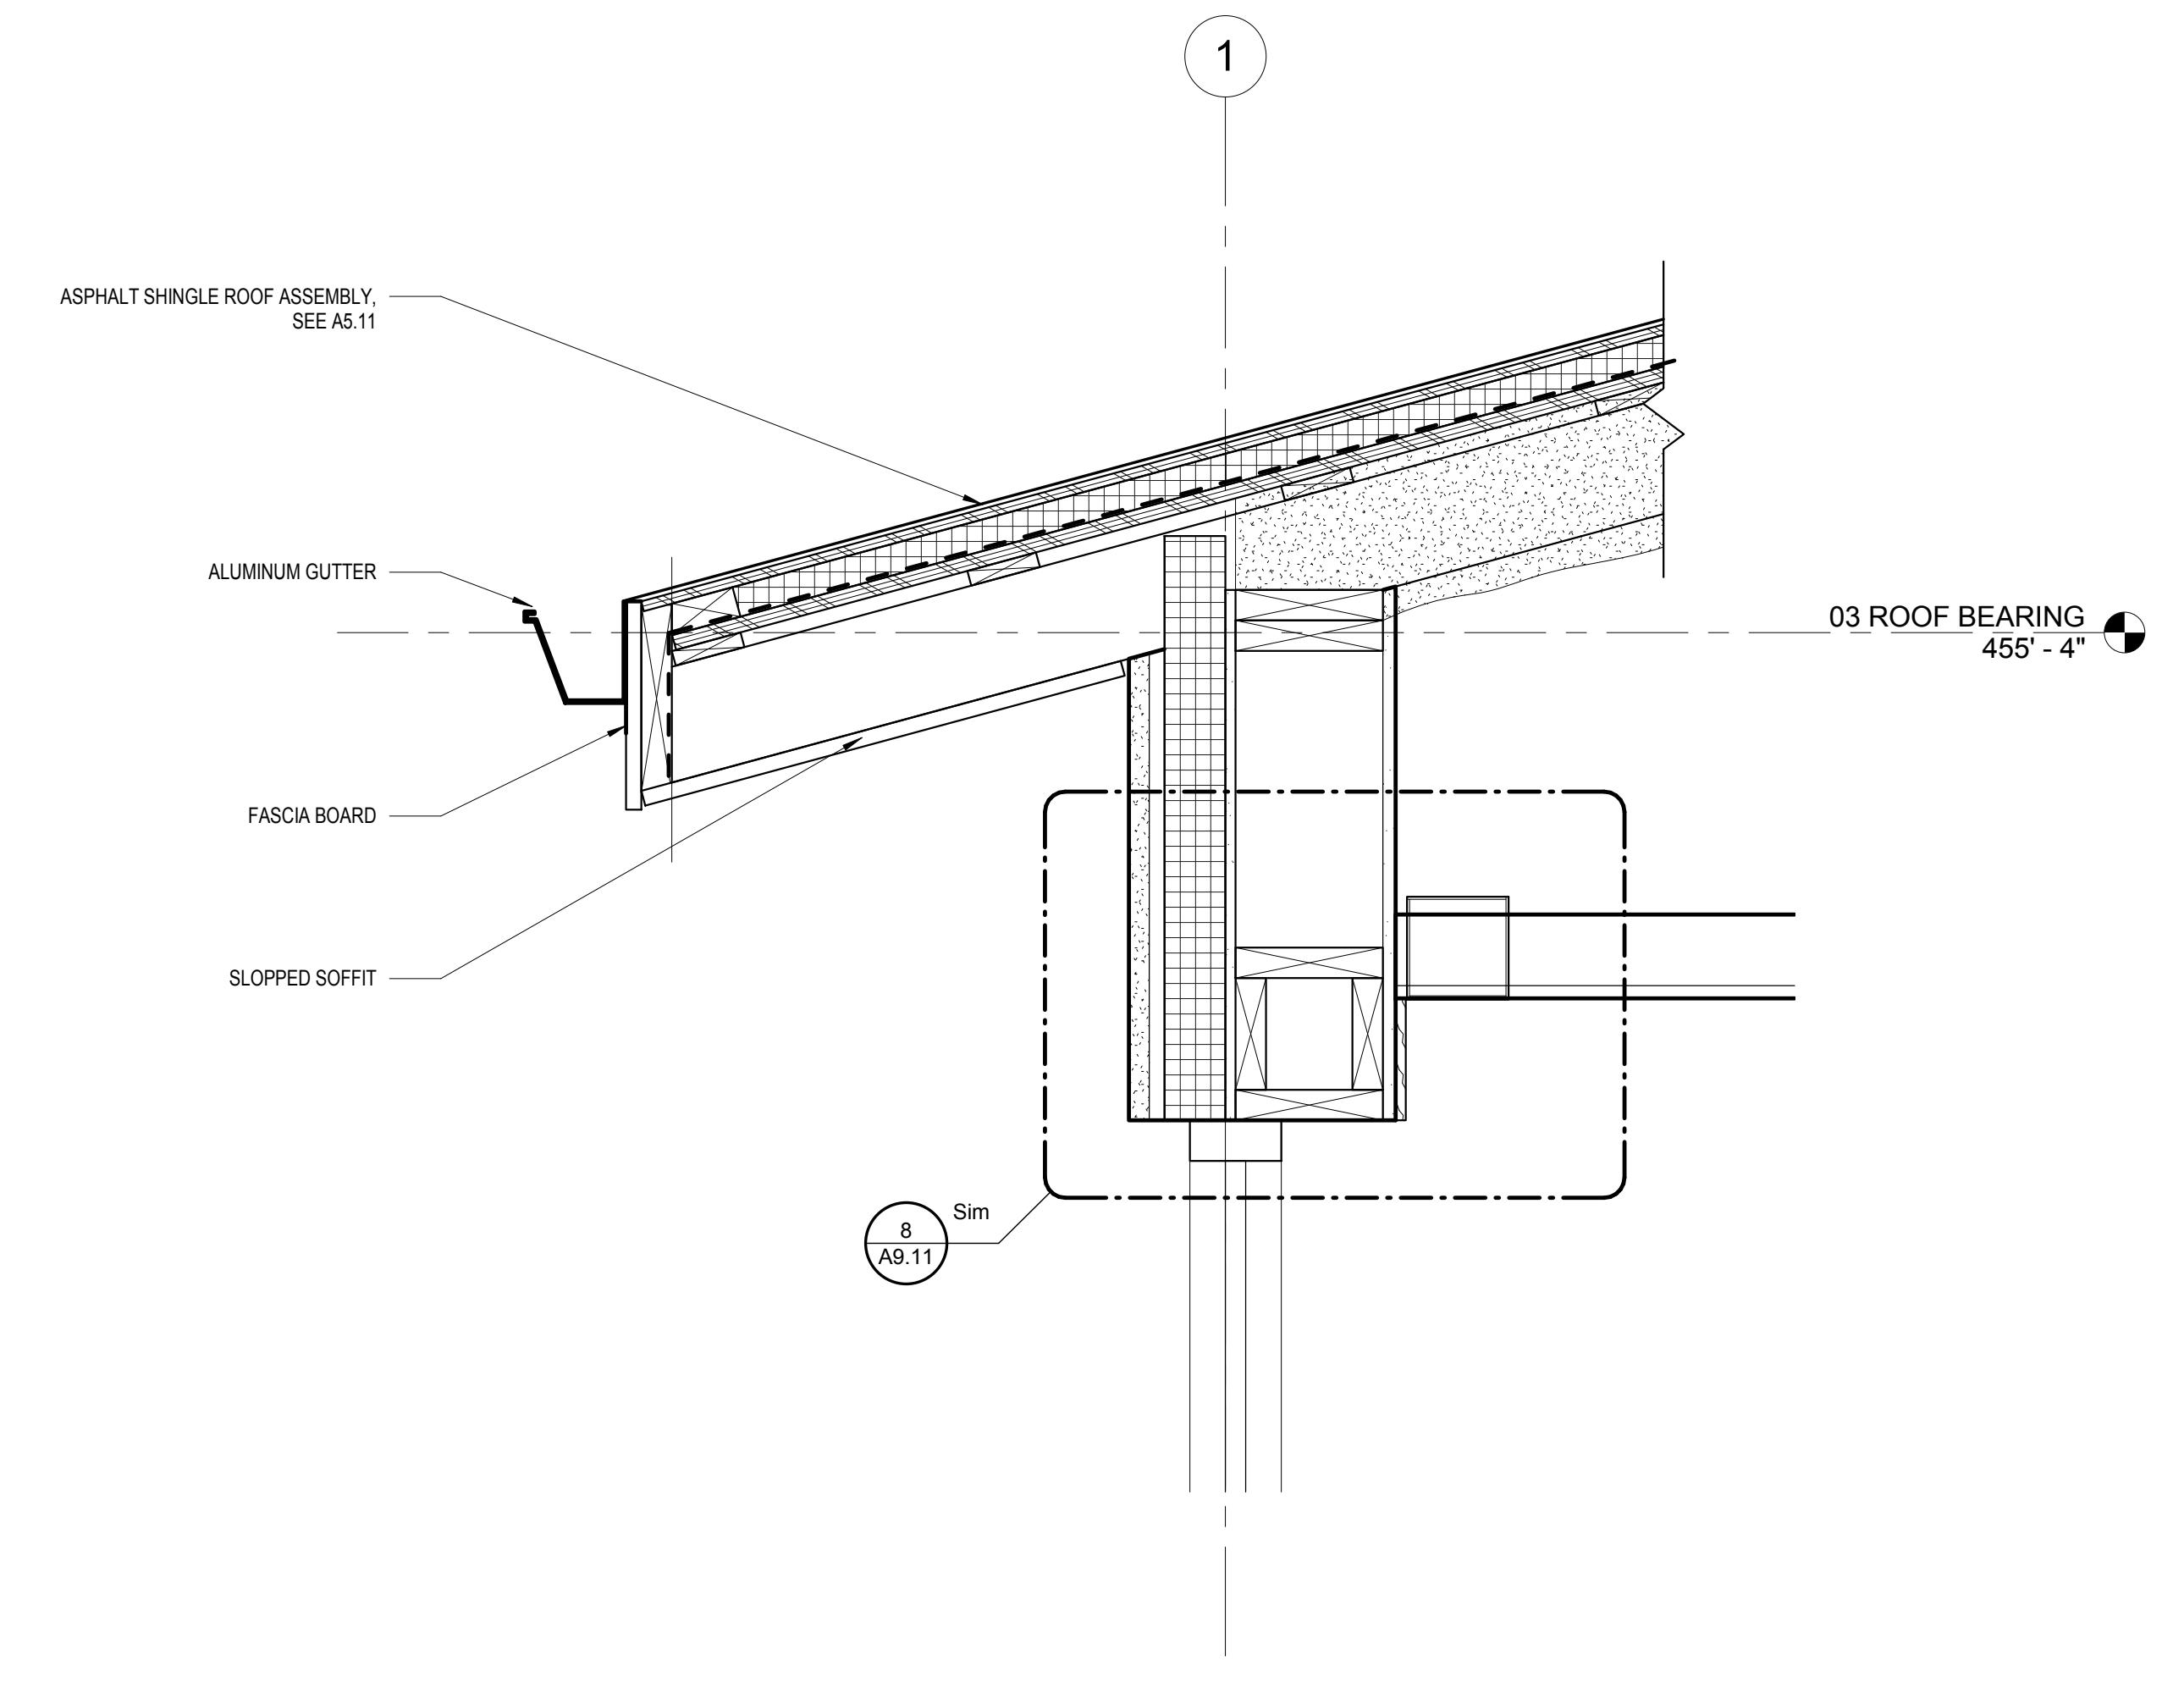
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SCALE:	1 1/2" = 1'-0"
JOB NO.:	21641.00
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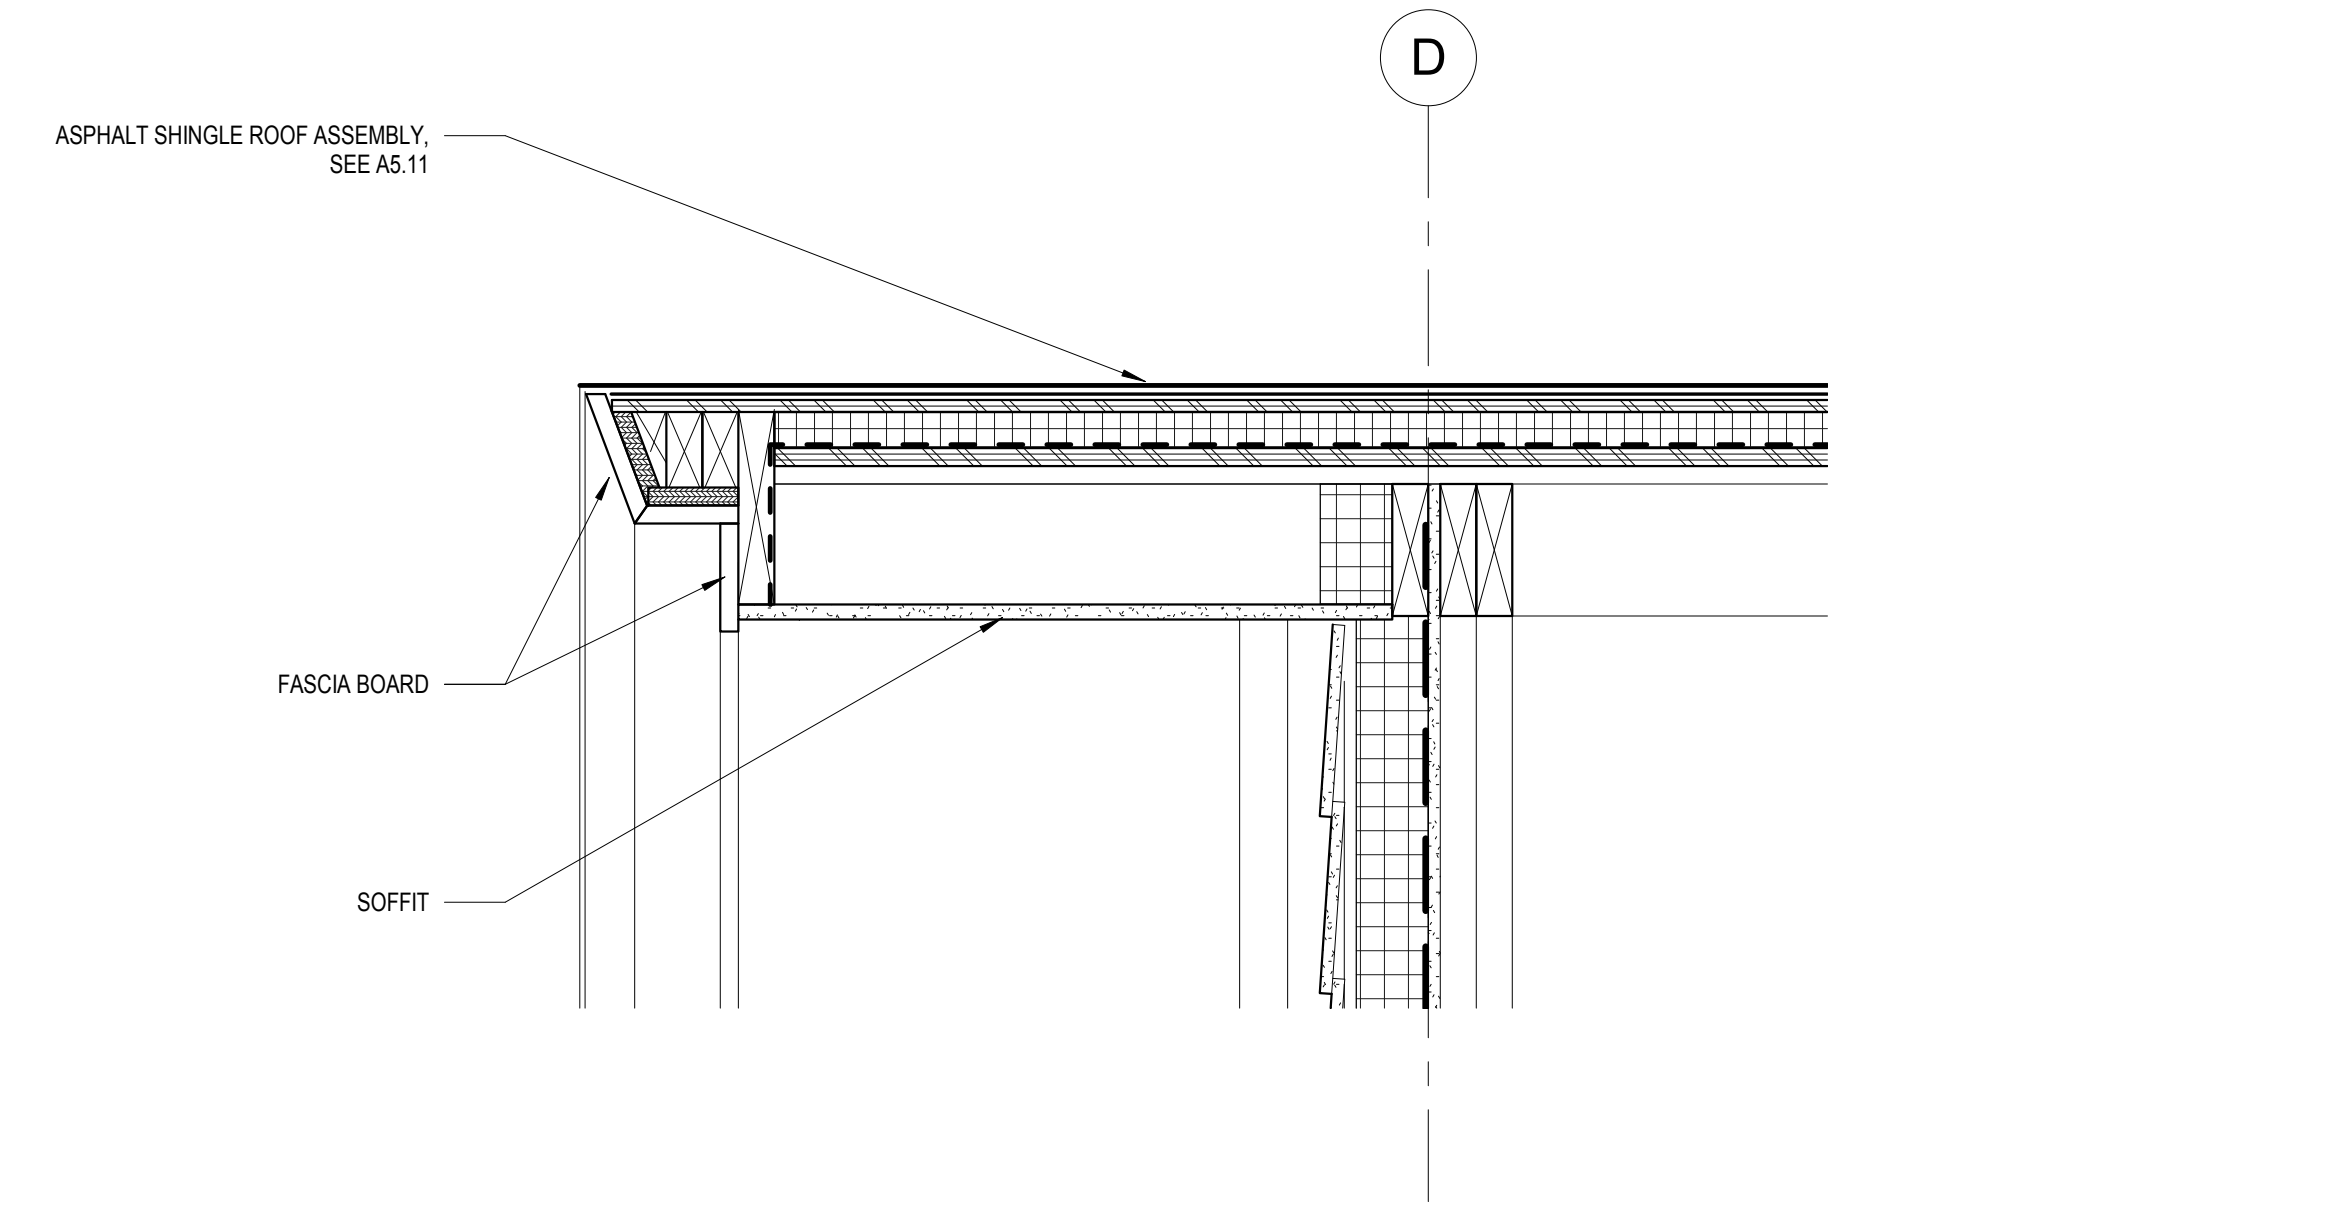
PROJECT DESIGN PHASE
50% CONSTRUCTION DOCUMENTS

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SECTION DETAILS - EXTERIOR

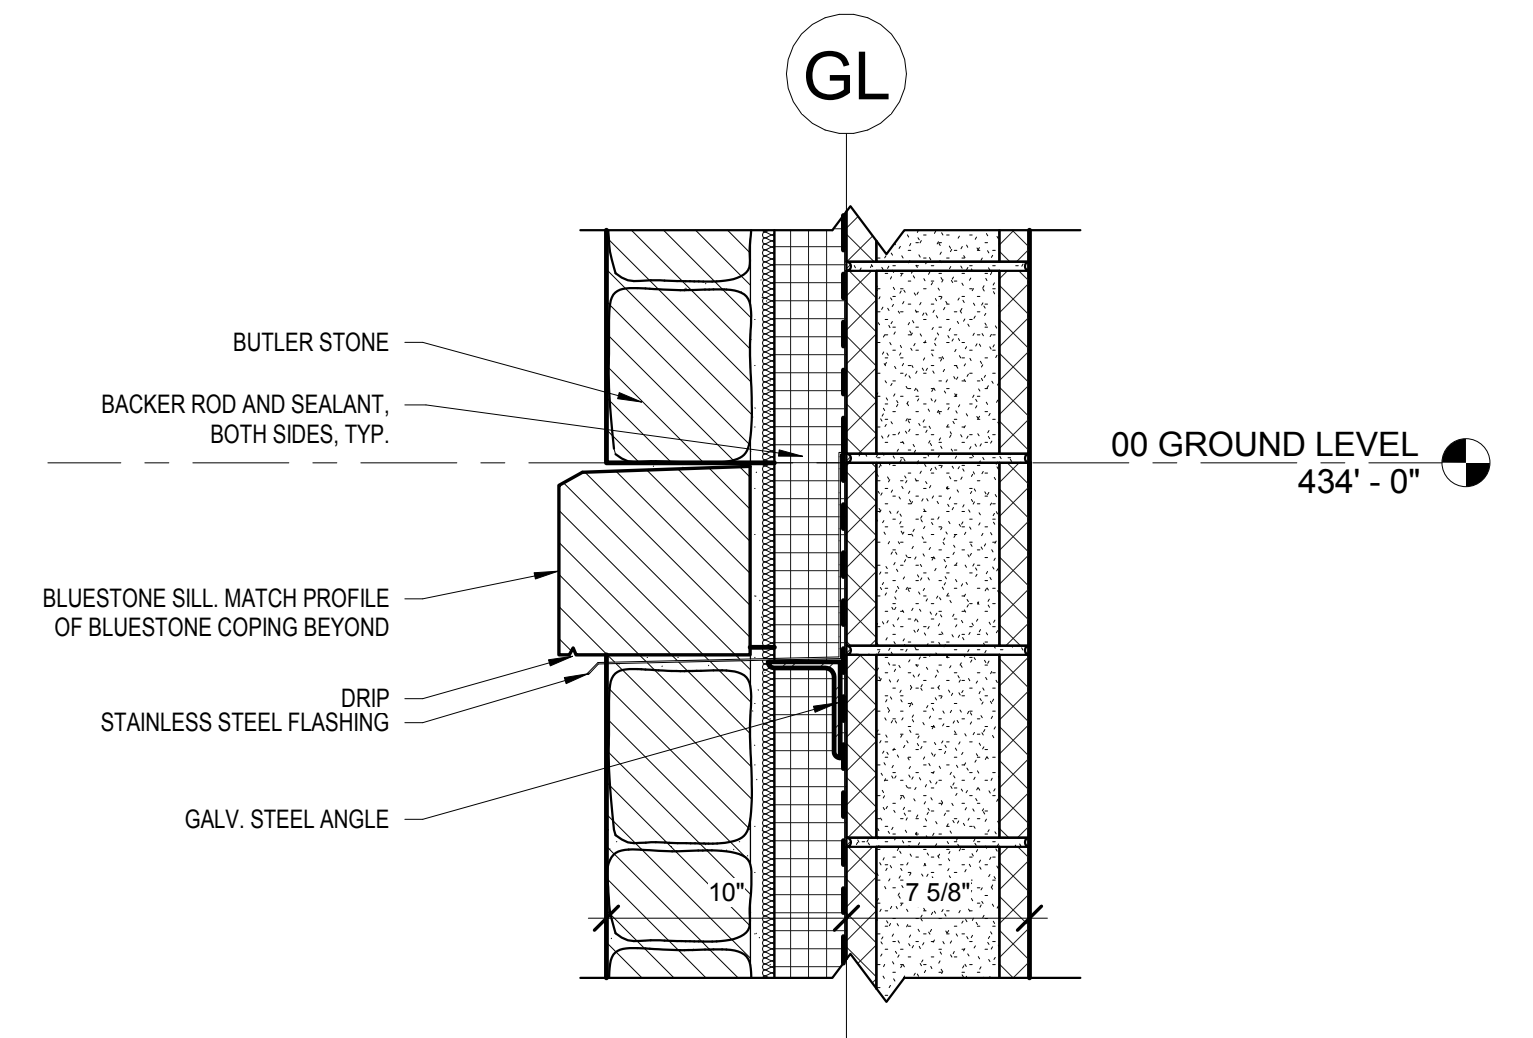
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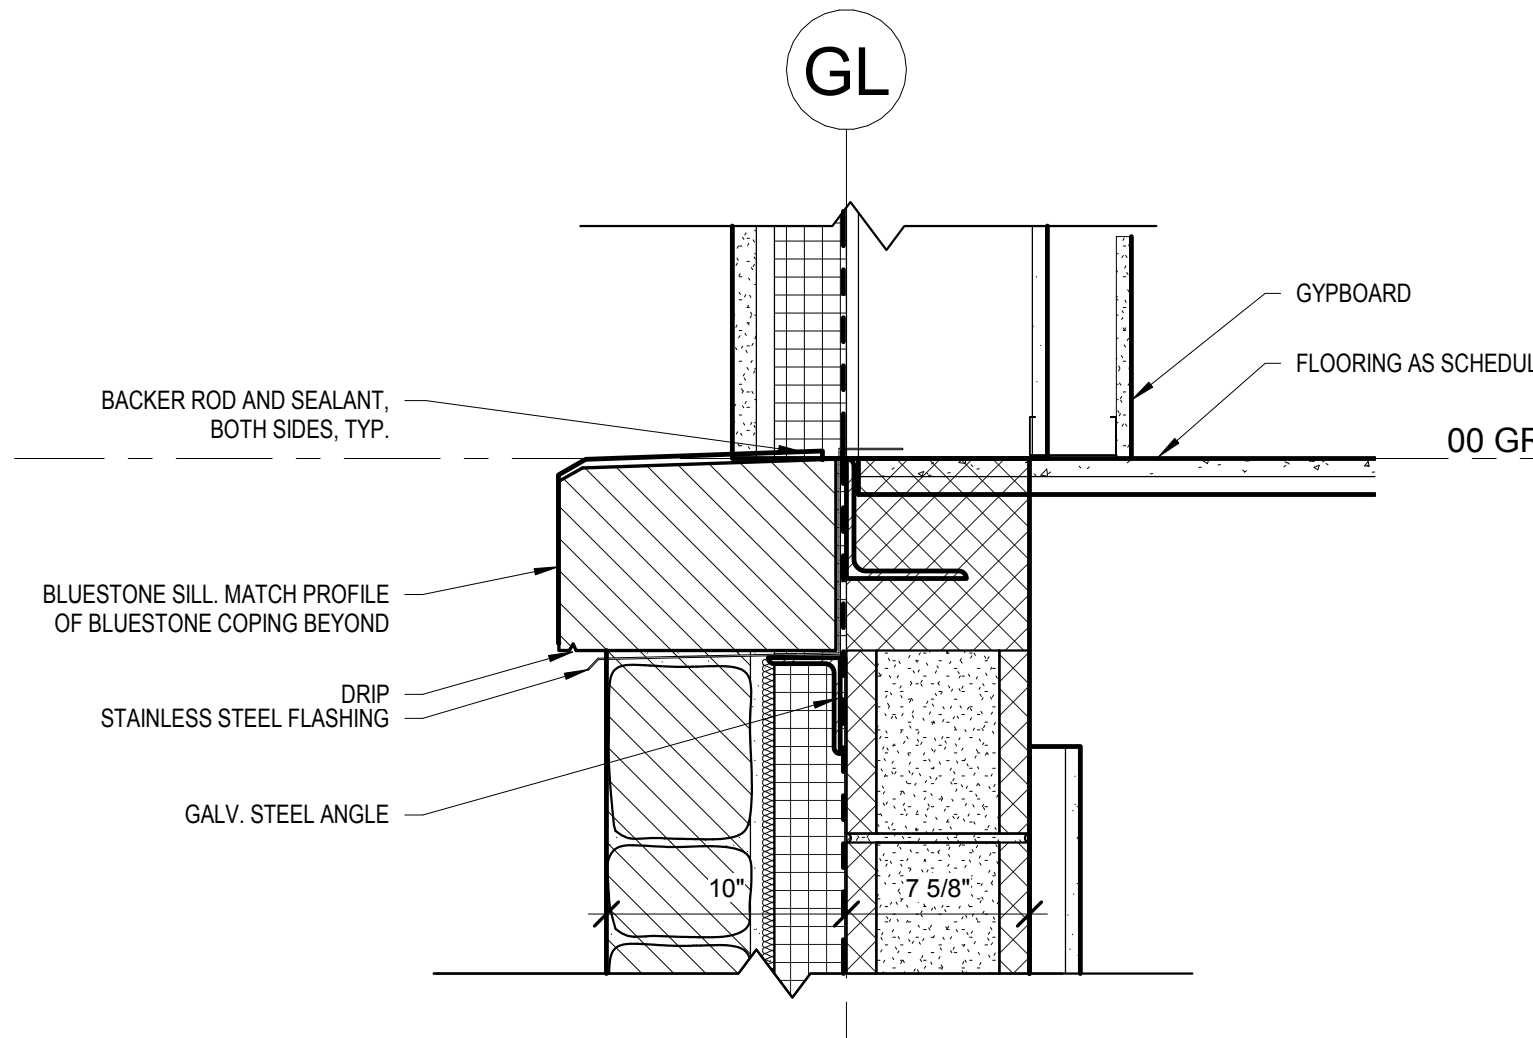
① TYPICAL GUTTER ROOF EAVE
1 1/2" = 1'-0"




② TYPICAL ROOF EAVE
1 1/2" = 1'-0"



① BUTLER STONE CAP AT ELEVATOR
1 1/2" = 1'-0"



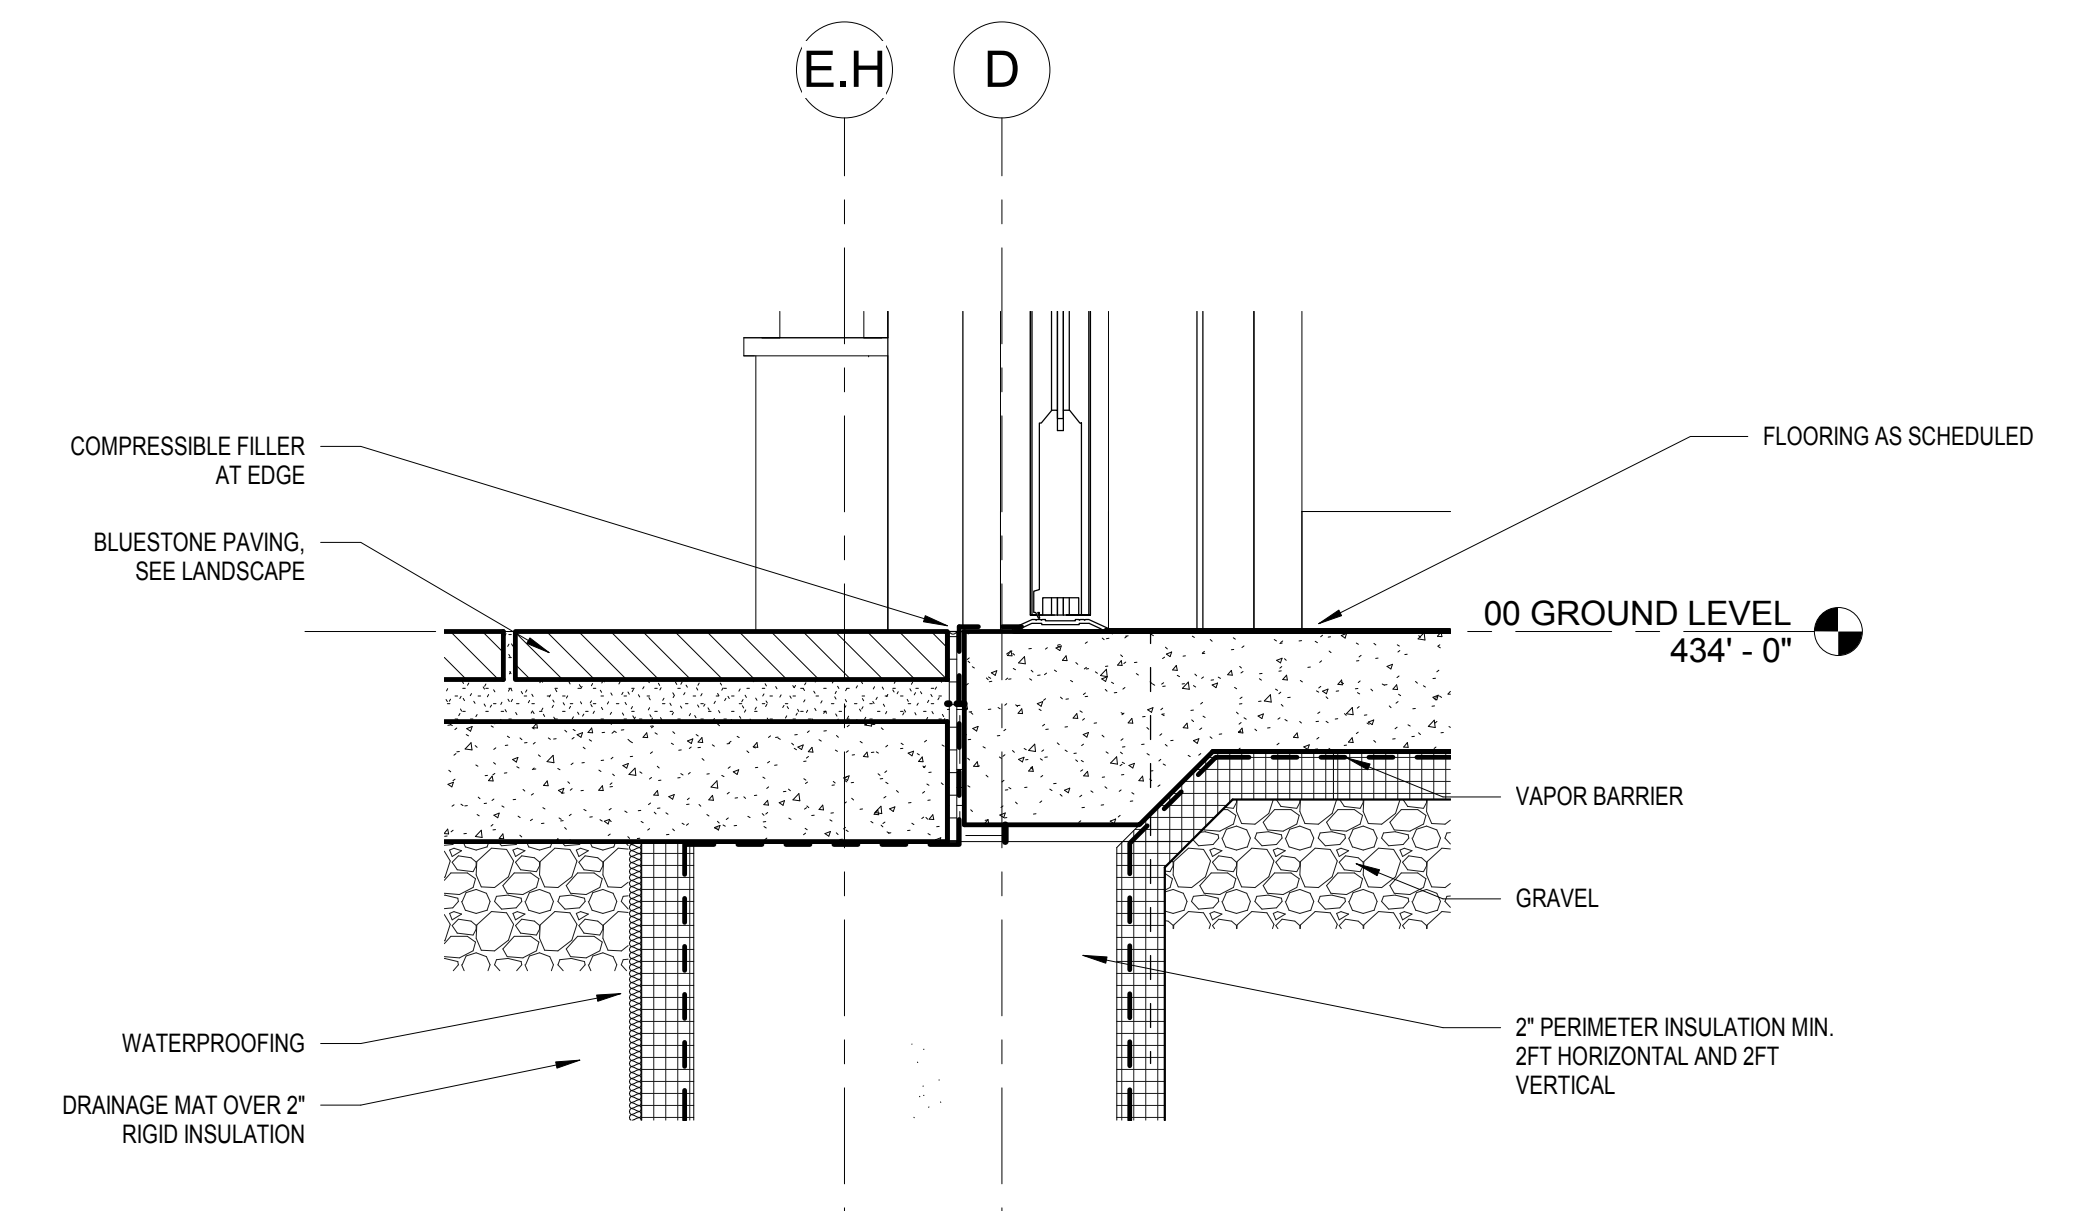② BUTLER STONE CAP AT TYPICAL WALL
1 1/2" = 1'-0"



④ WALL SECTION - BUILDING ENTRY - Callout 1
1 1/2" = 1'-0"

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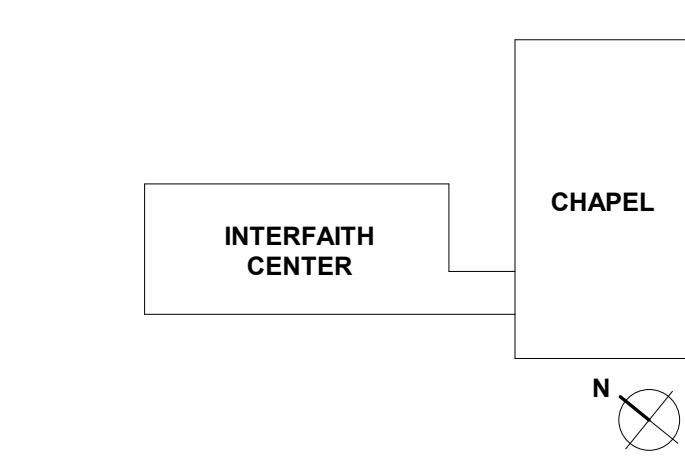
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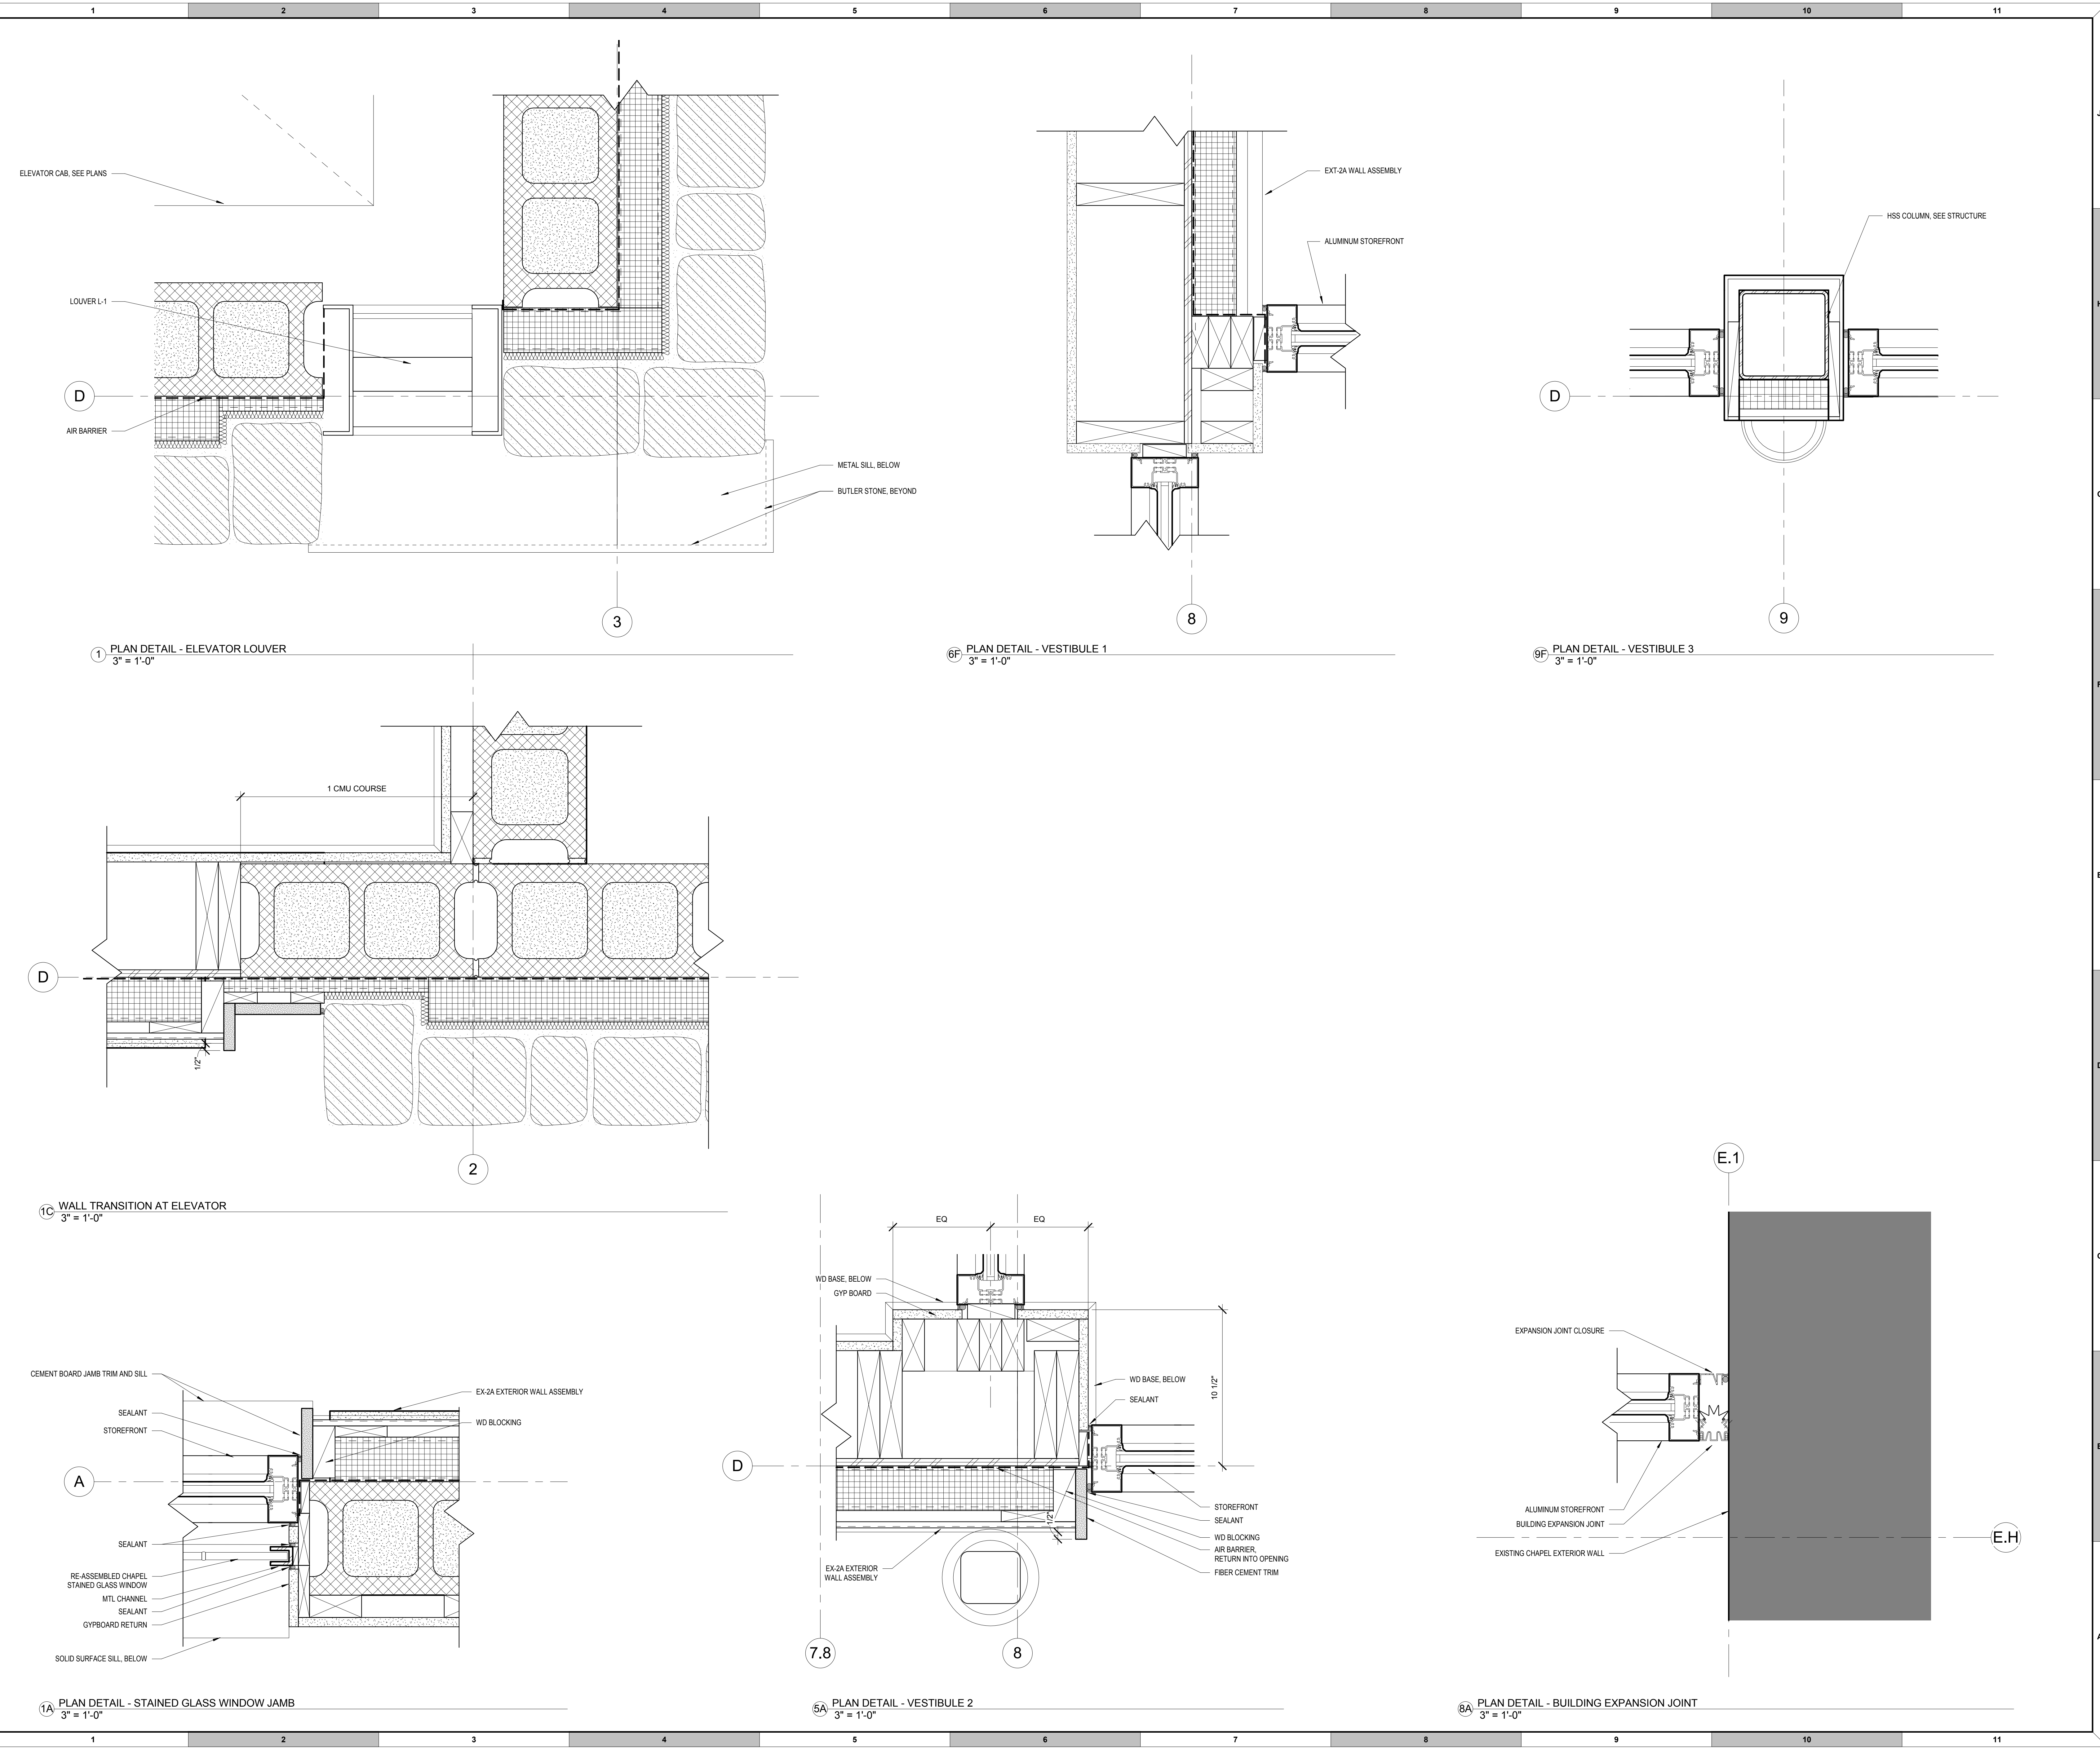
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DRAWING NAME
PLAN DETAILS - EXTERIOR

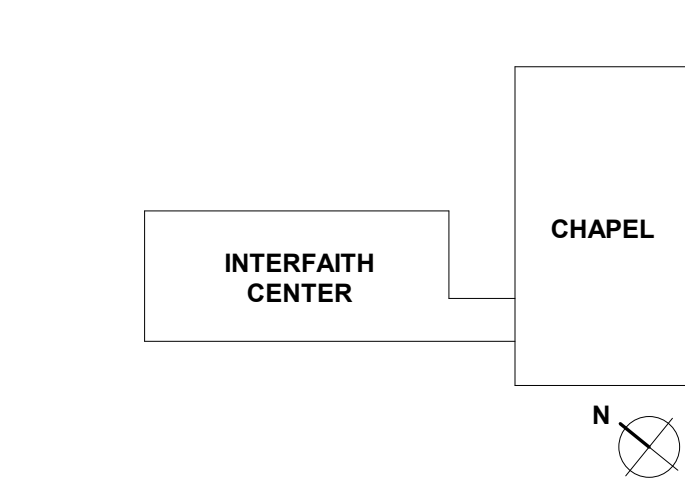
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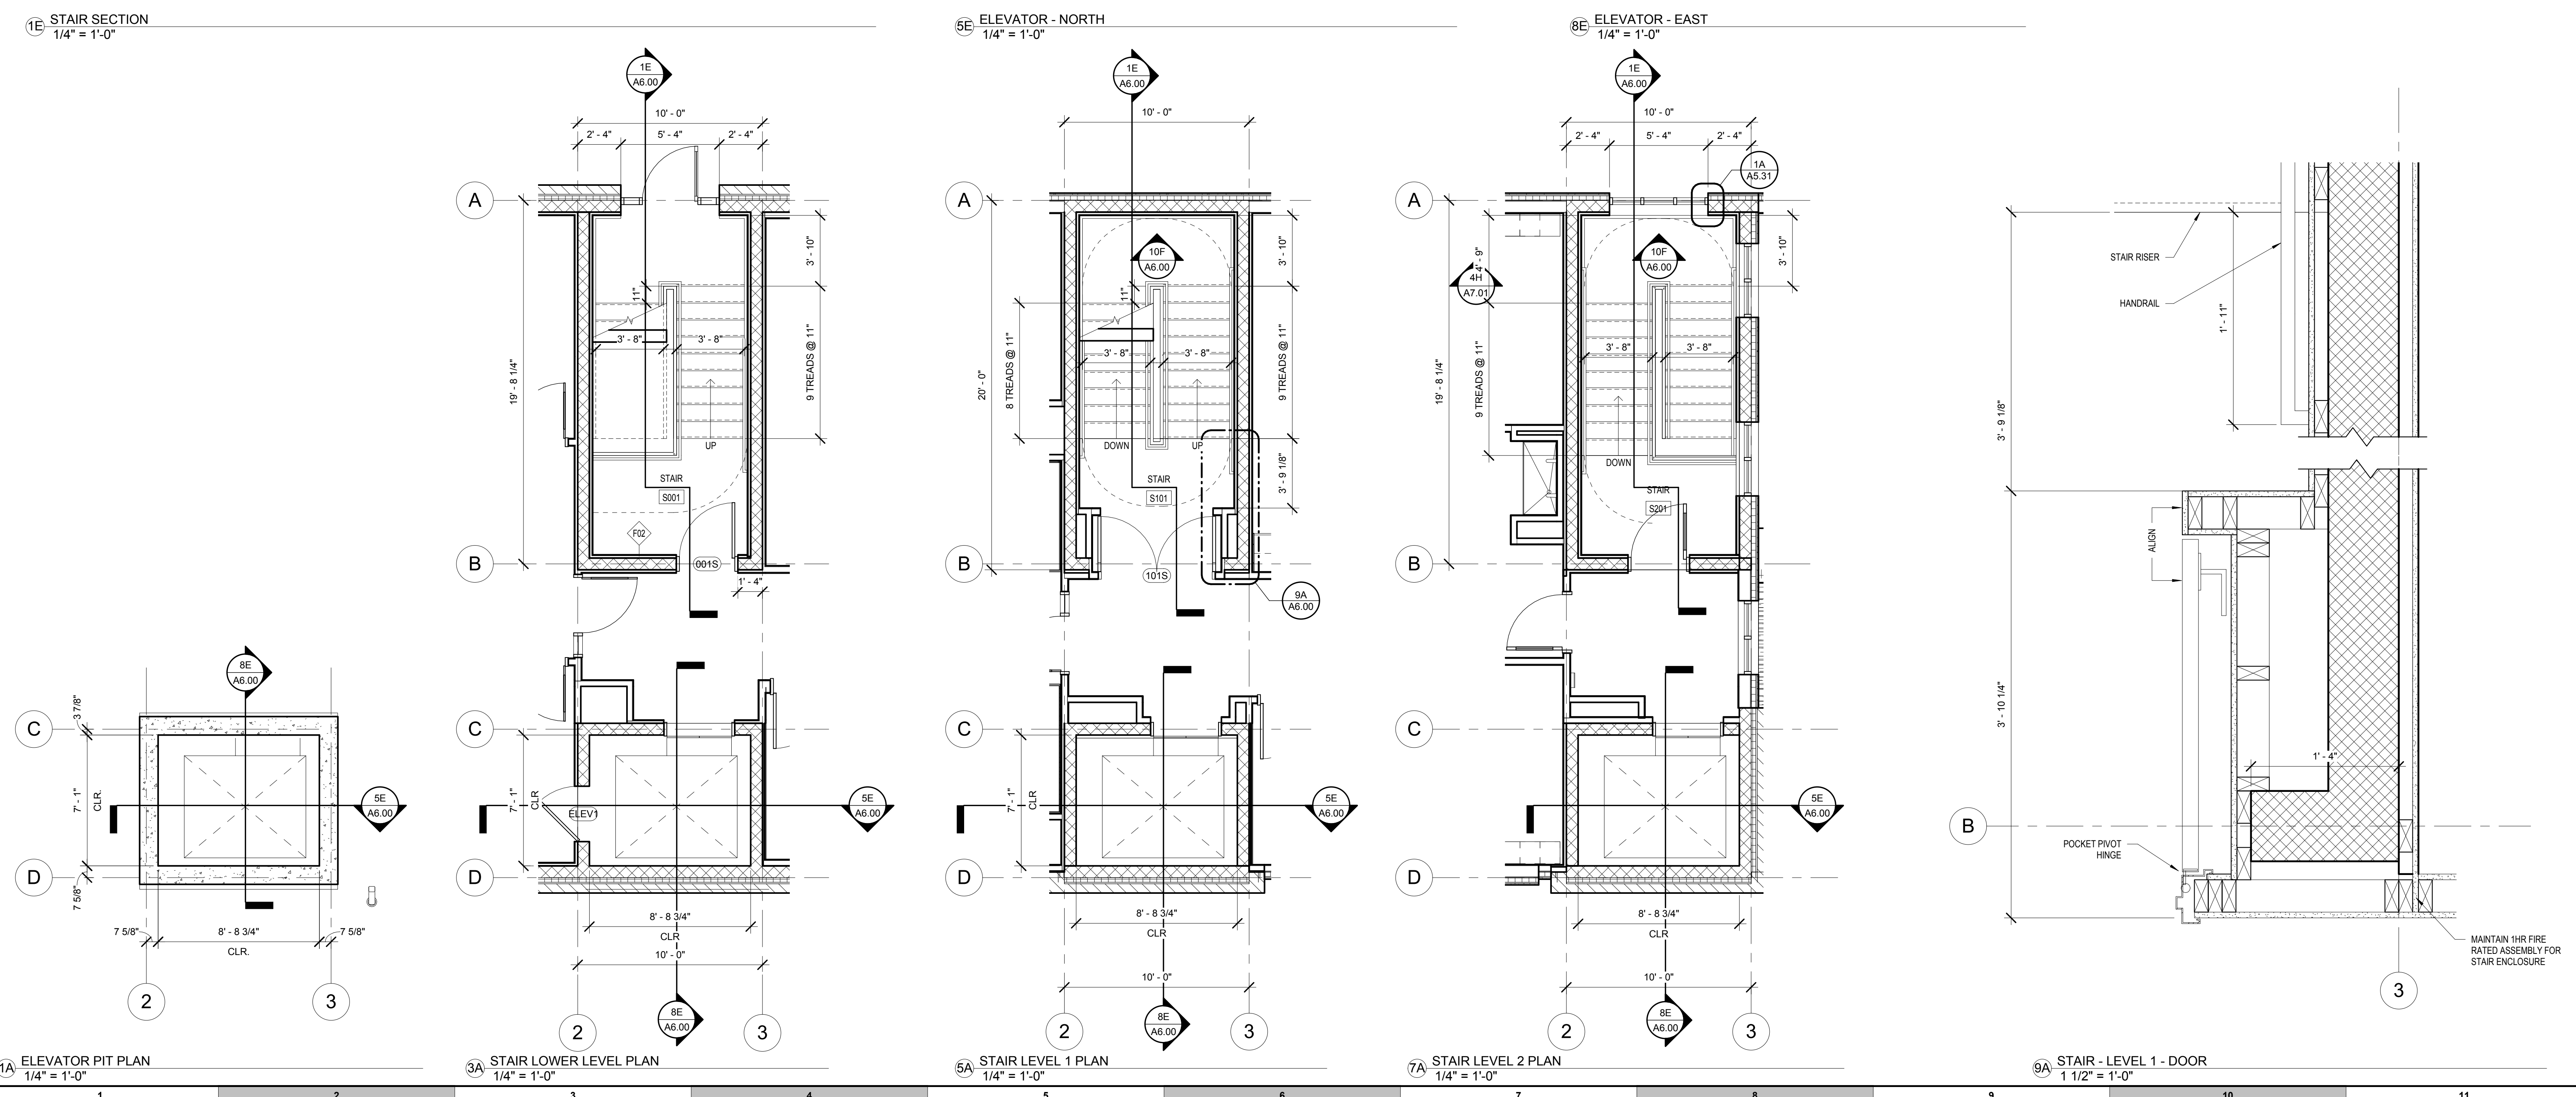
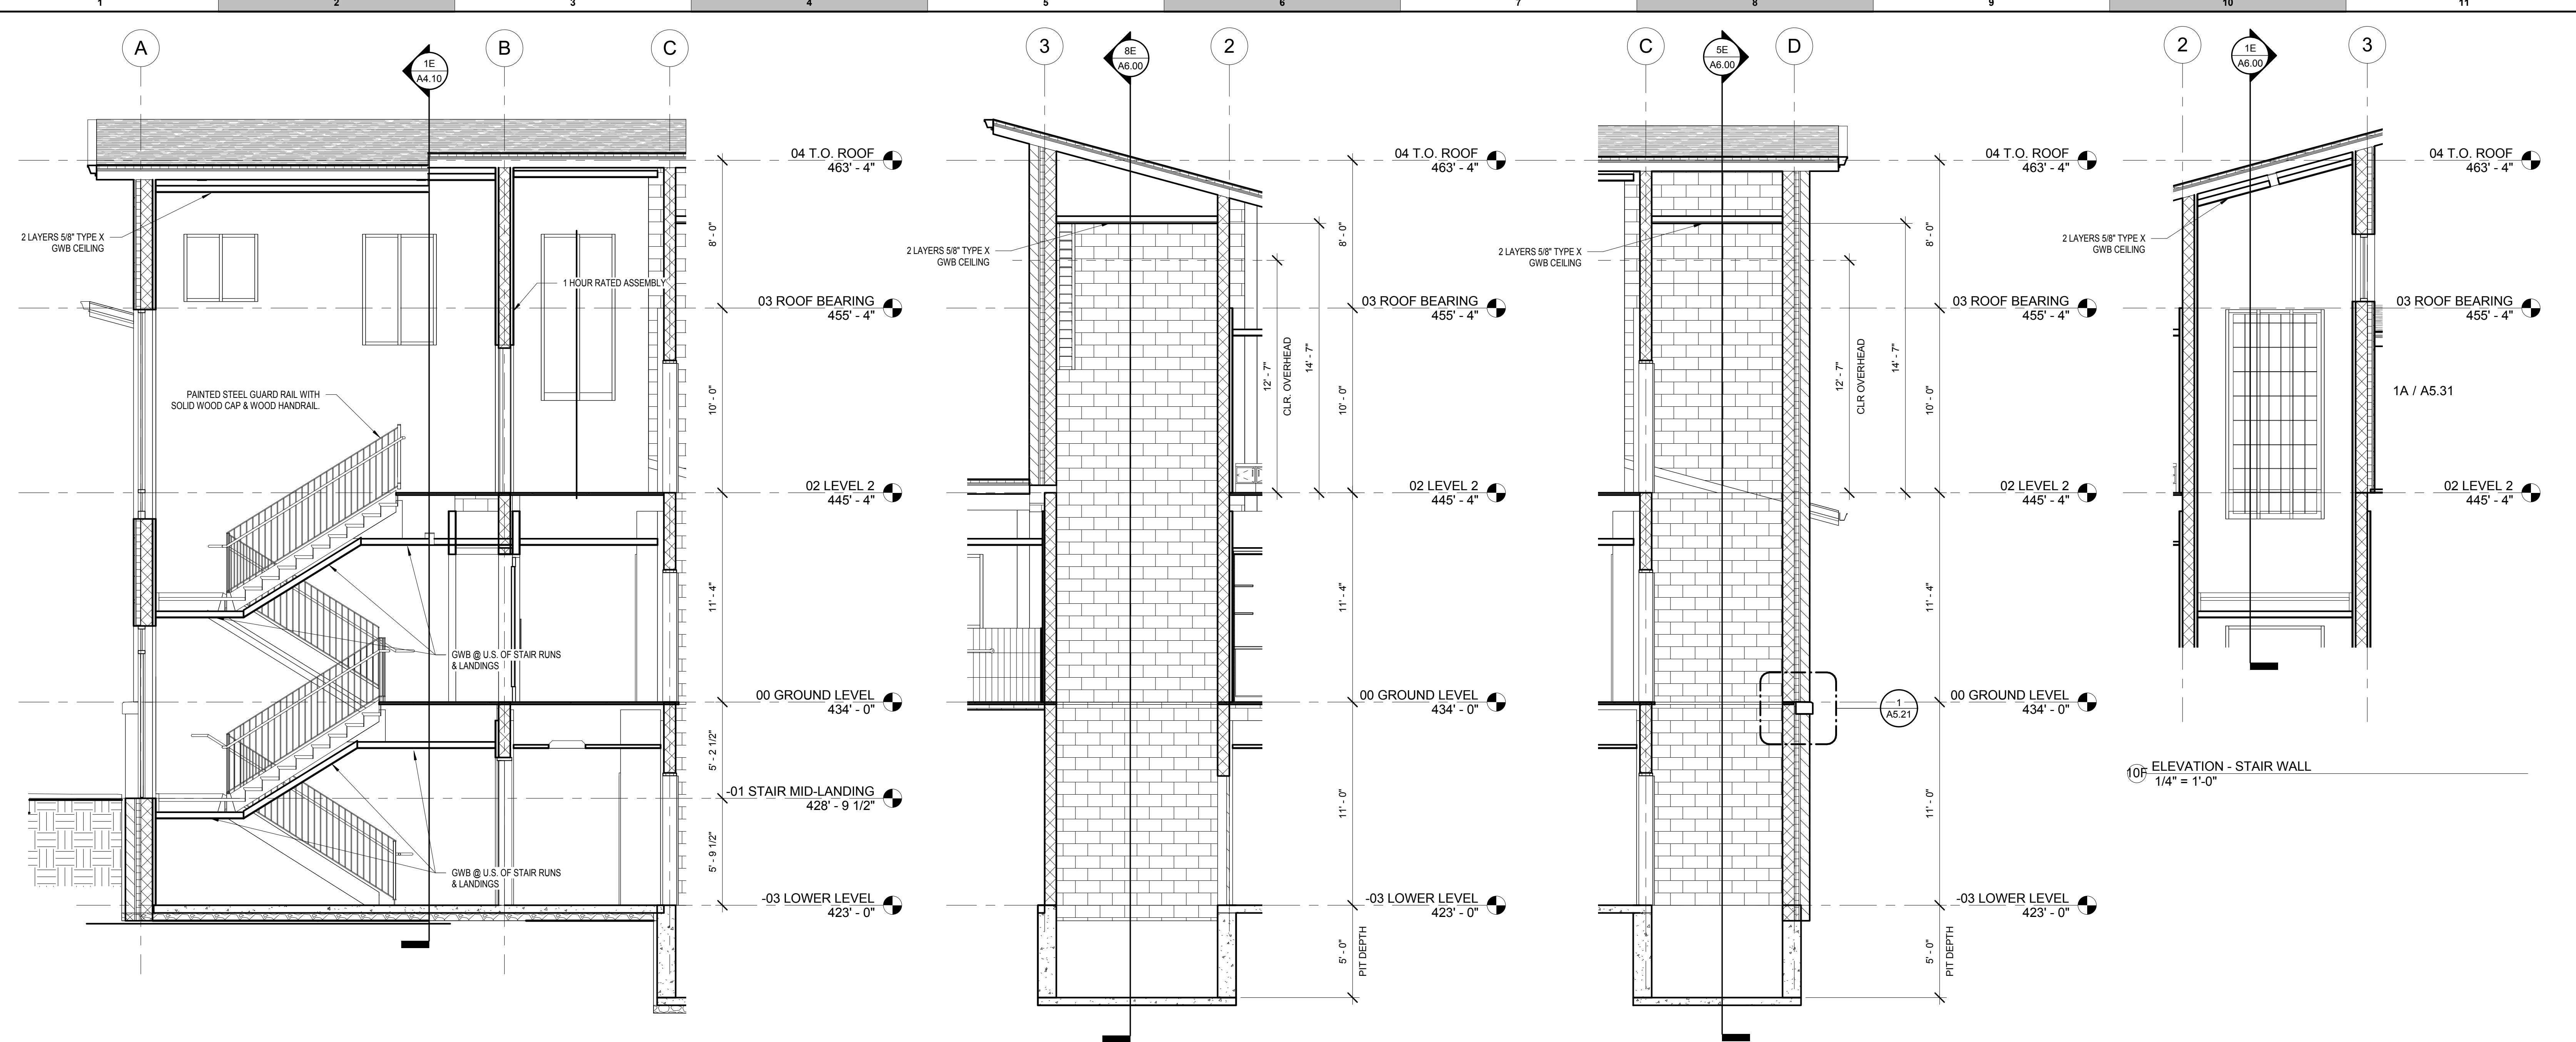
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PROJECT DESIGN PHASE
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STAIR AND ELEVATOR PLANS & SECTIONS

DRAWING NUMBER
A6.00

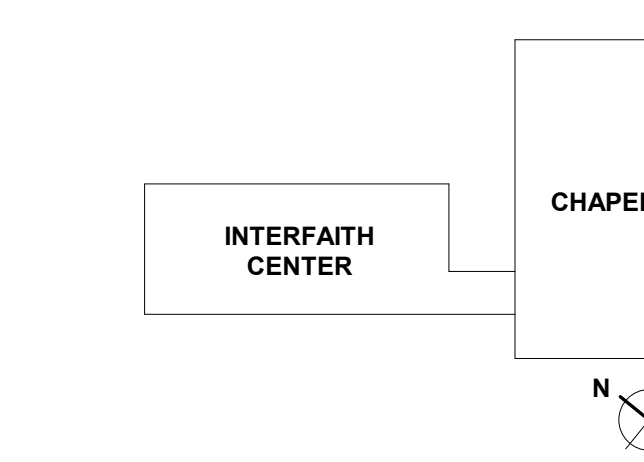


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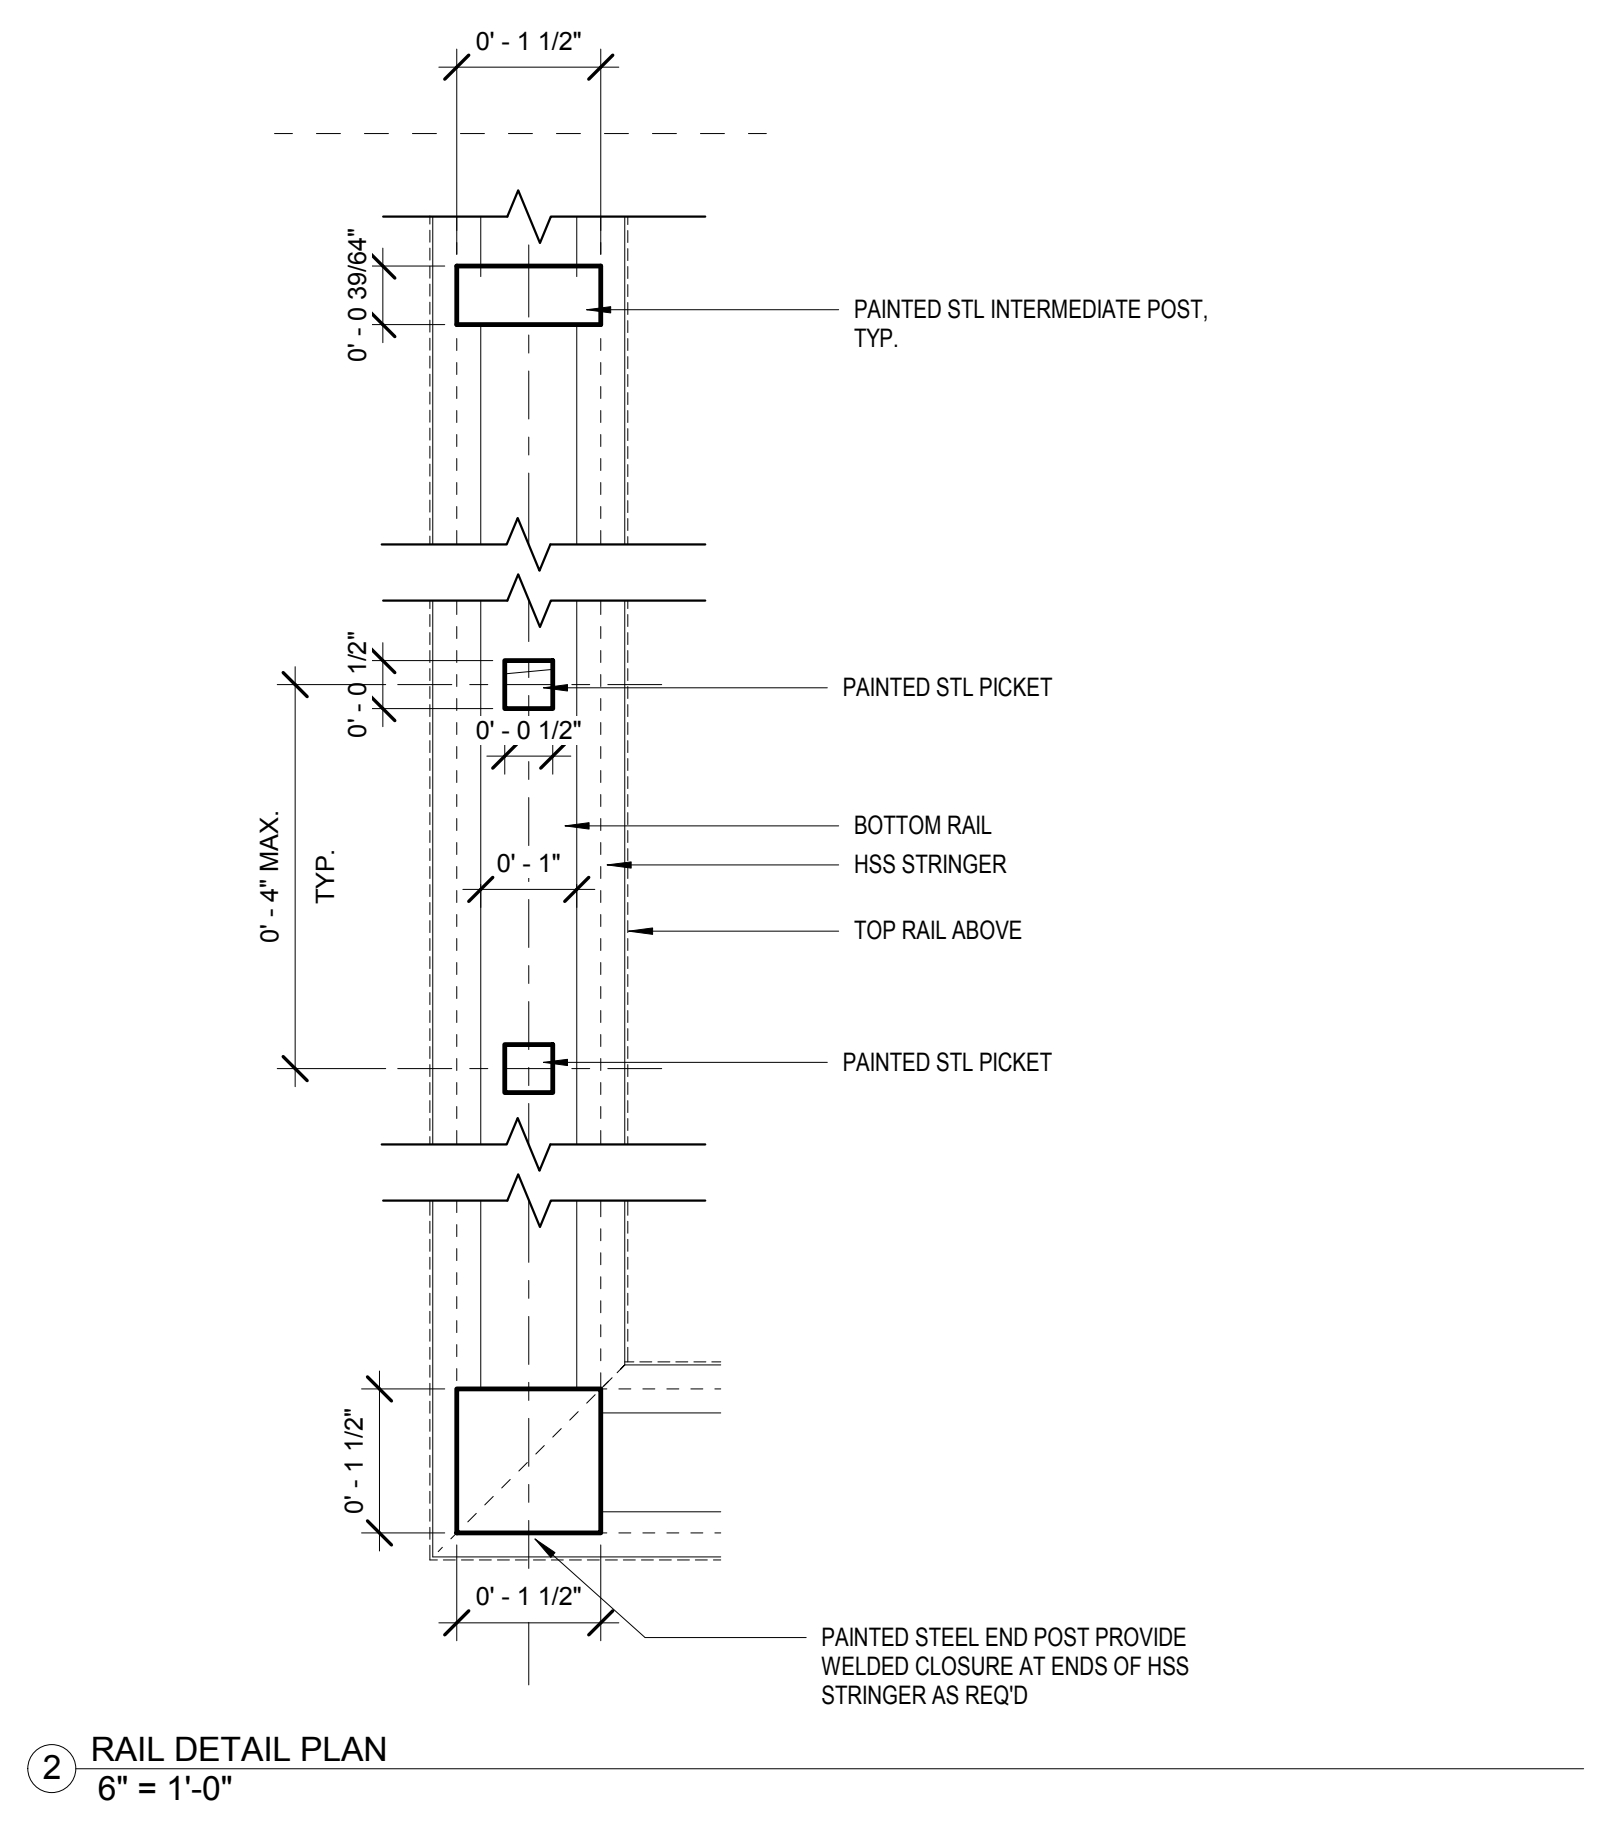
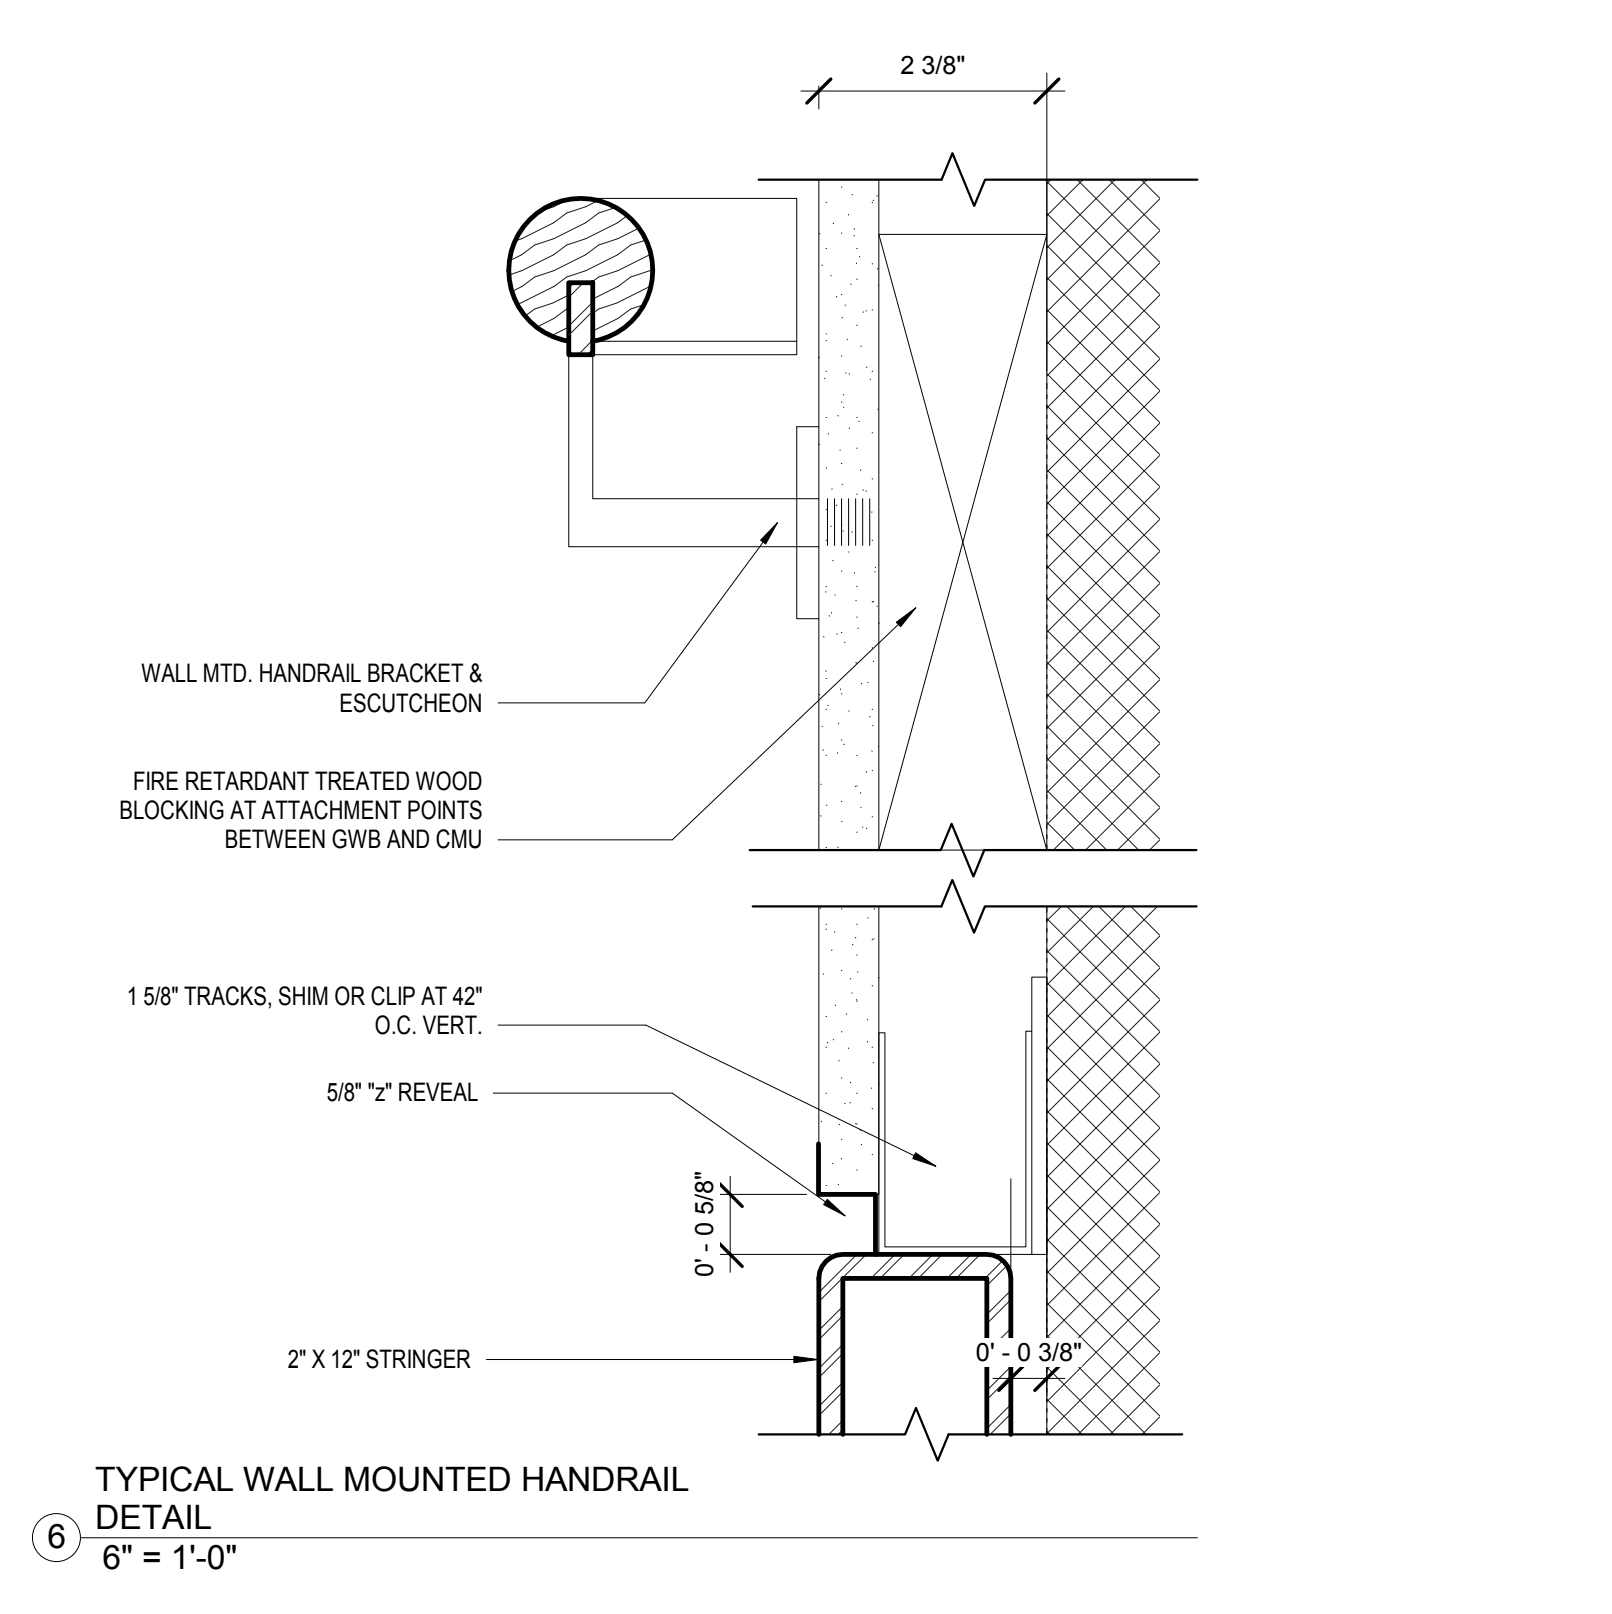
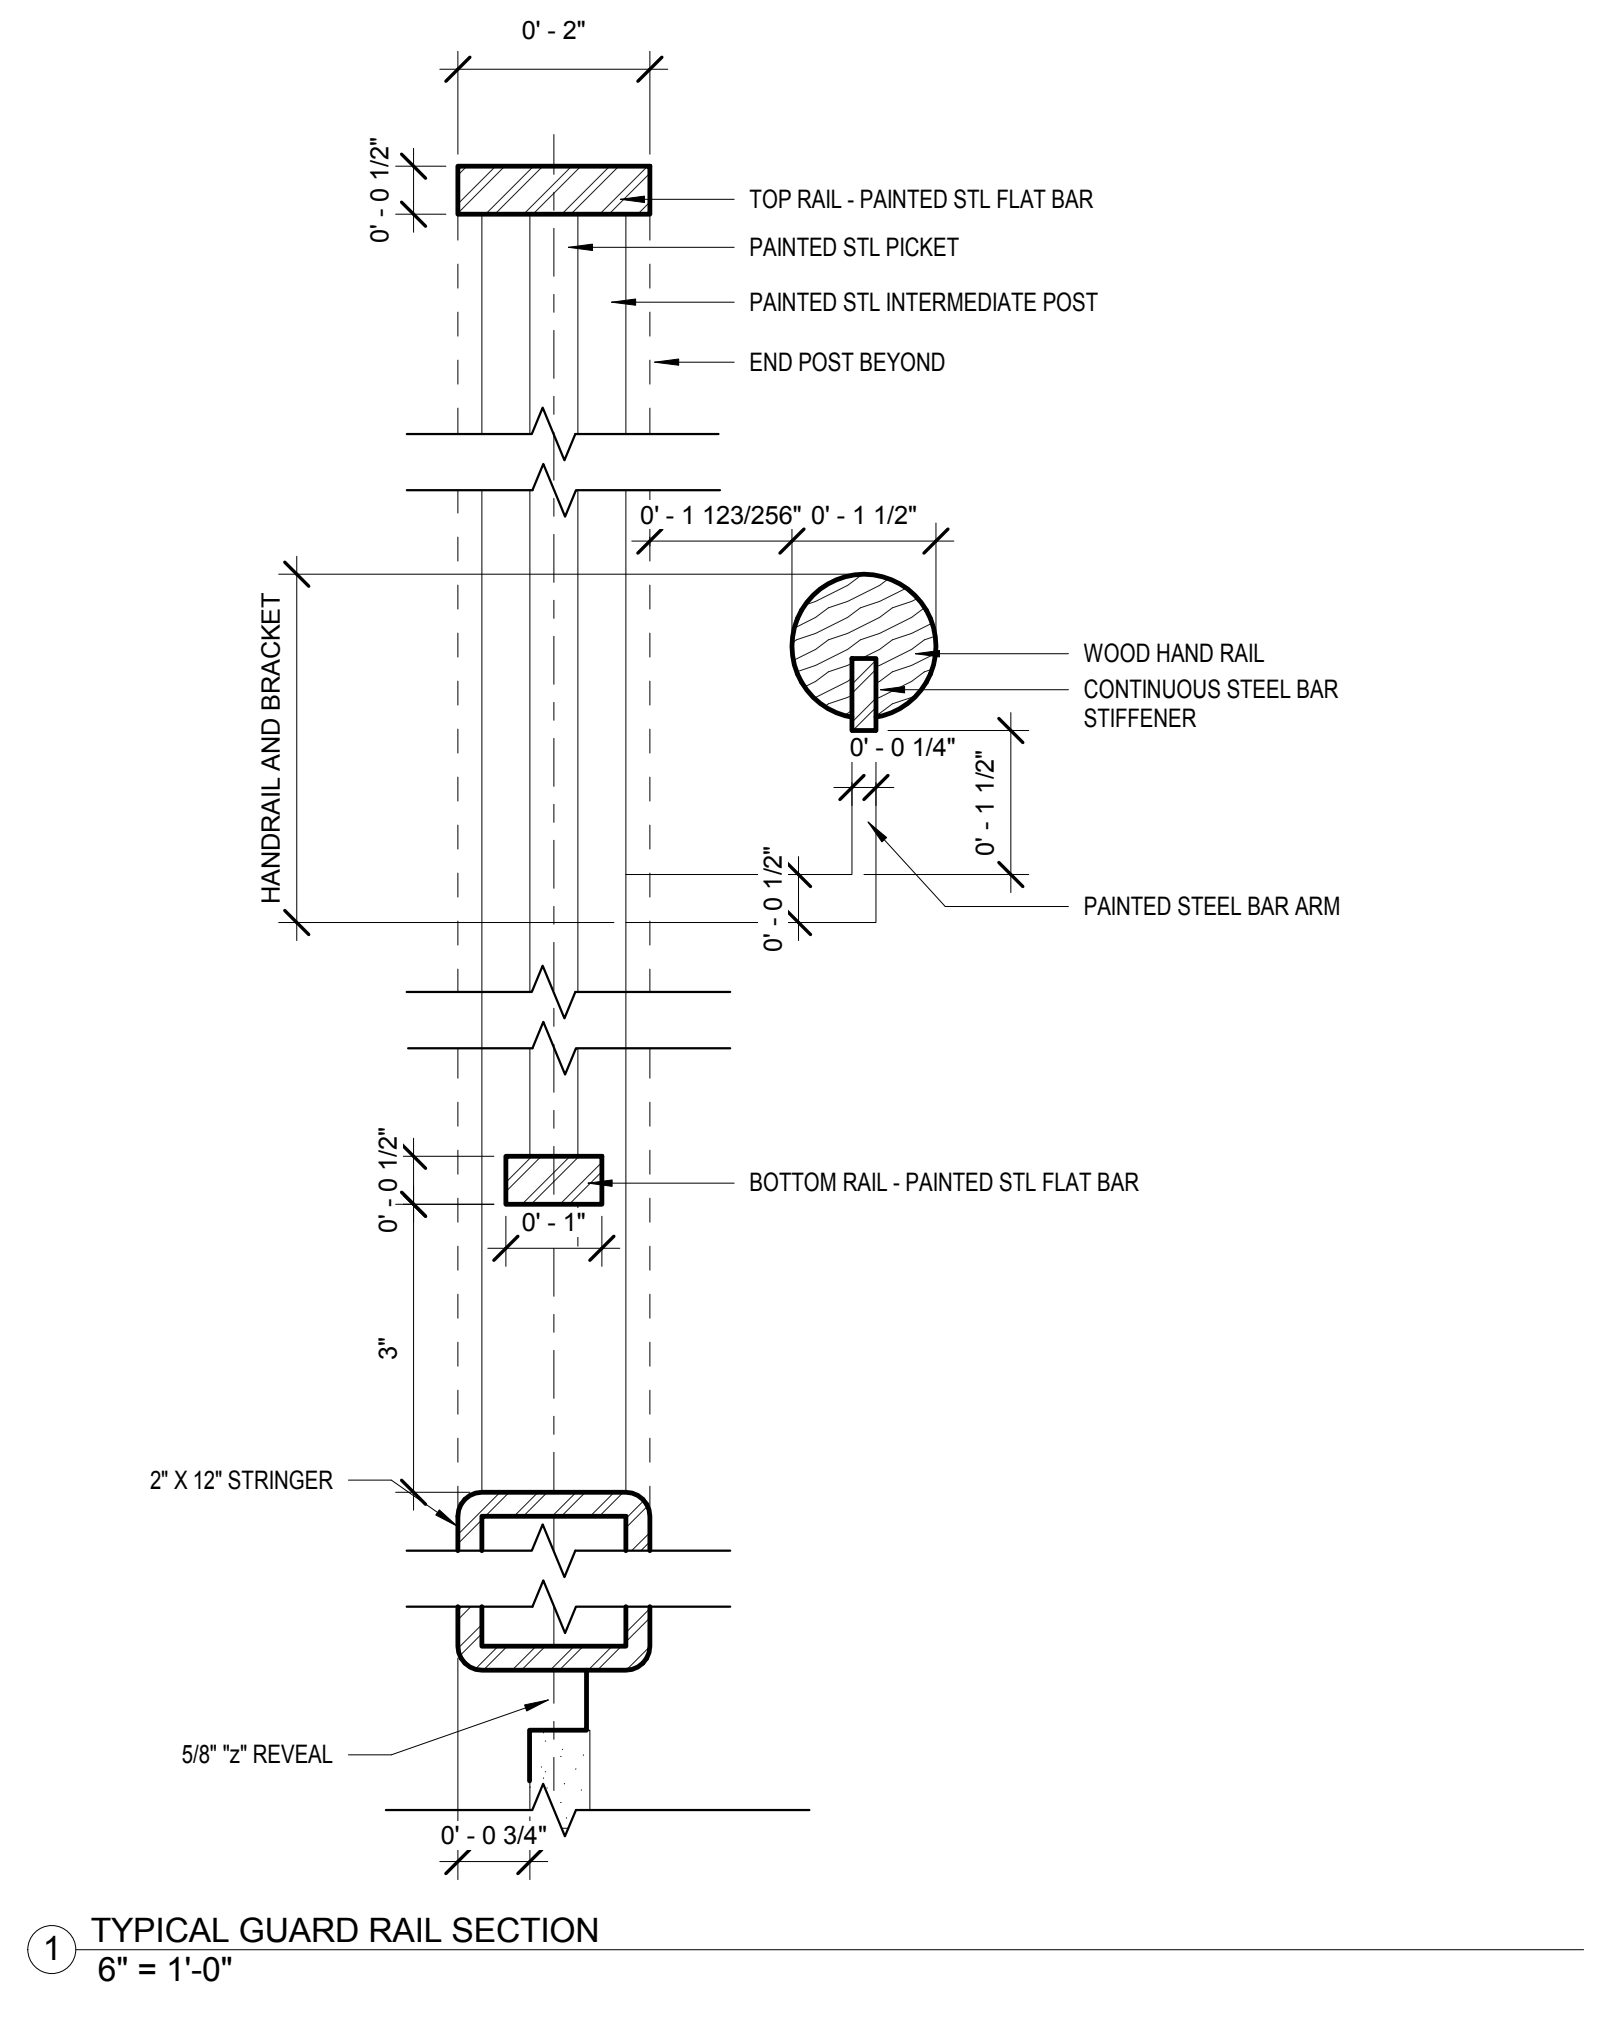
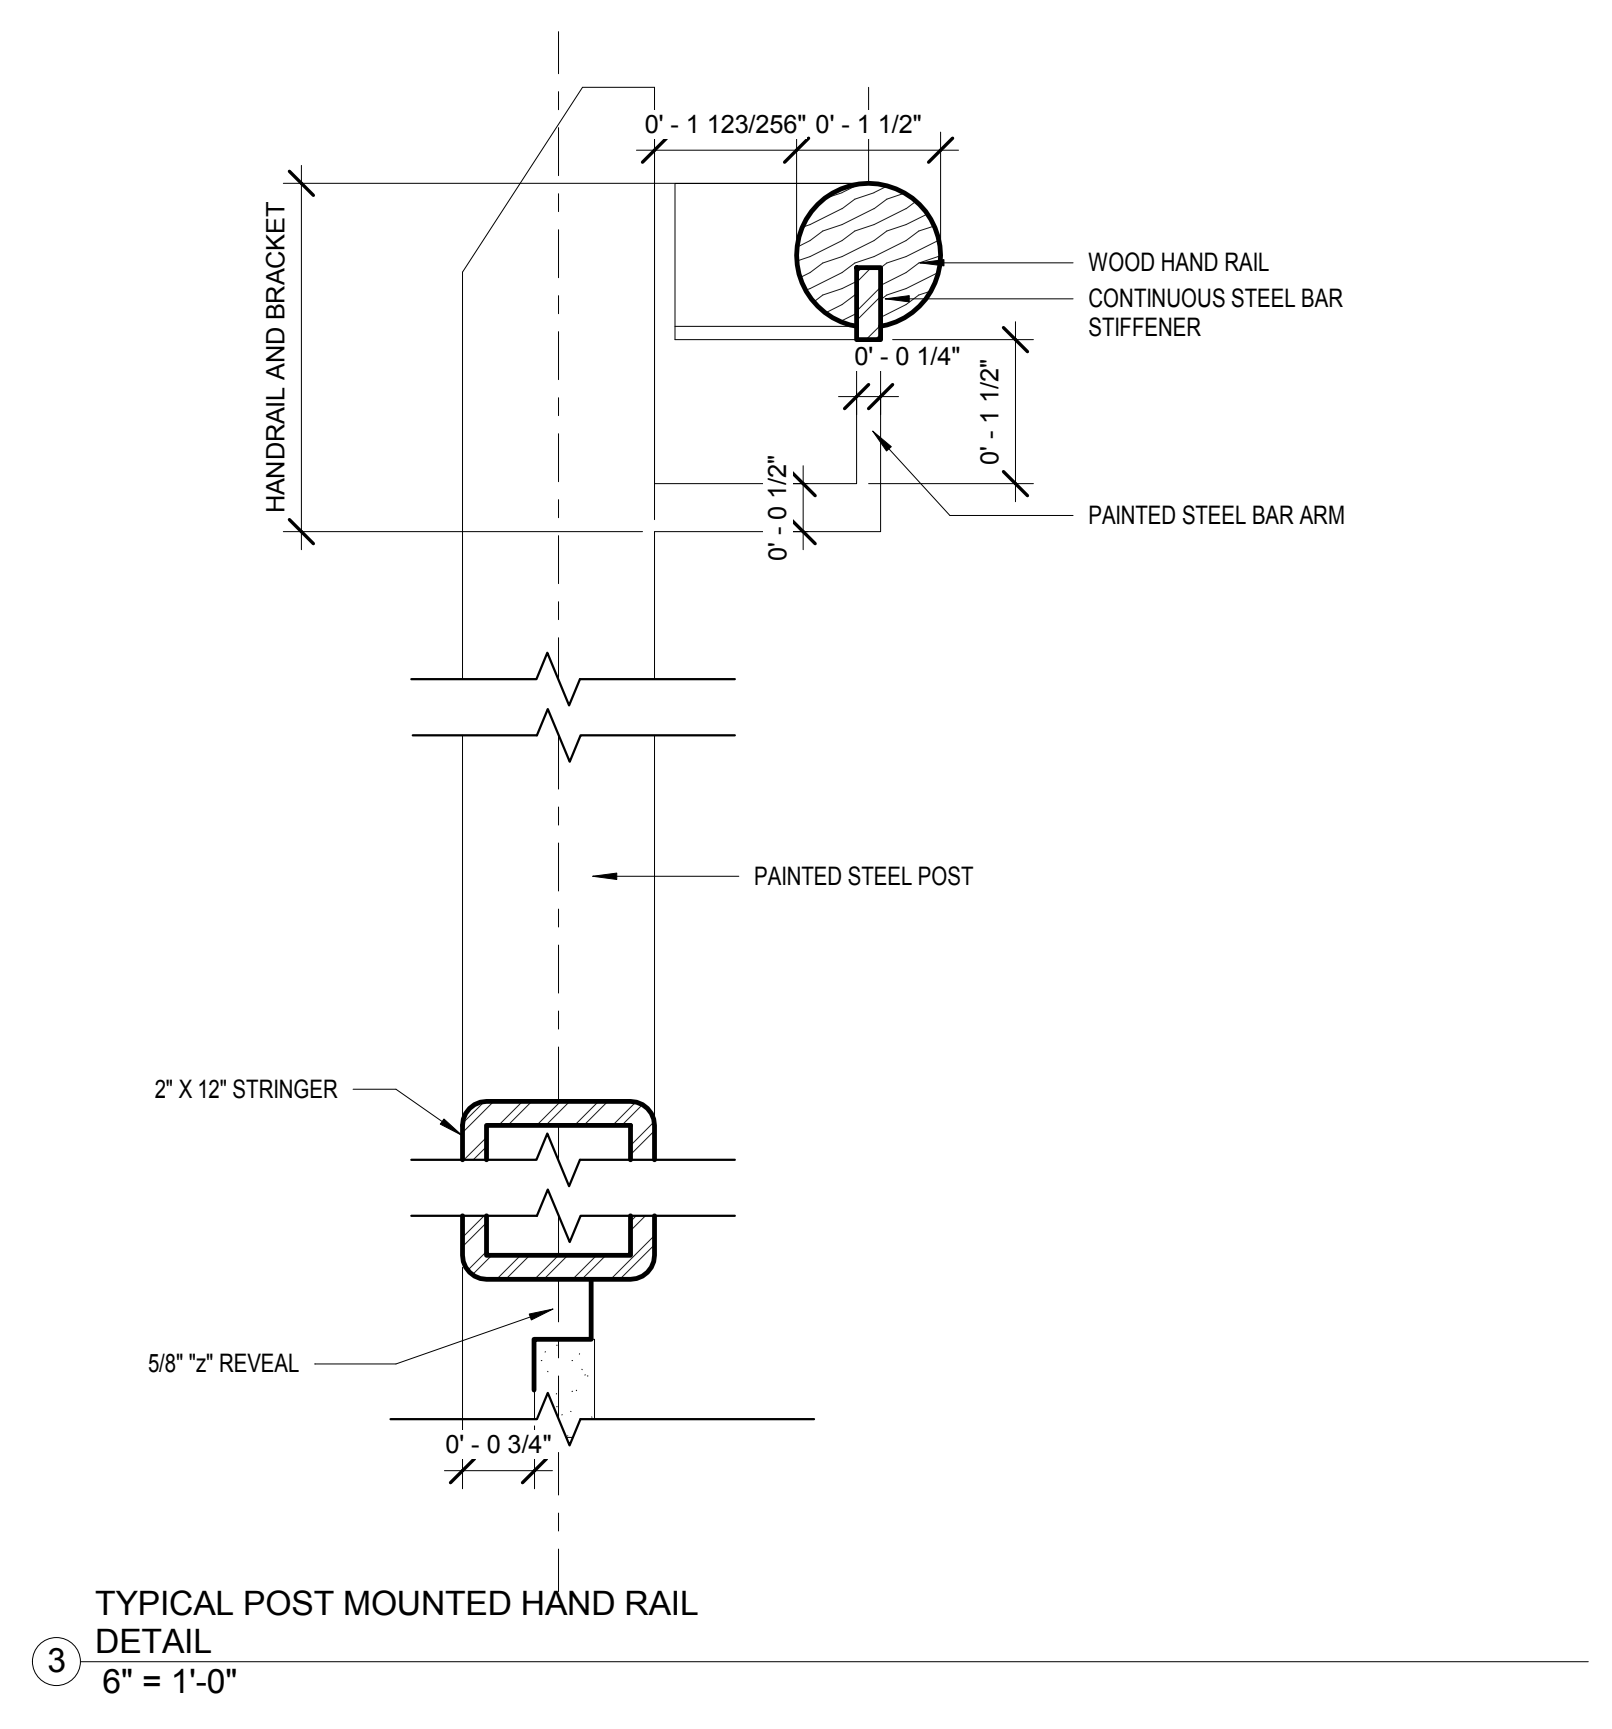
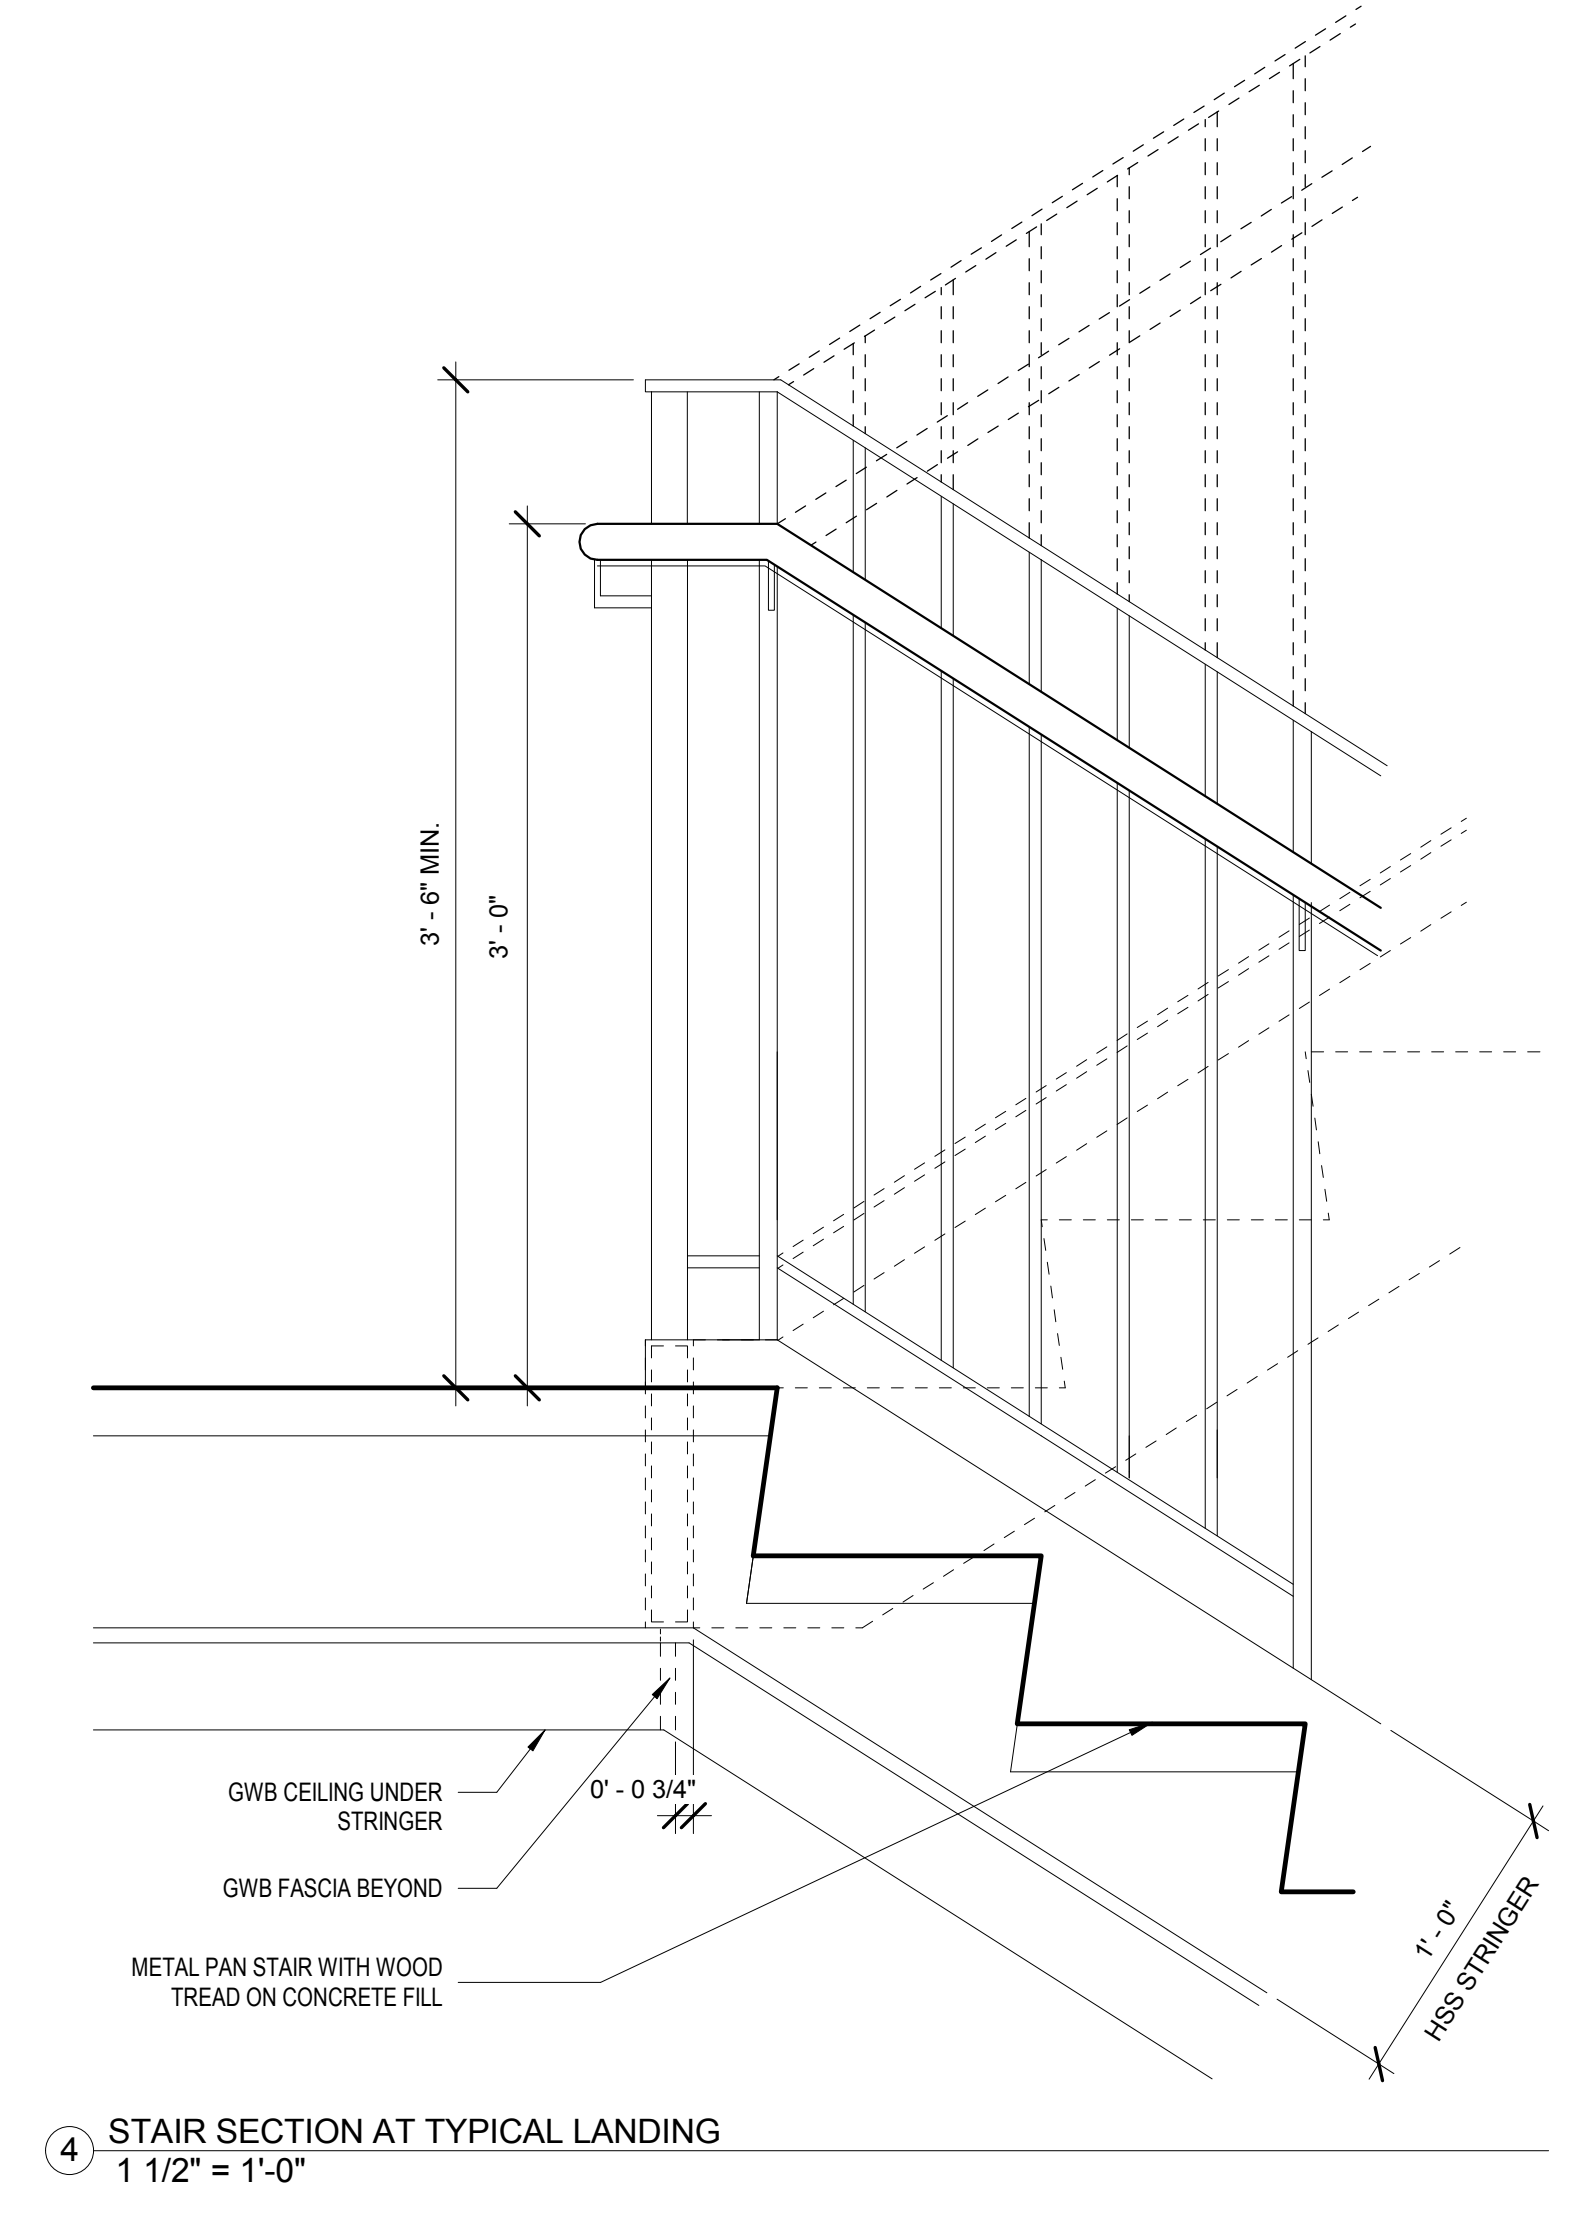
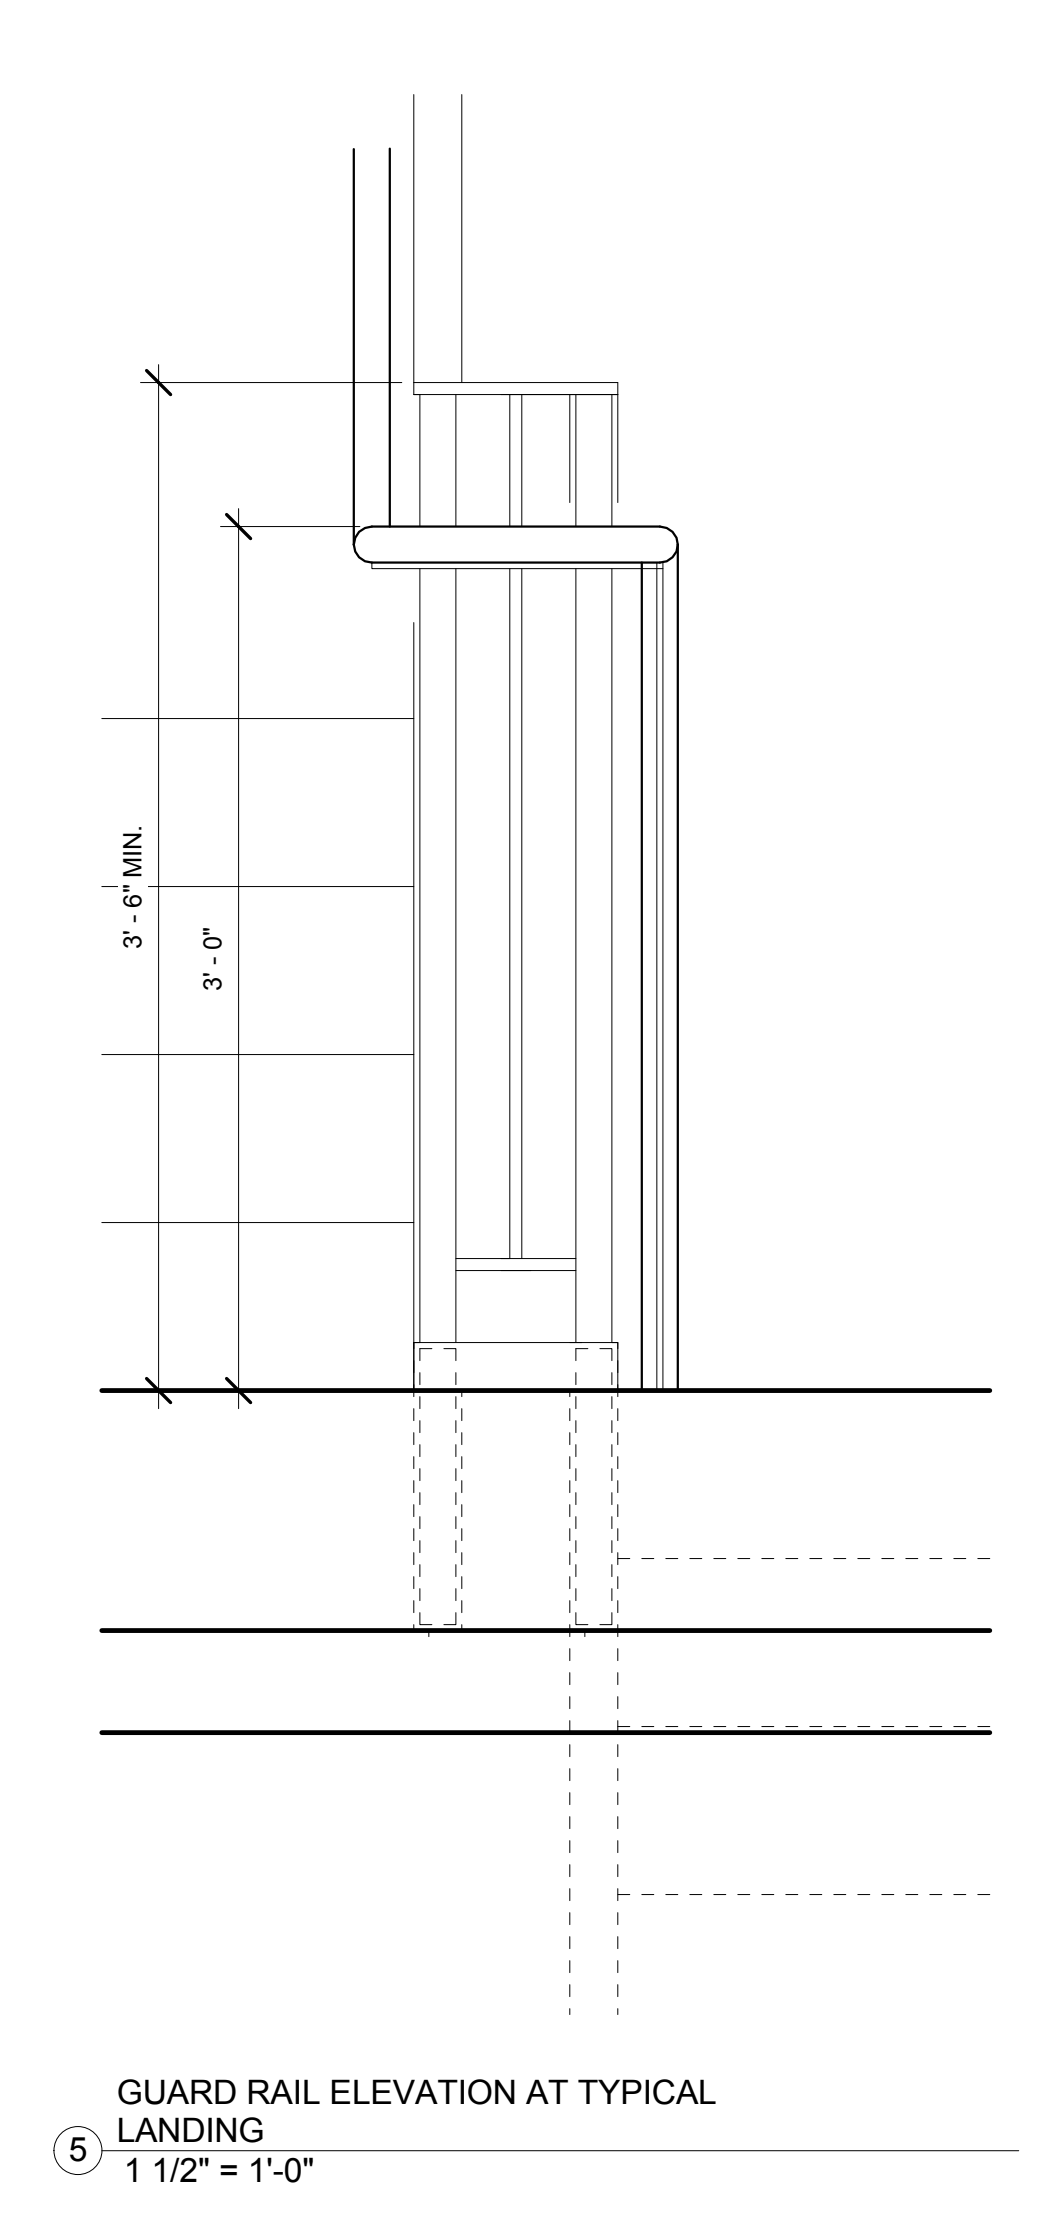
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STAIR & ELEVATOR DETAILS

DRAWING NUMBER
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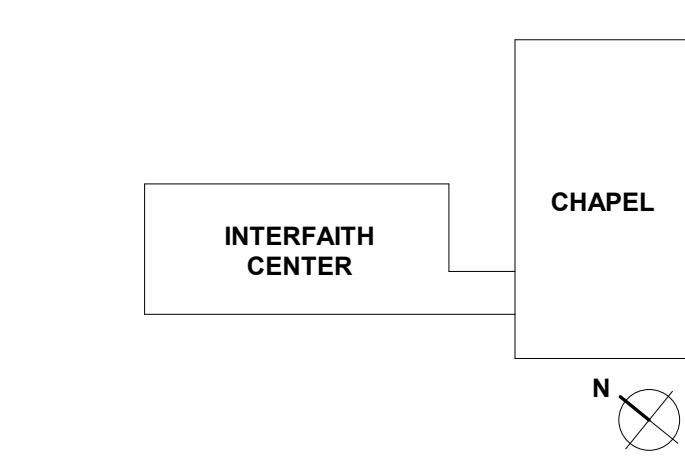


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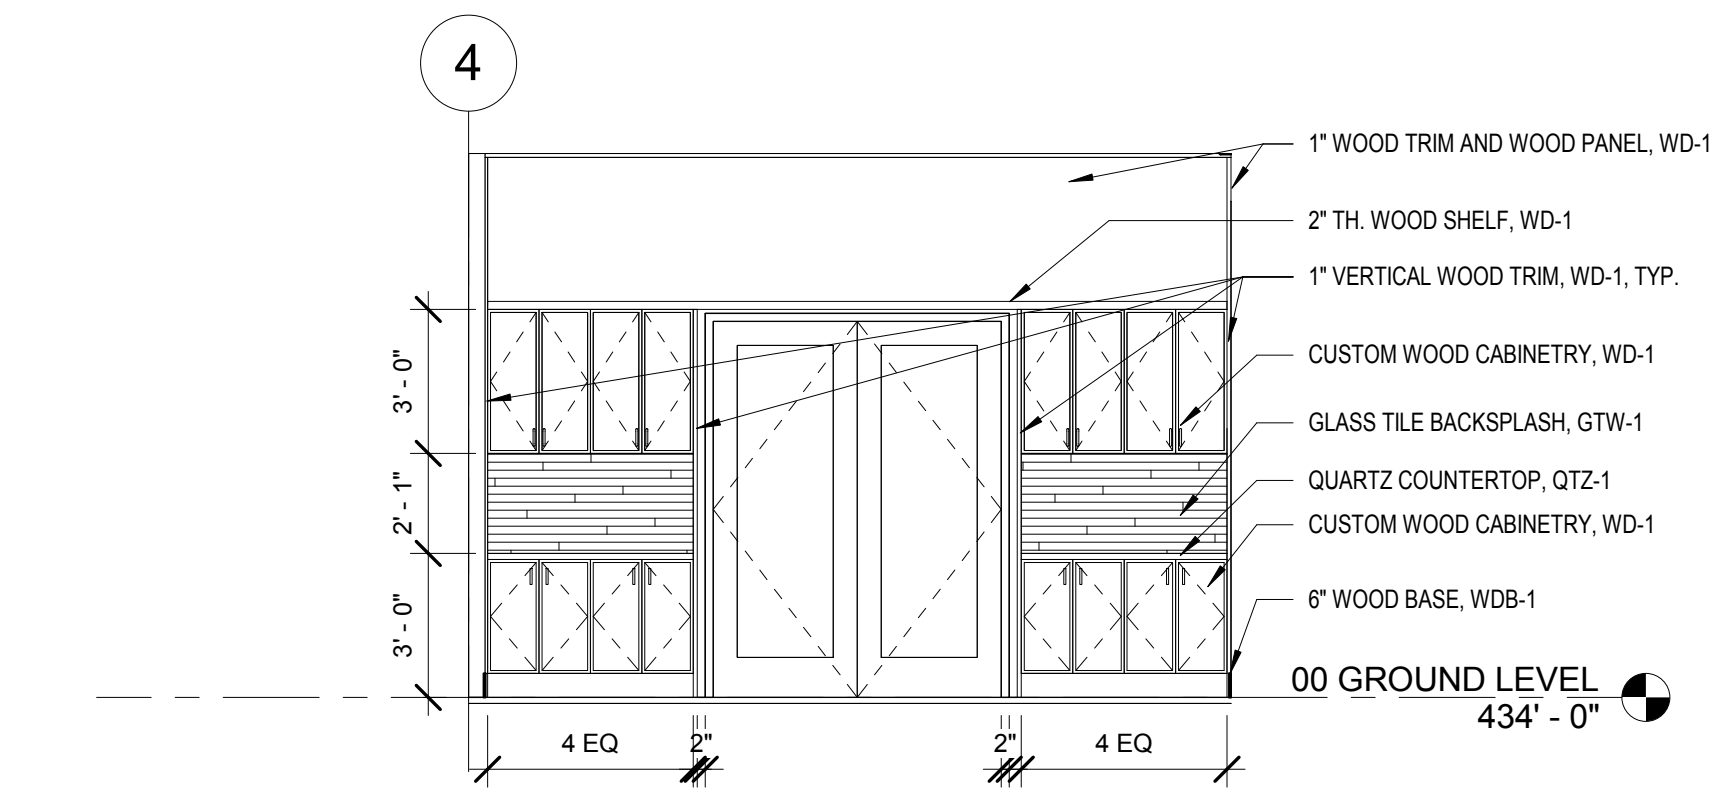
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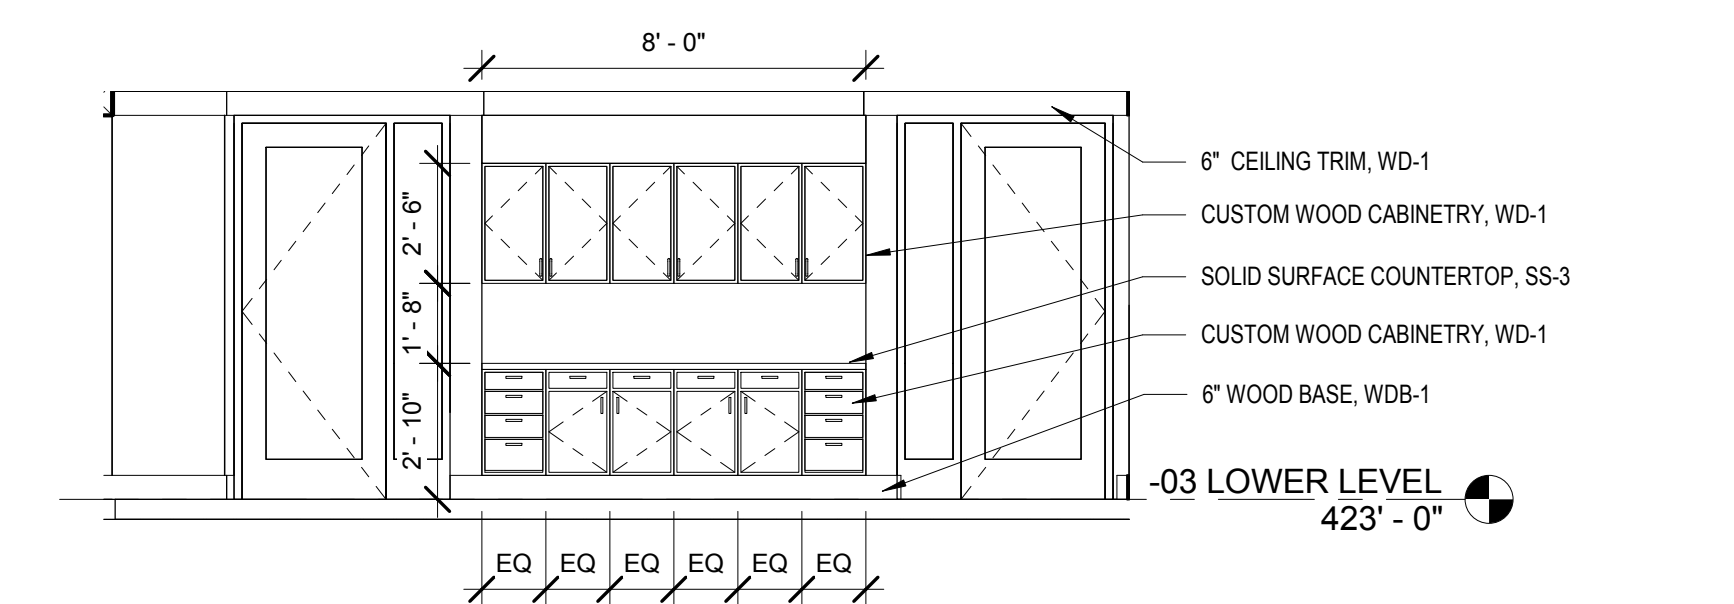
INTERIOR ELEVATIONS

DRAWING NUMBER

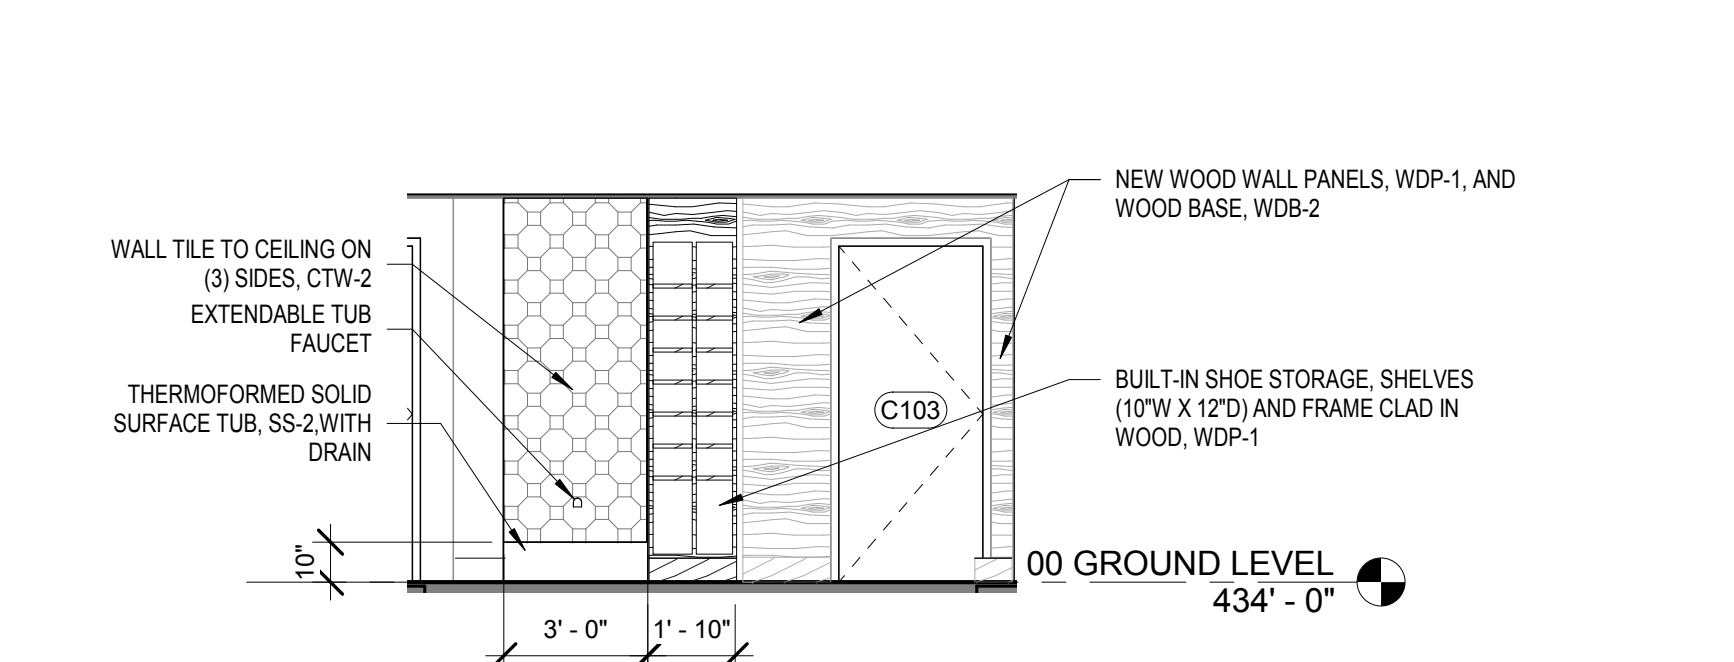
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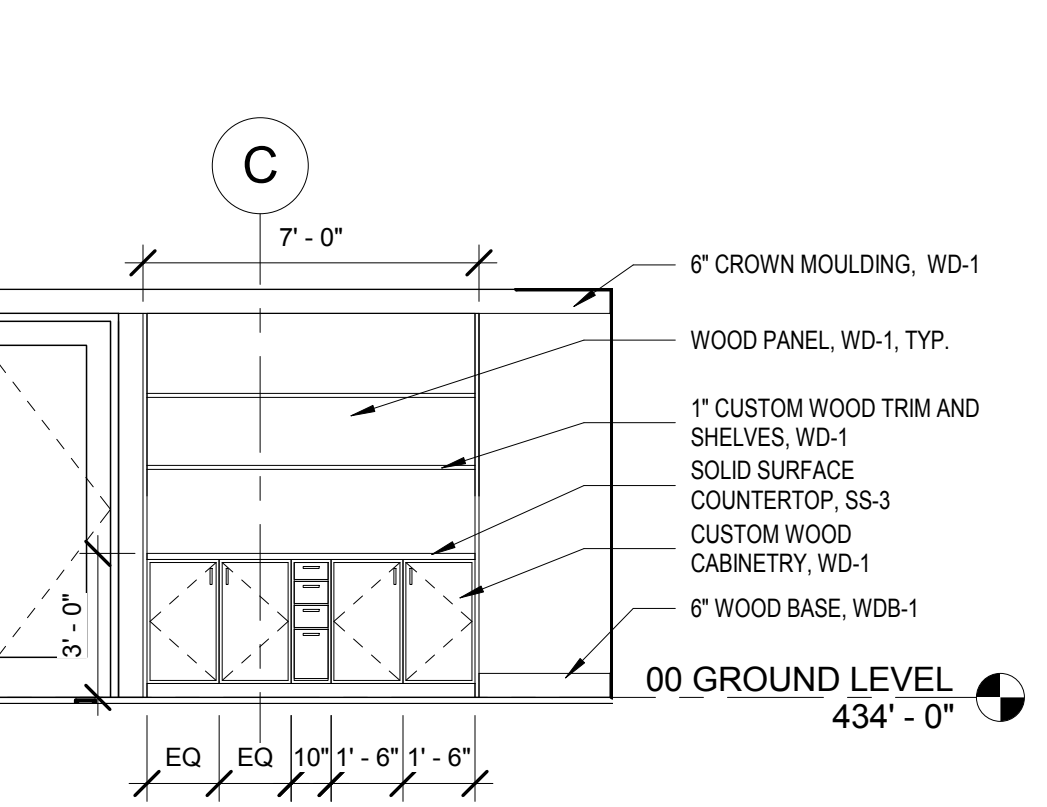
9H ELEVATION - DINING 104 SOUTH
1/4" = 1'-0"




9F ELEVATION - WORK ROOM 001 NORTH
1/4" = 1'-0"




9E ELEVATION - ABLUTION C102 SOUTH
1/4" = 1'-0"



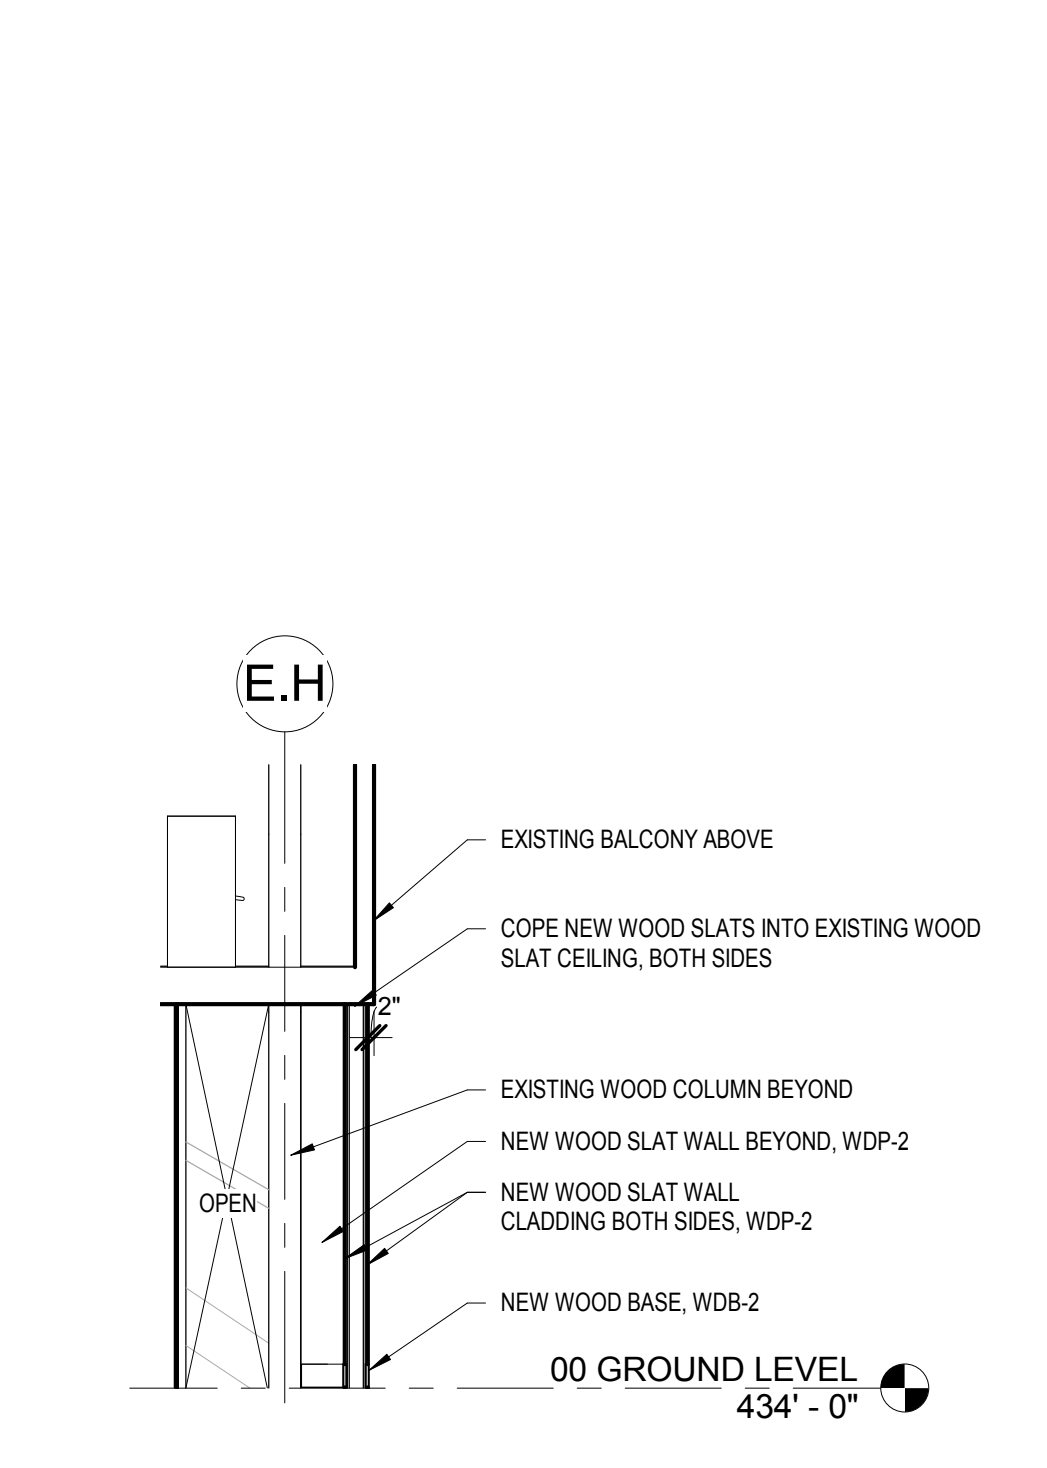
6H ELEVATION - HILLEL 107 EAST
1/4" = 1'-0"



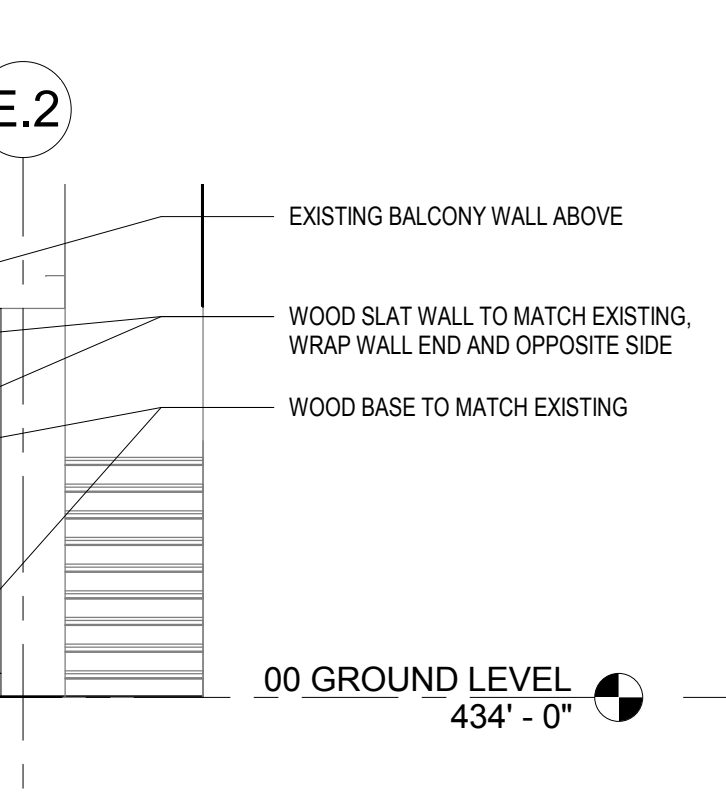
7E SECTION - NARTHEX WALL WEST
1/4" = 1'-0"



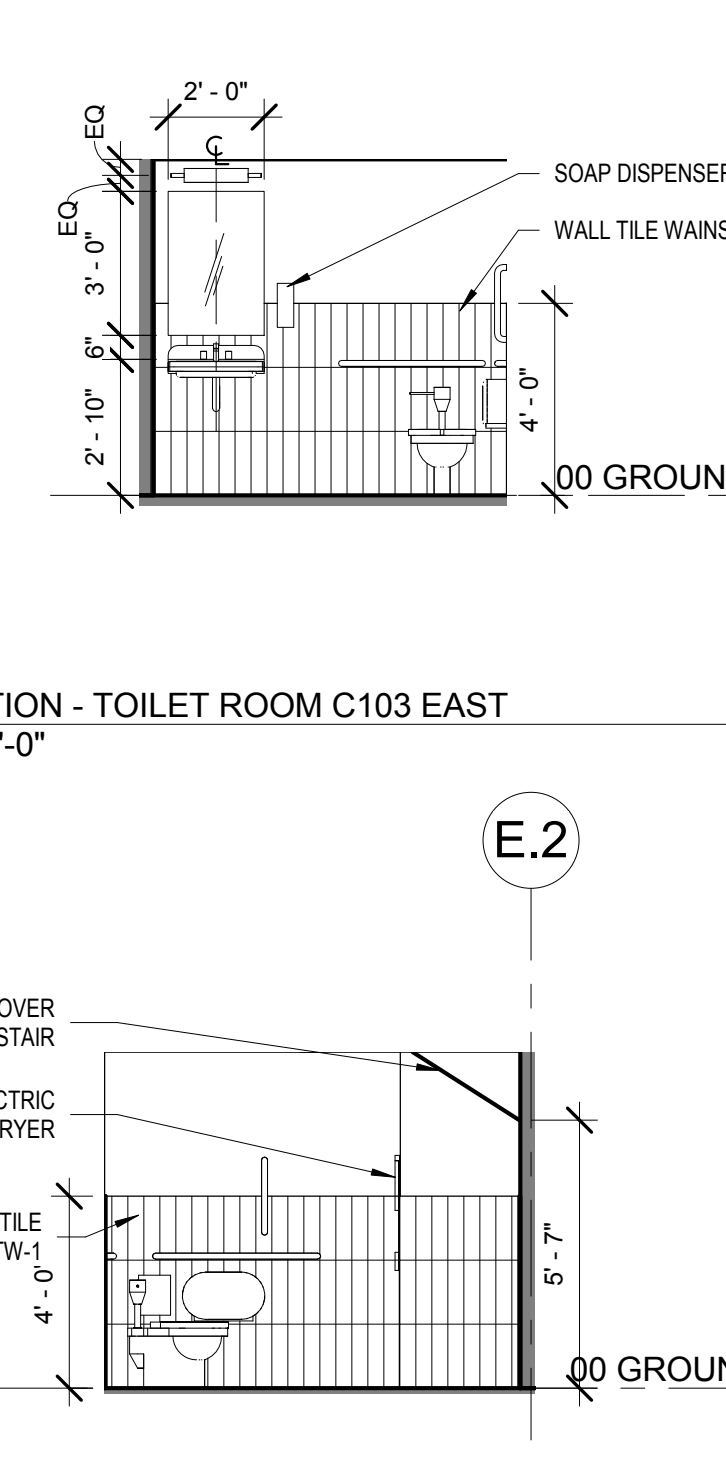
4G ELEVATION - TOILET ROOM C103 EAST
1/4" = 1'-0"



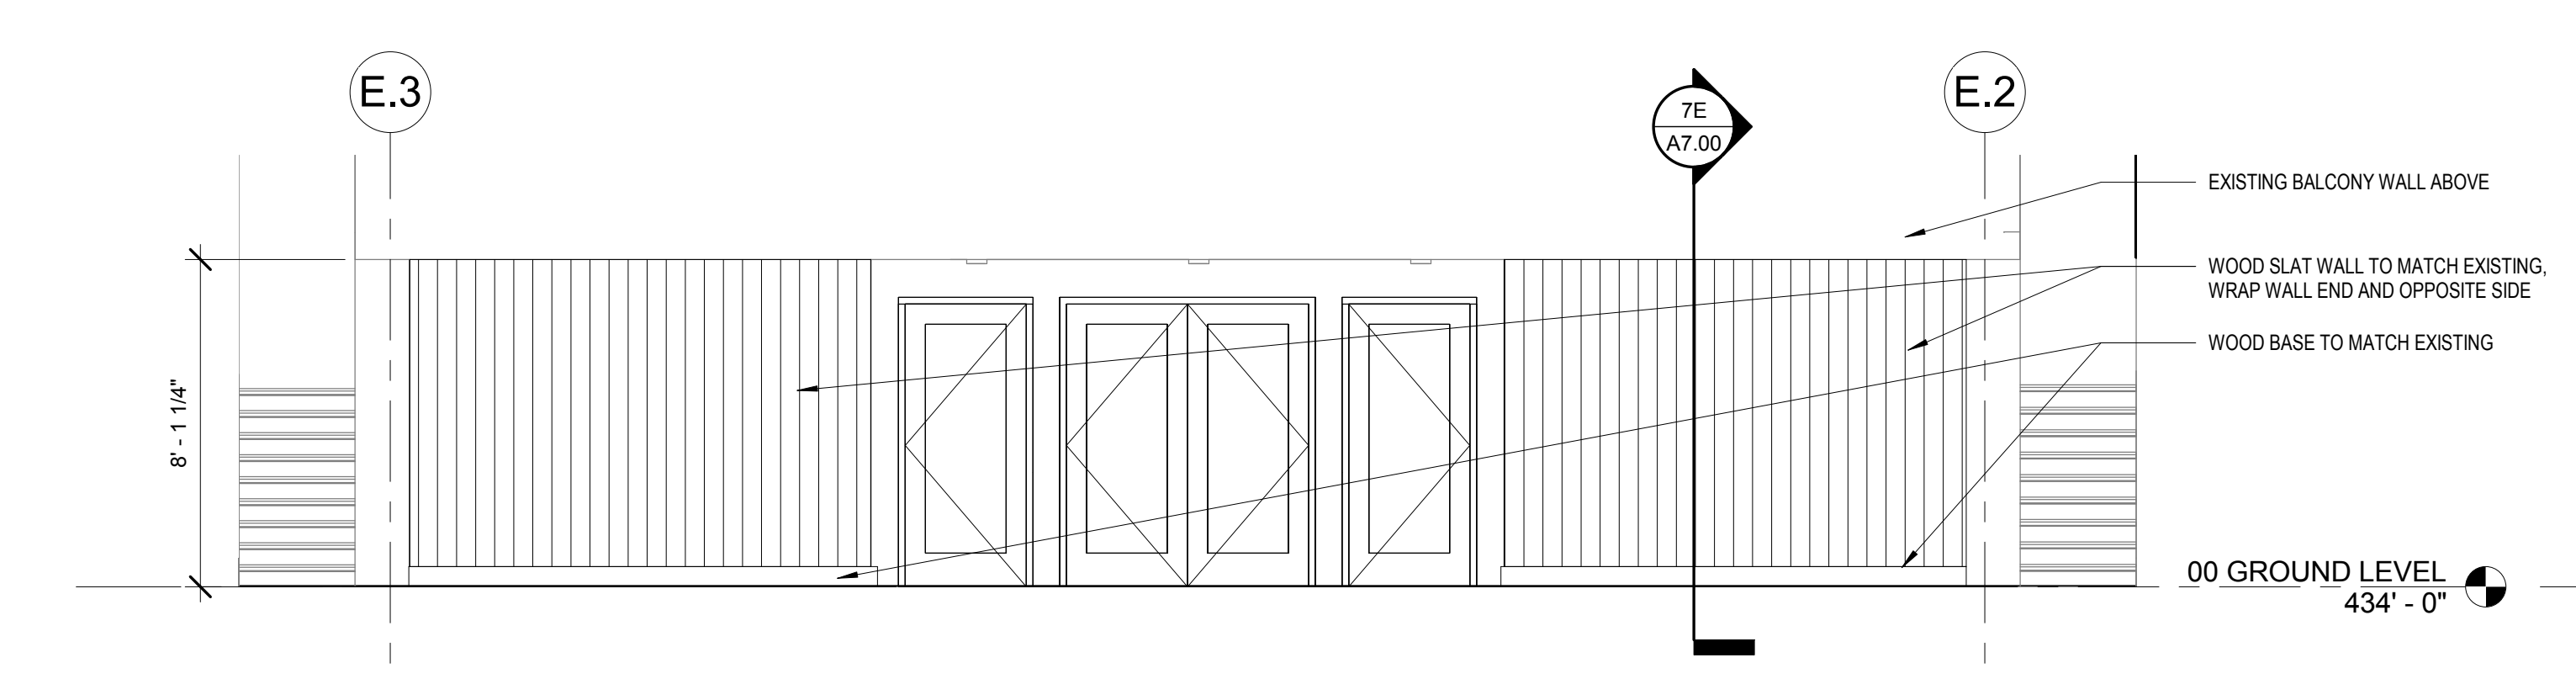
4E ELEVATION - TOILET ROOM C103 SOUTH
1/4" = 1'-0"



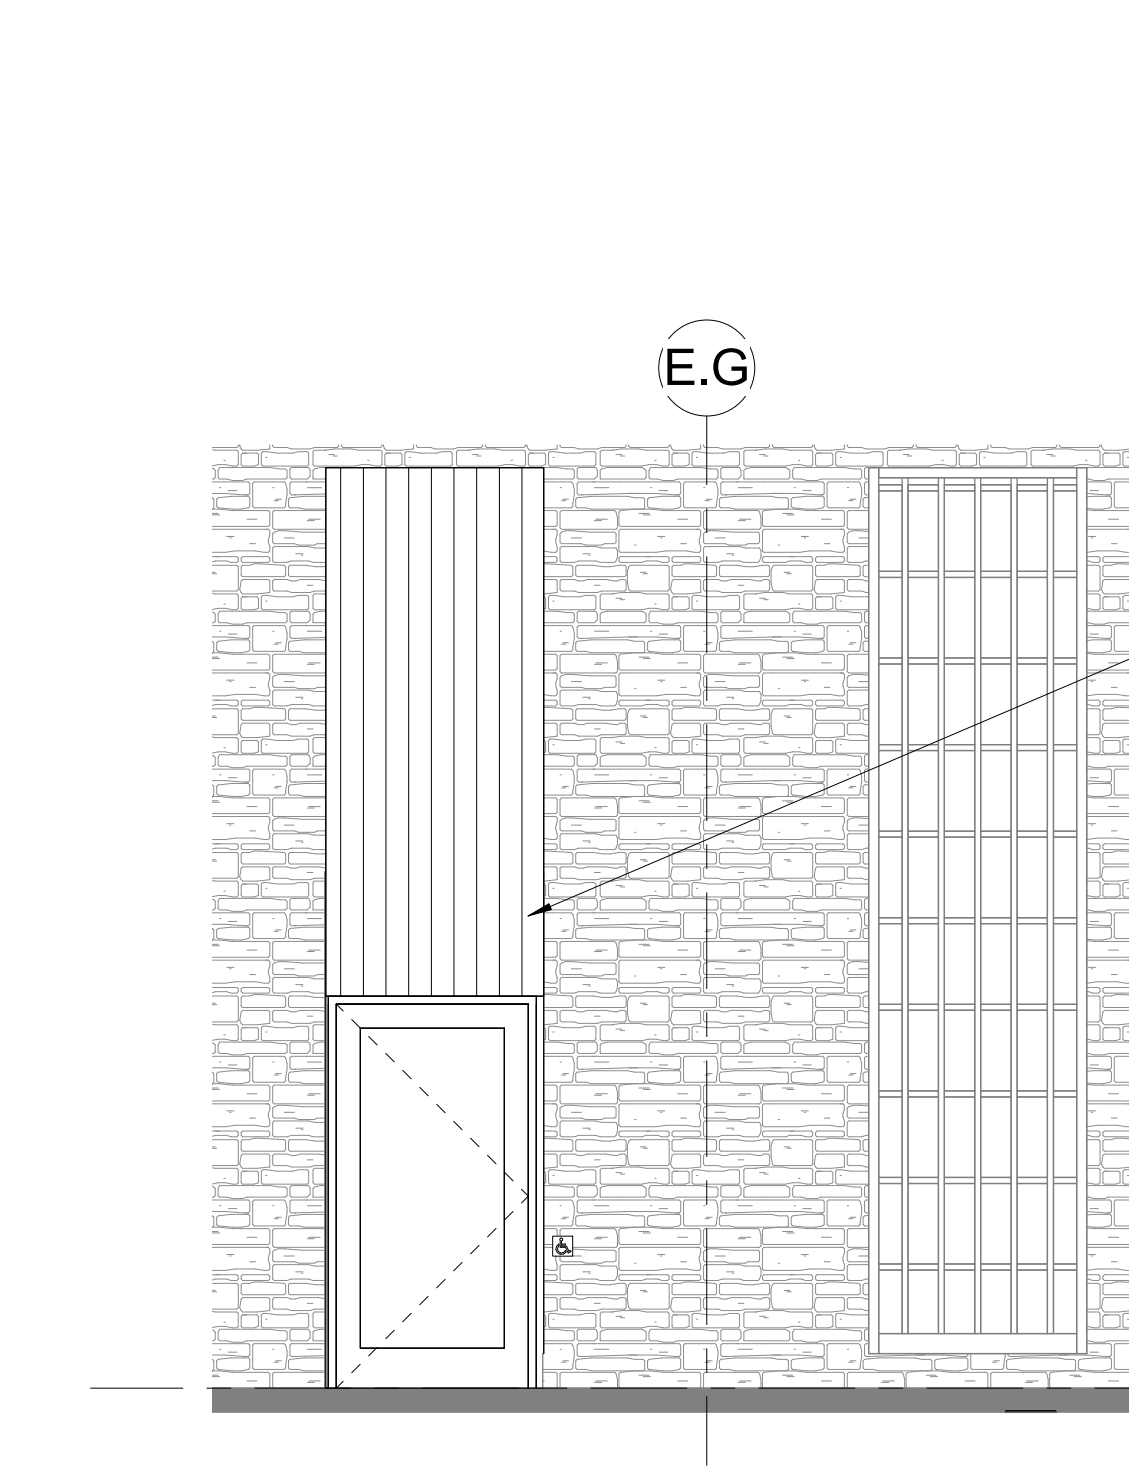
1H ELEVATION - NARTHEX PARTITION SOUTH
1/4" = 1'-0"



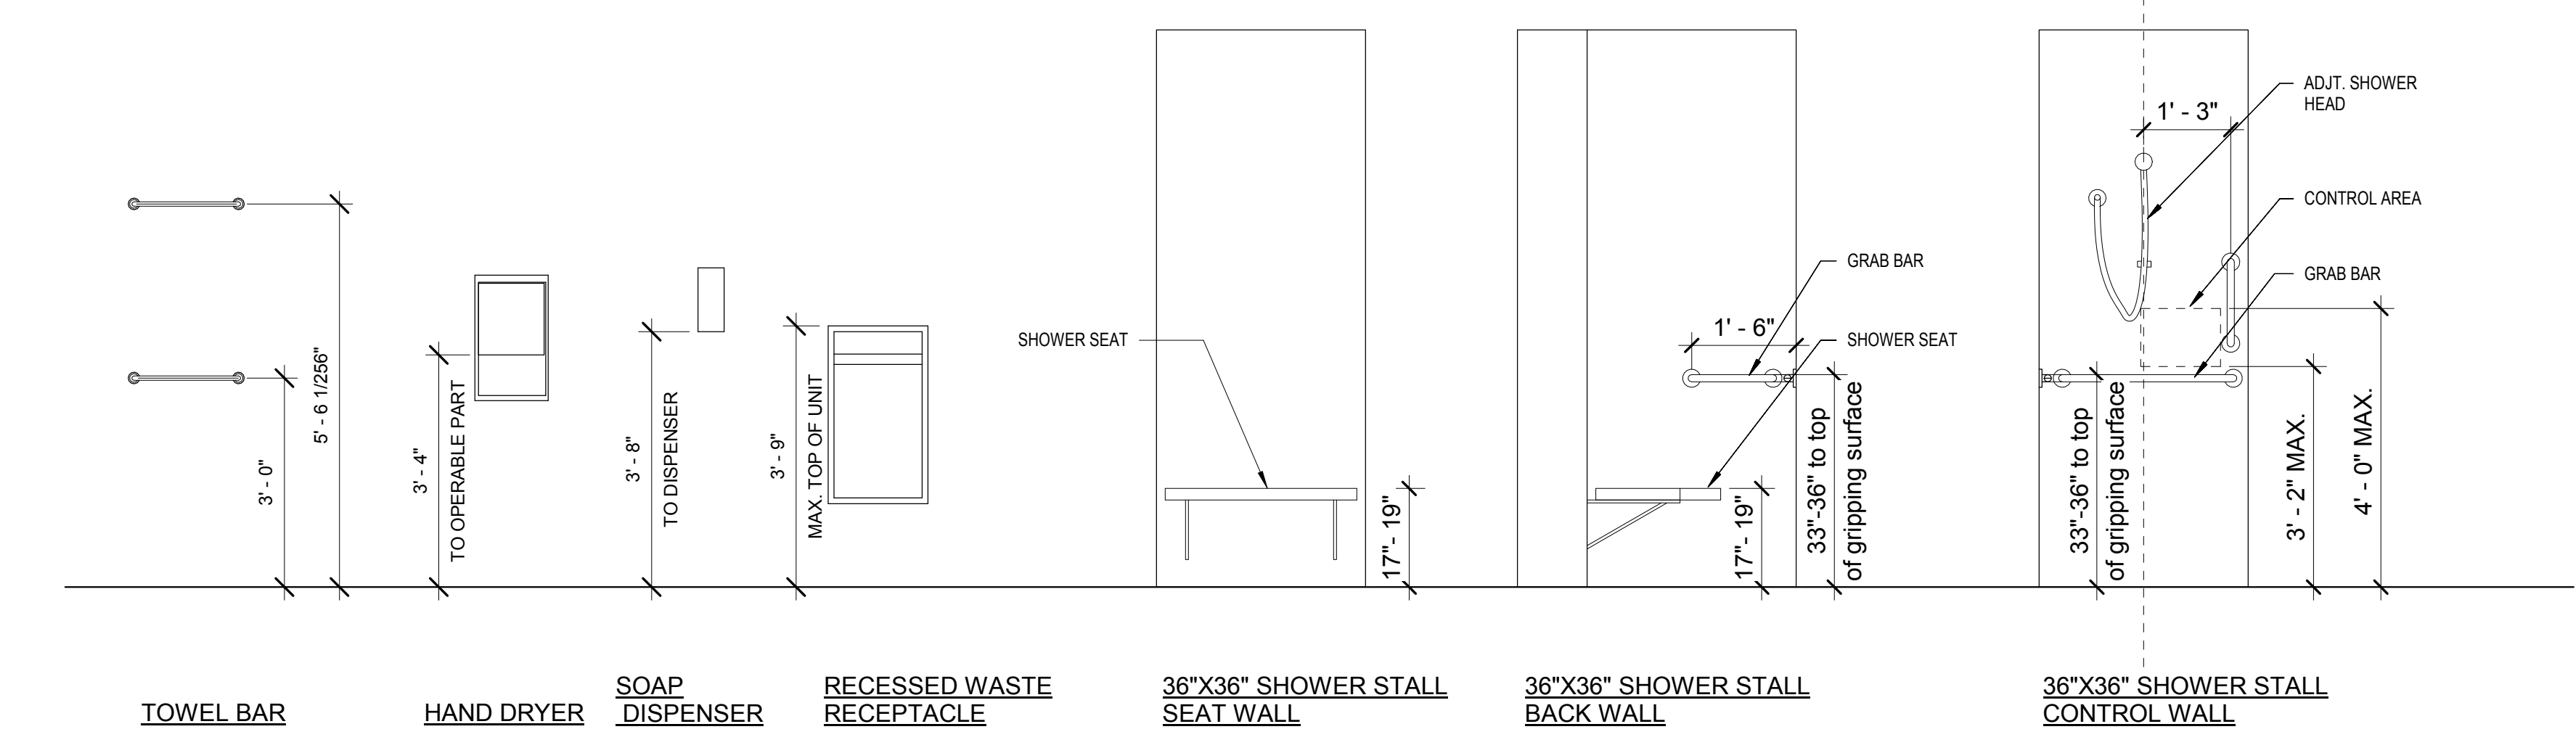
1E ELEVATION - IN-FILL PARTITION
1/4" = 1'-0"



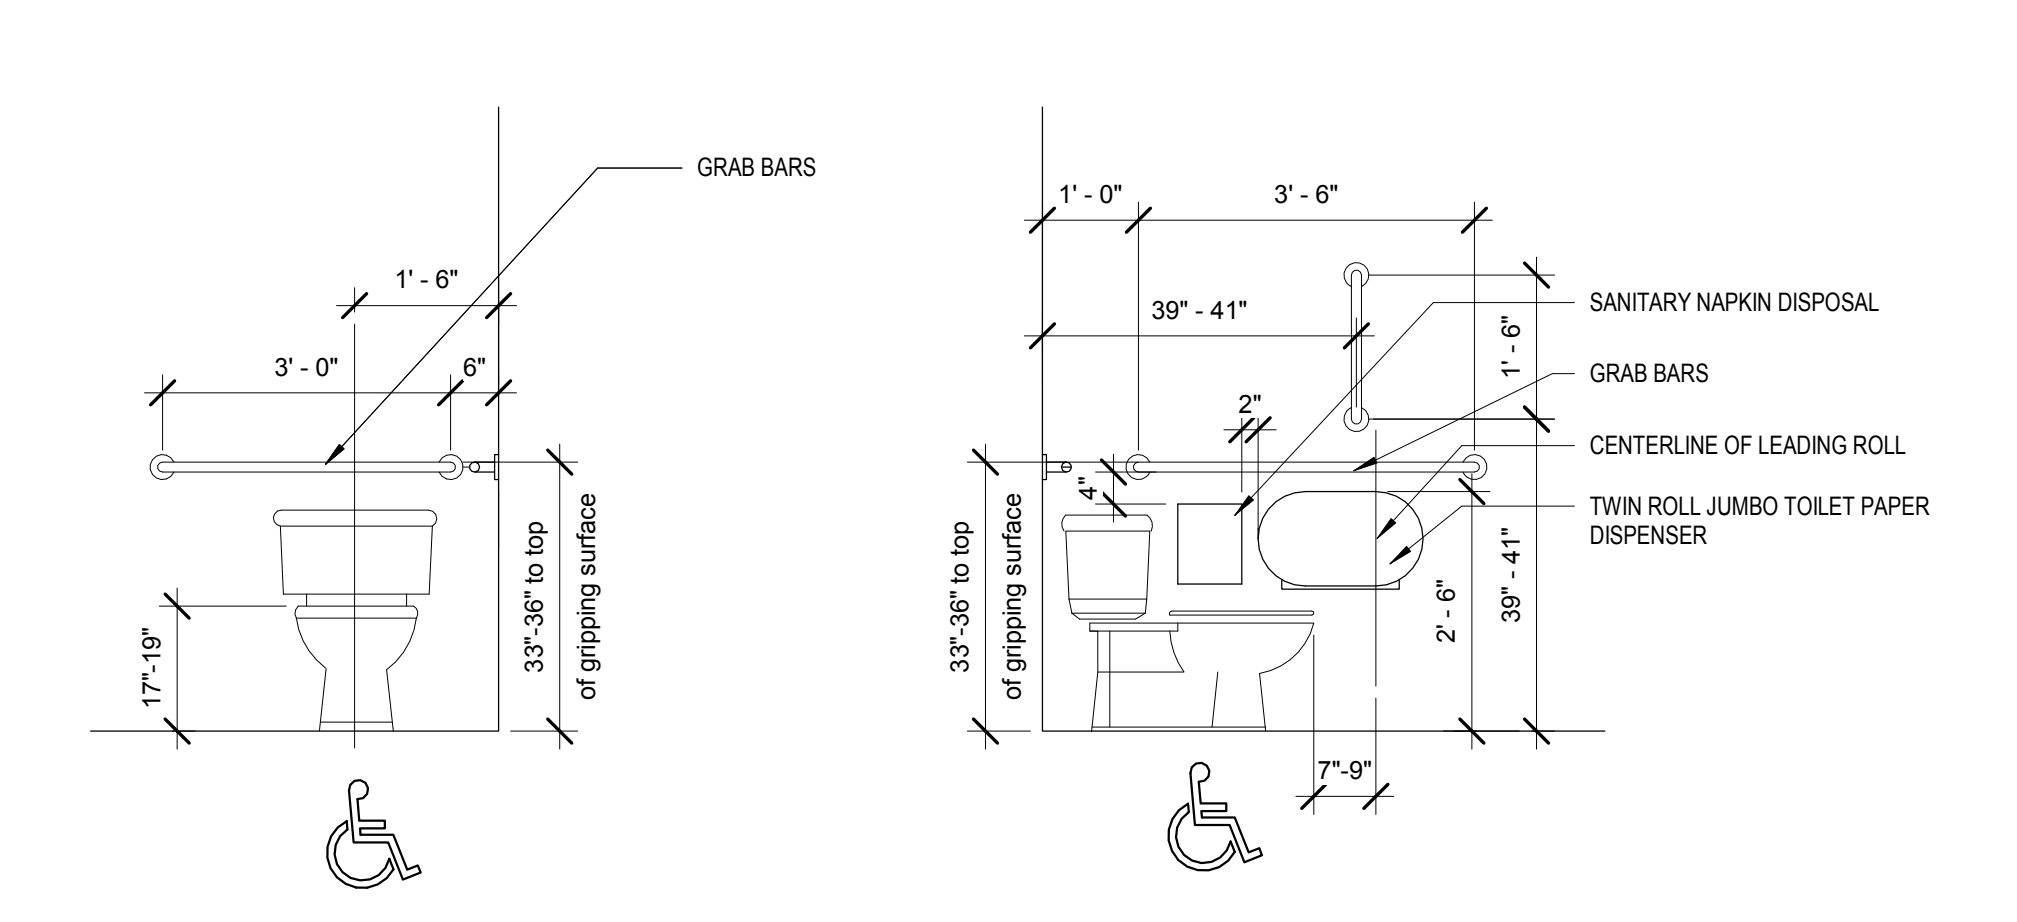
1C MISC. MOUNTING HEIGHTS- BATHROOMS
1/2" = 1'-0"



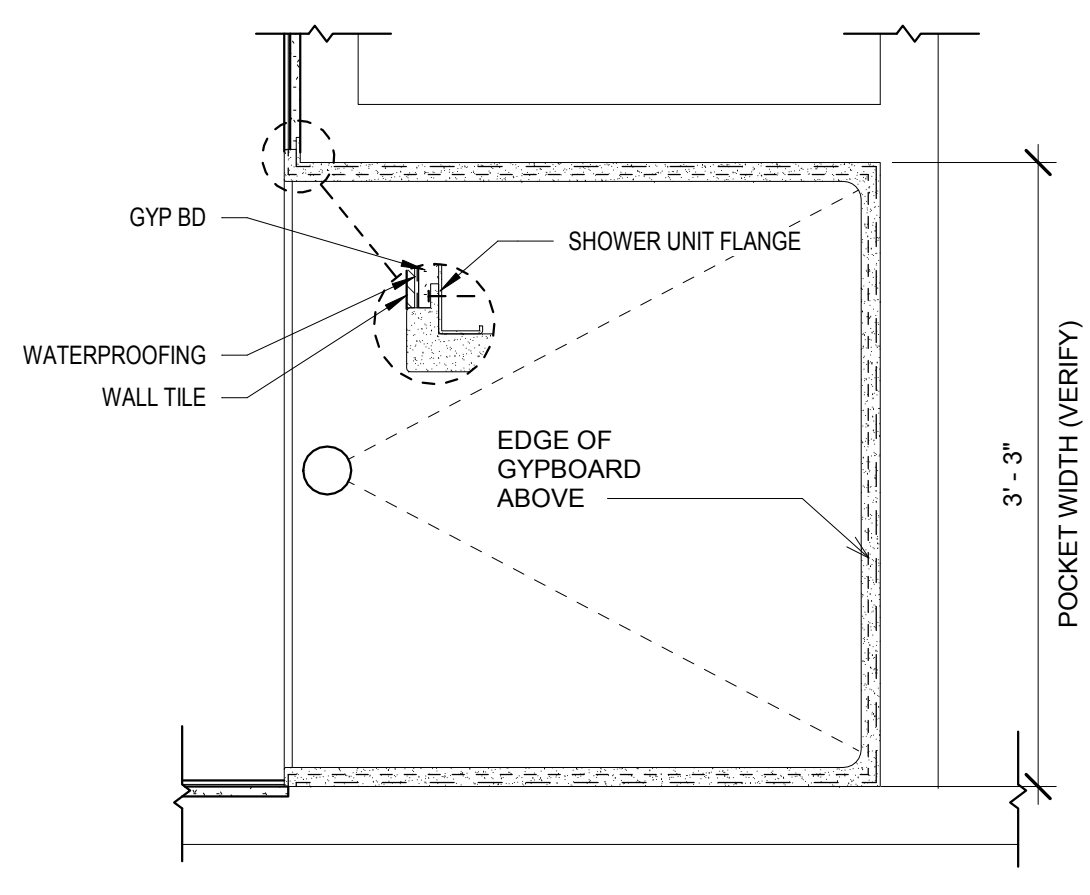
1A ACCESSIBLE W.C. MOUNTING HEIGHTS
1/2" = 1'-0"



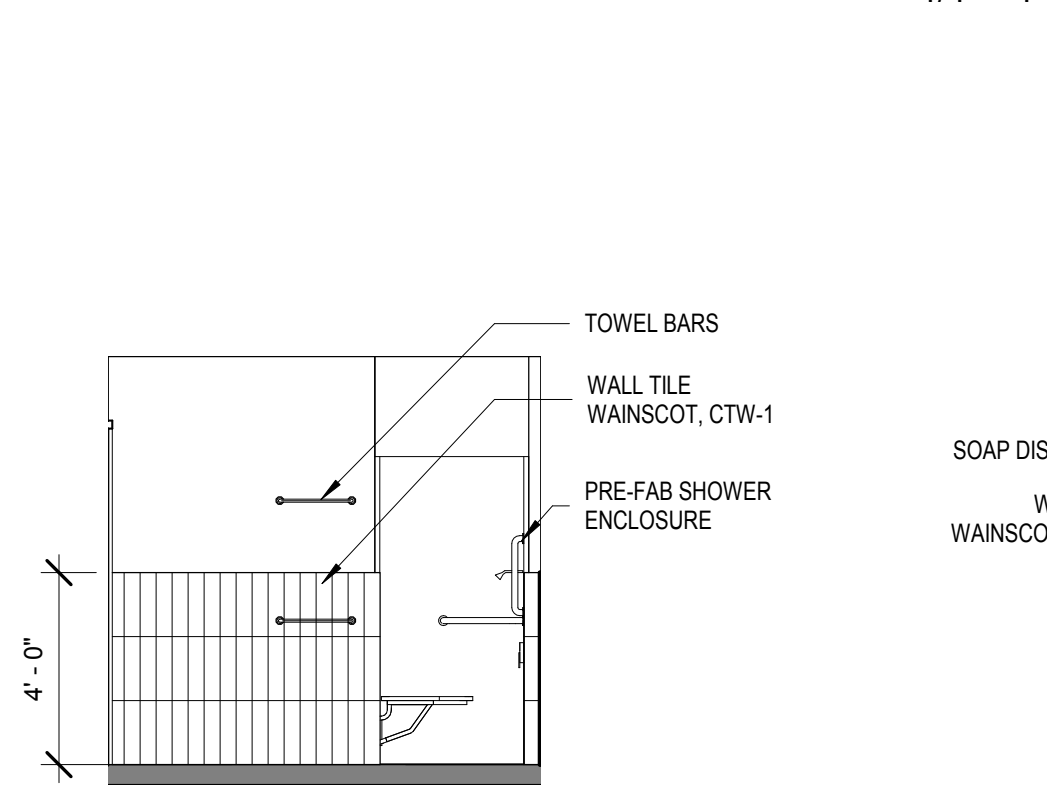
4A ENLARGED PLAN - TRANSFER SHOWER
1" = 1'-0"



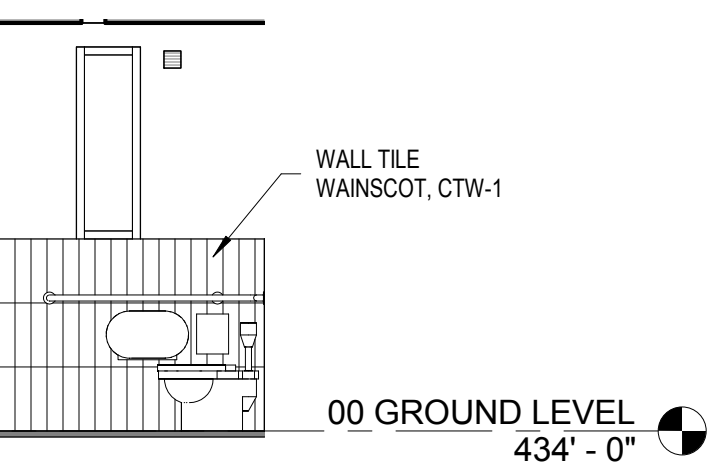
7A ELEVATION - TOILET ROOM 006 EAST
1/4" = 1'-0"



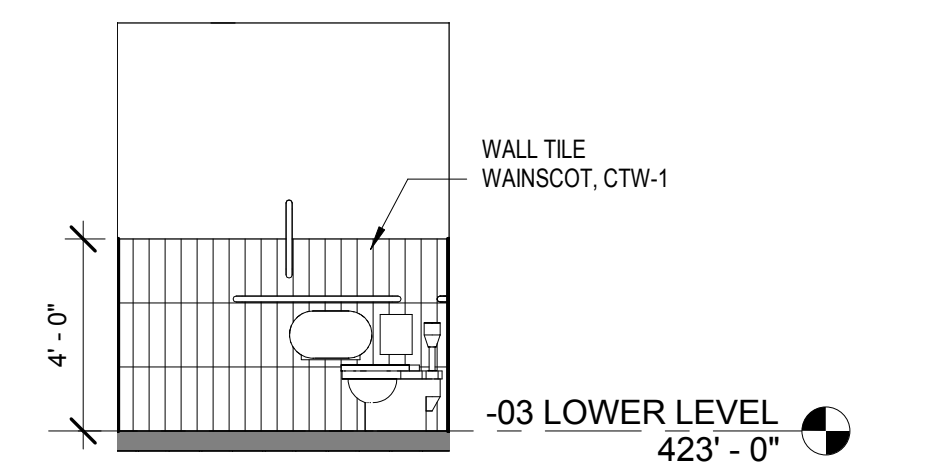
8C ELEVATION - TOILET ROOM 106 SOUTH
1/4" = 1'-0"



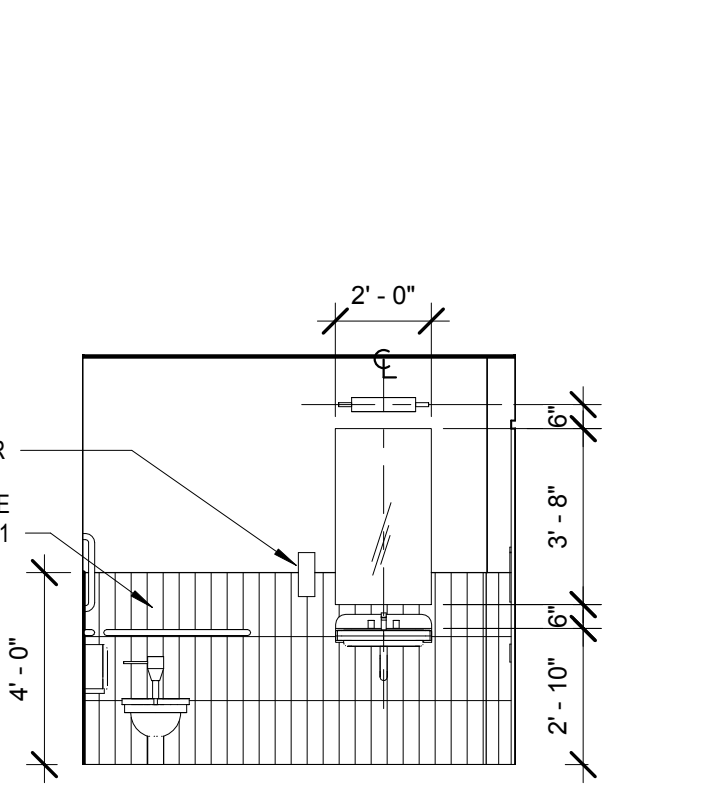10C ELEVATION - TOILET ROOM 006 SOUTH
1/4" = 1'-0"



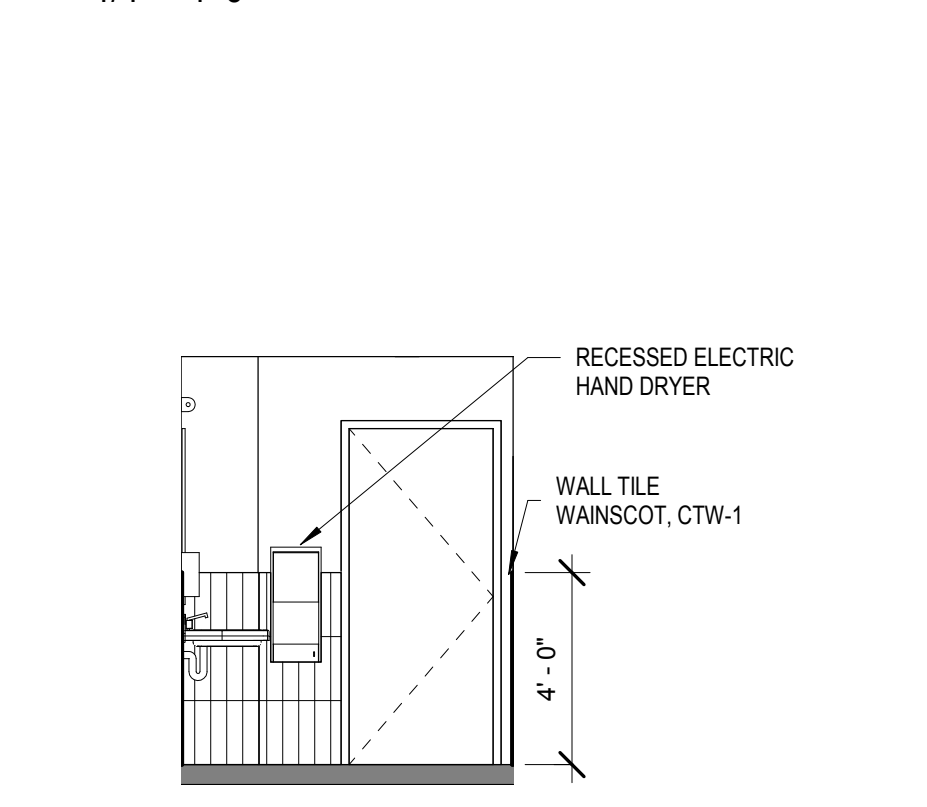
9A ELEVATION - TOILET ROOM WEST
1/4" = 1'-0"



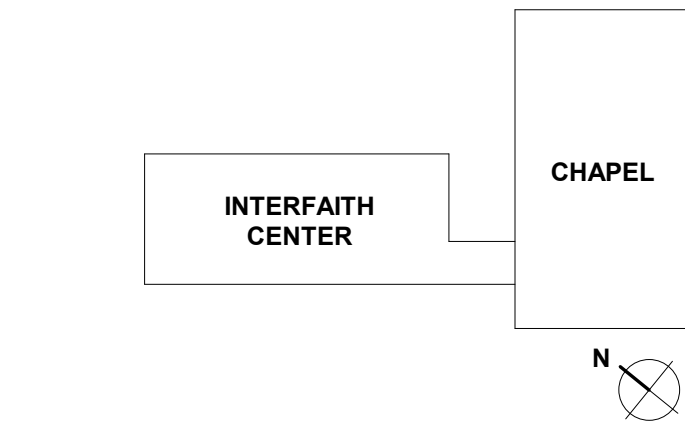10A ELEVATION - TOILET ROOM NORTH
1/4" = 1'-0"

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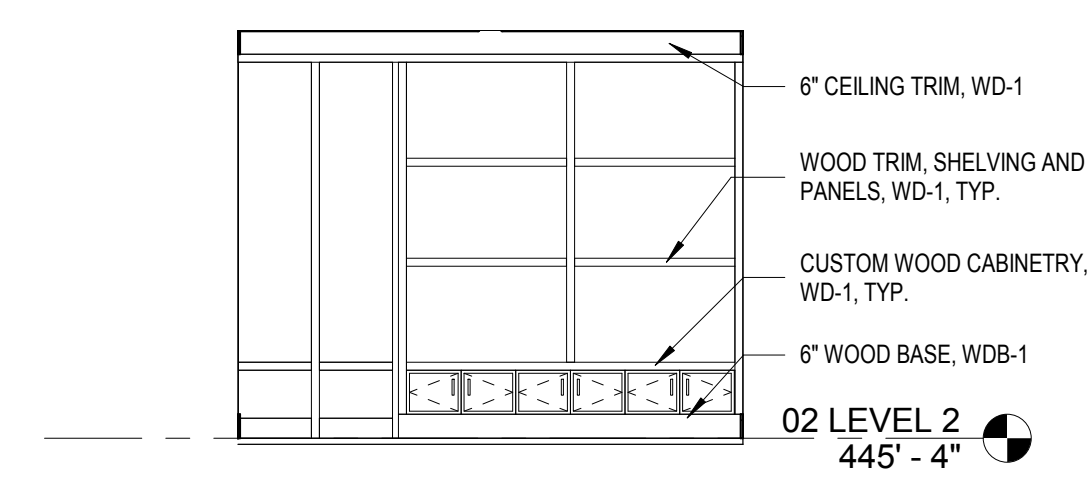
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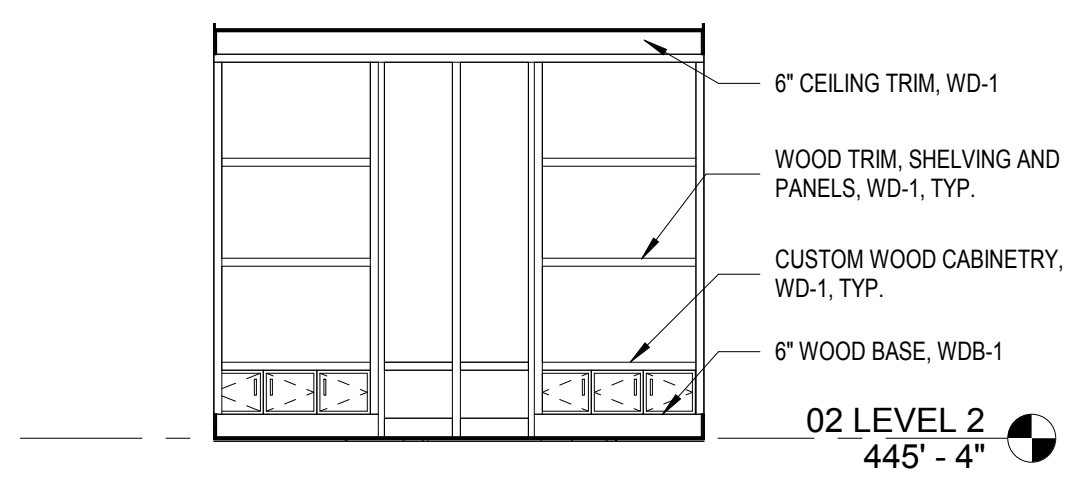
PROJECT DESIGN PHASE
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DRAWING NAME
INTERIOR ELEVATIONS

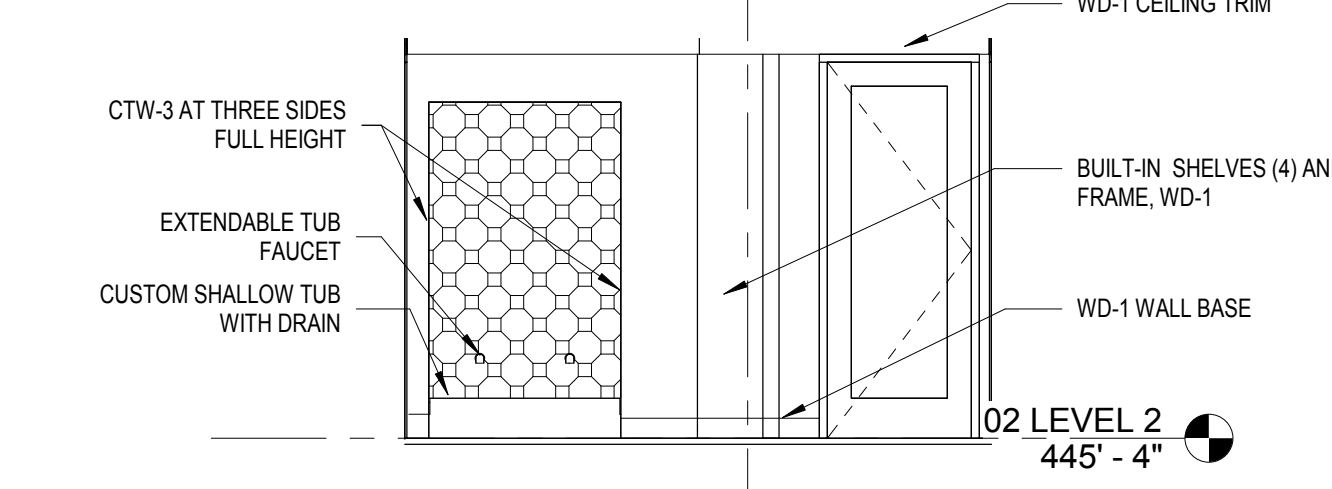
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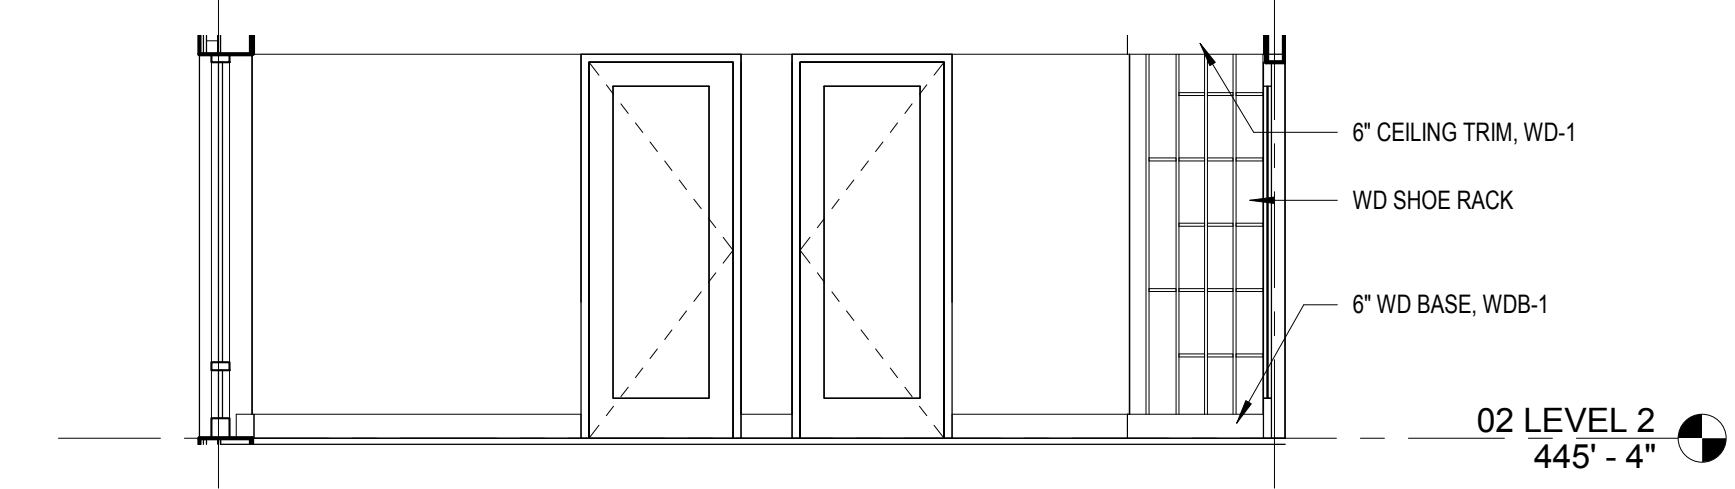
2H ELEVATION - PRAYER ROOM 202C SOUTH
1/4" = 1'-0"




4H ELEVATION - PRAYER ROOM 202B NORTH
1/4" = 1'-0"




6H ELEVATION - PRAYER LOBBY 202 EAST
1/4" = 1'-0"



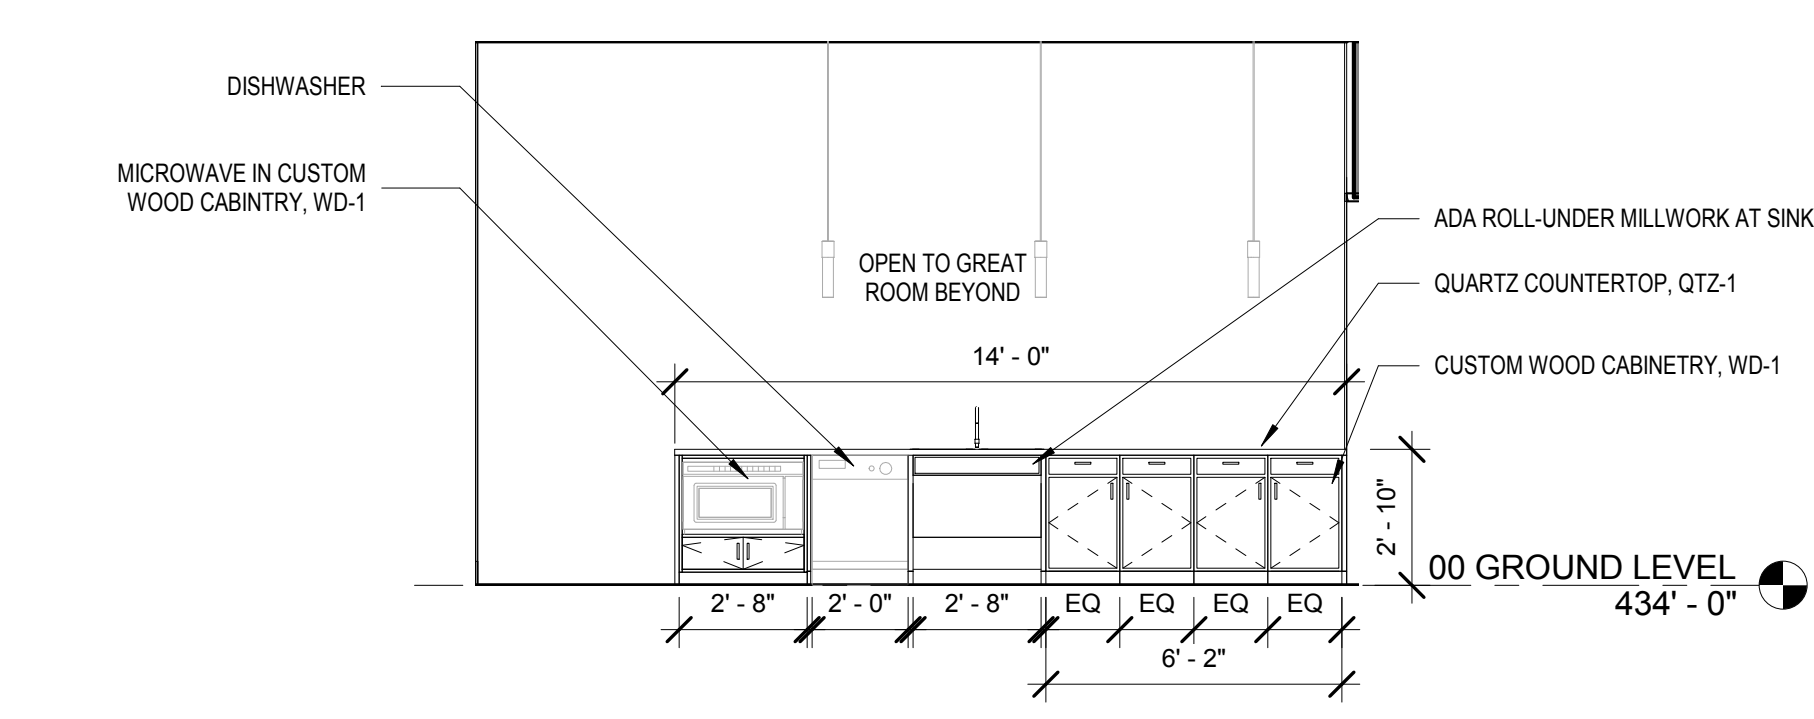
8H ELEVATION - PRAYER LOBBY NORTH
1/4" = 1'-0"



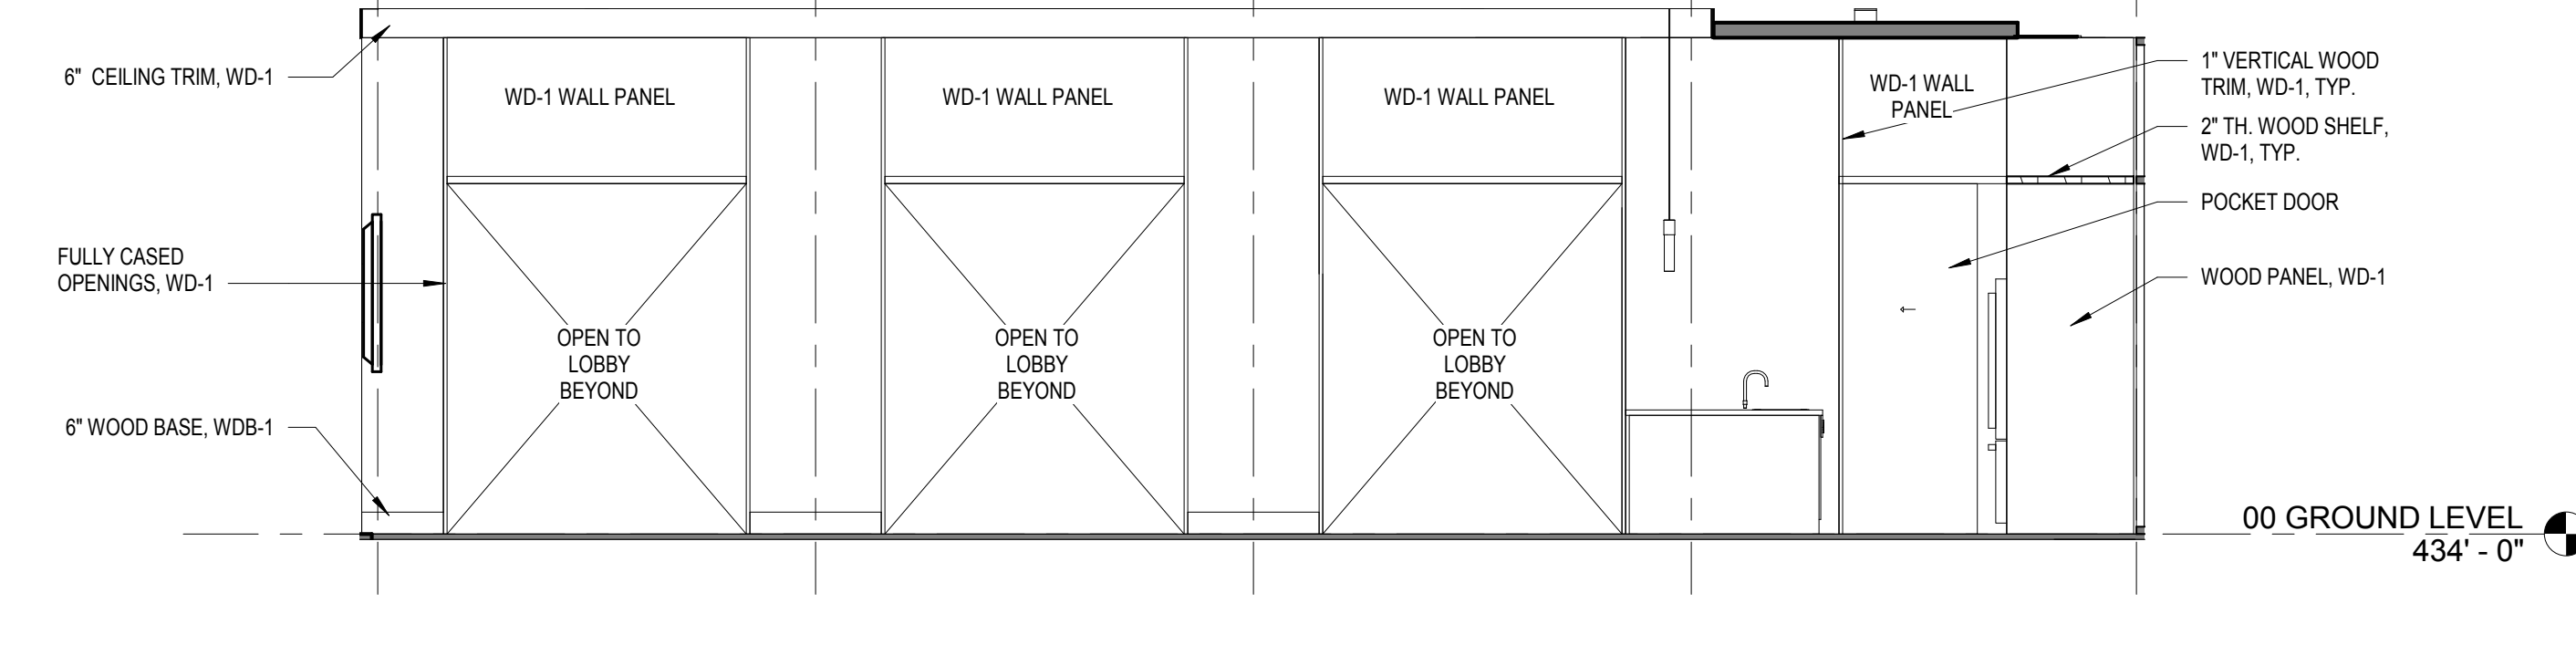
4F ELEVATION - KITCHEN 103 EAST
1/4" = 1'-0"



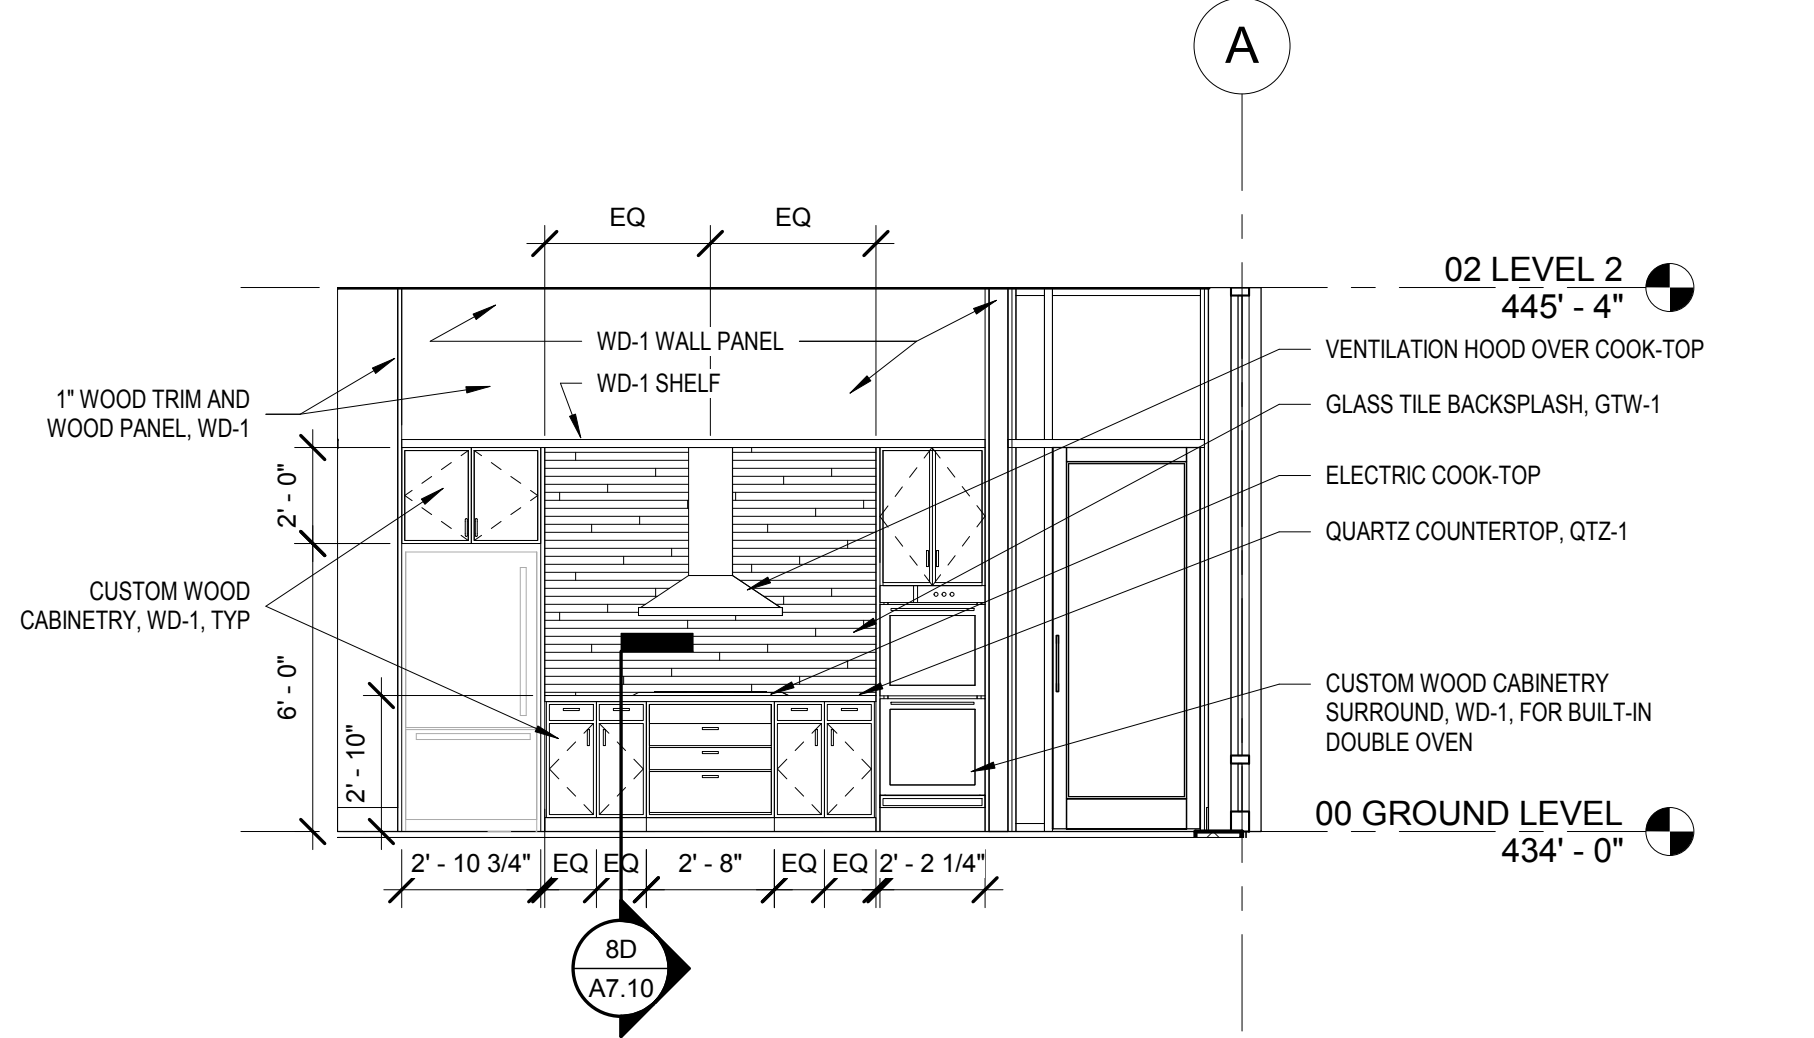
7F ELEVATION - GREAT ROOM 102 SOUTH
1/4" = 1'-0"



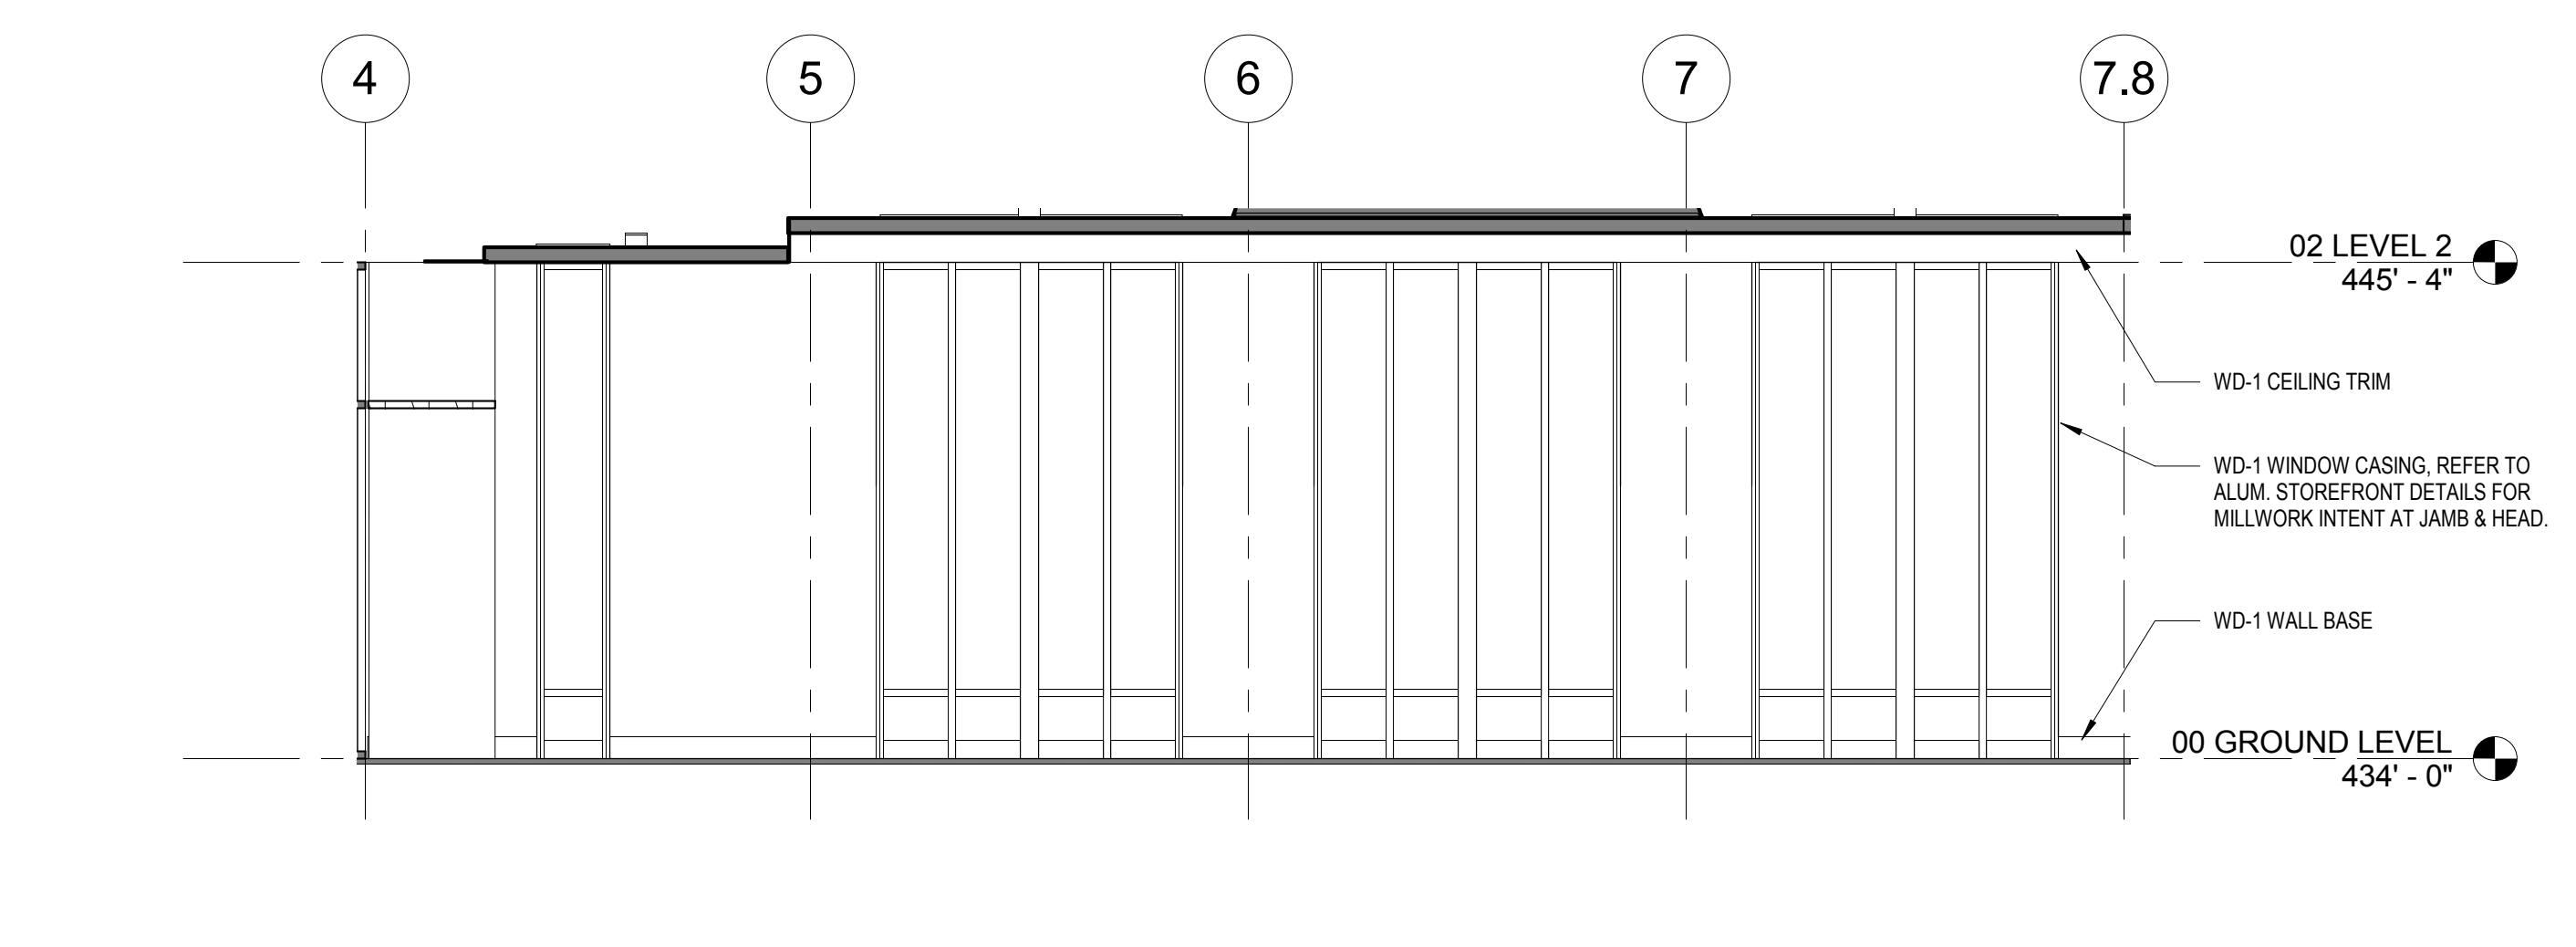
4D ELEVATION - KITCHEN 103 WEST
1/4" = 1'-0"



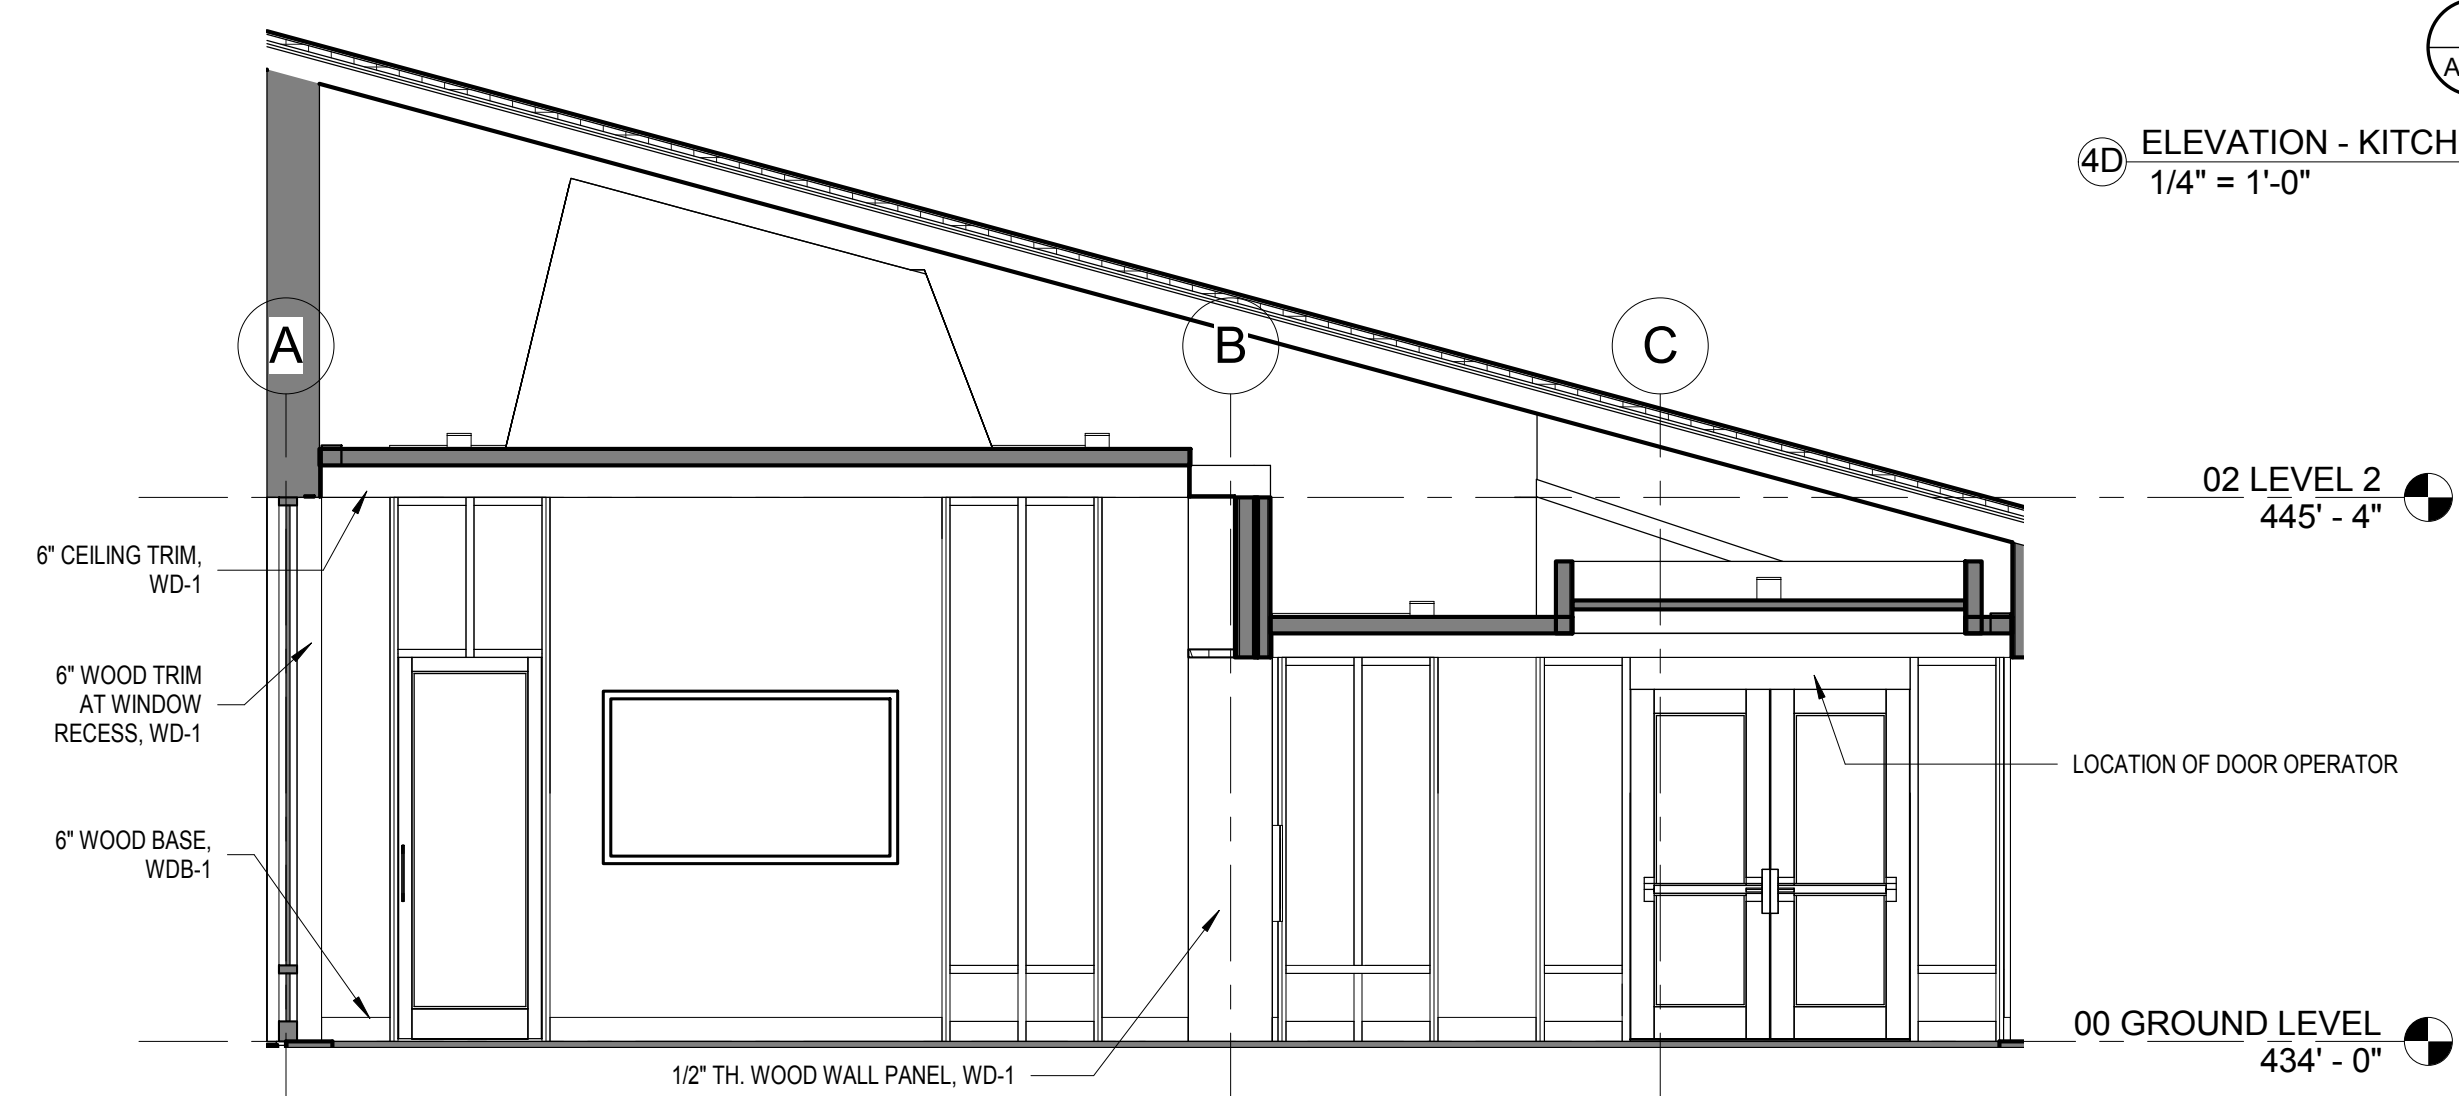
7D ELEVATION - GREAT ROOM 102 NORTH
1/4" = 1'-0"



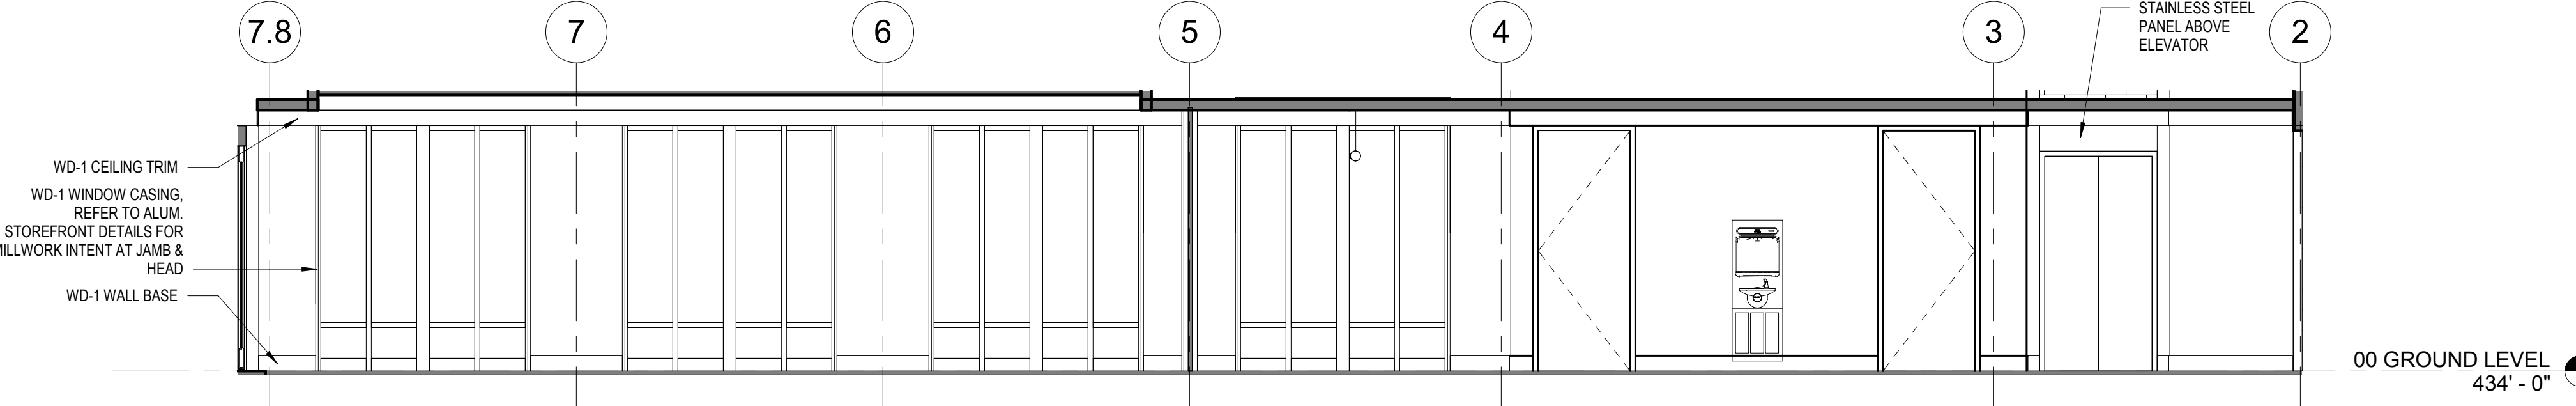
1C ELEVATION - LOBBY 101 / GREAT ROOM 102 EAST
1/4" = 1'-0"



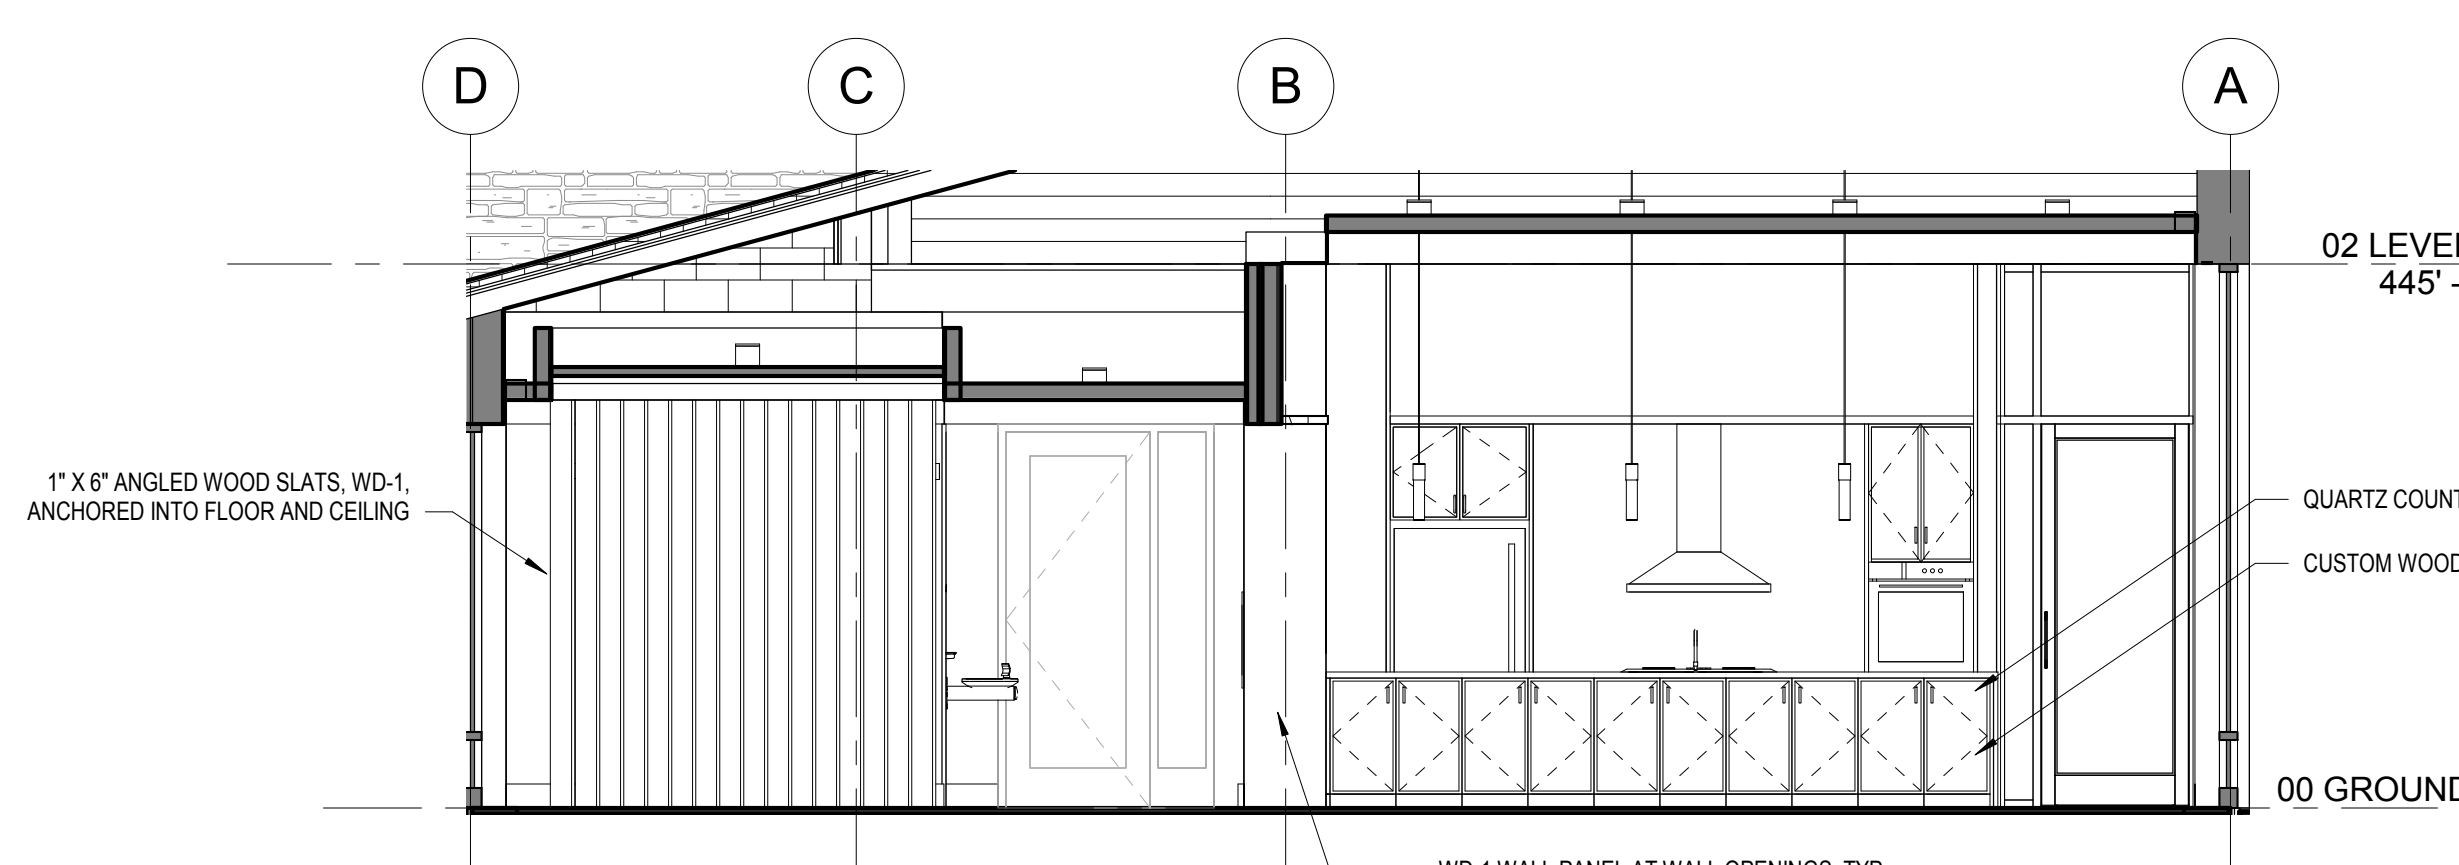5C ELEVATION - LOBBY 101 SOUTH
1/4" = 1'-0"



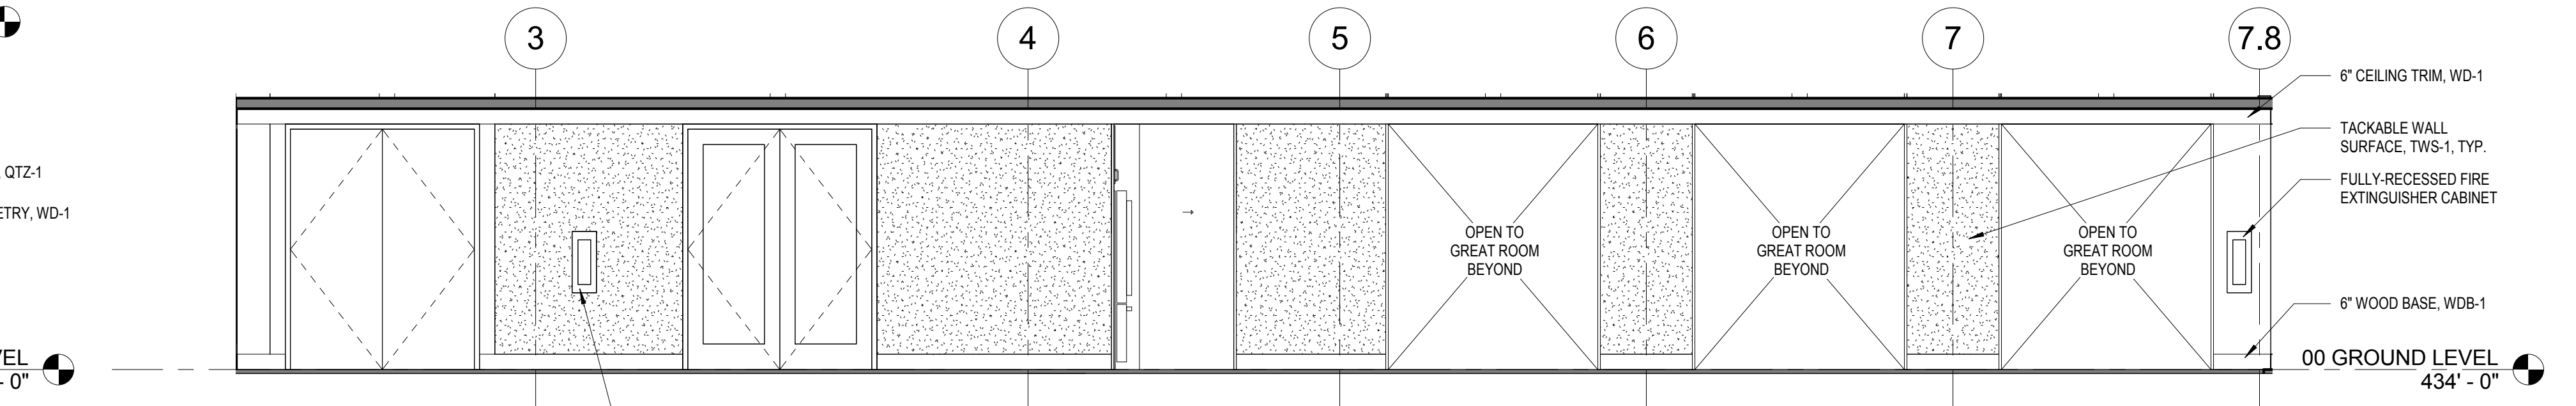1A ELEVATION - LOBBY 101 / GREAT ROOM 102 WEST
1/4" = 1'-0"



5A ELEVATION - LOBBY 101 NORTH
1/4" = 1'-0"

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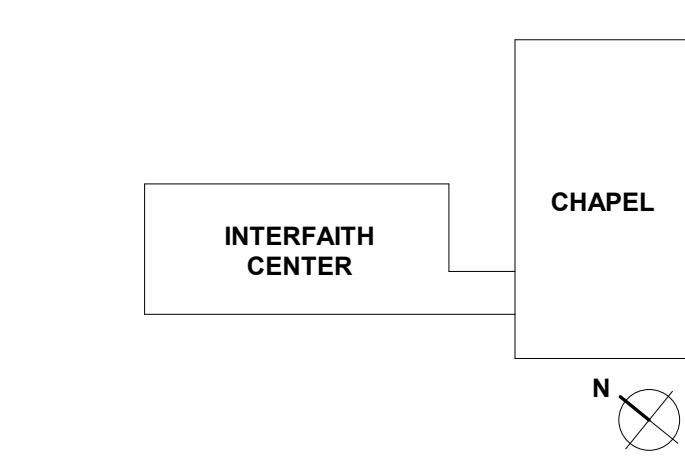
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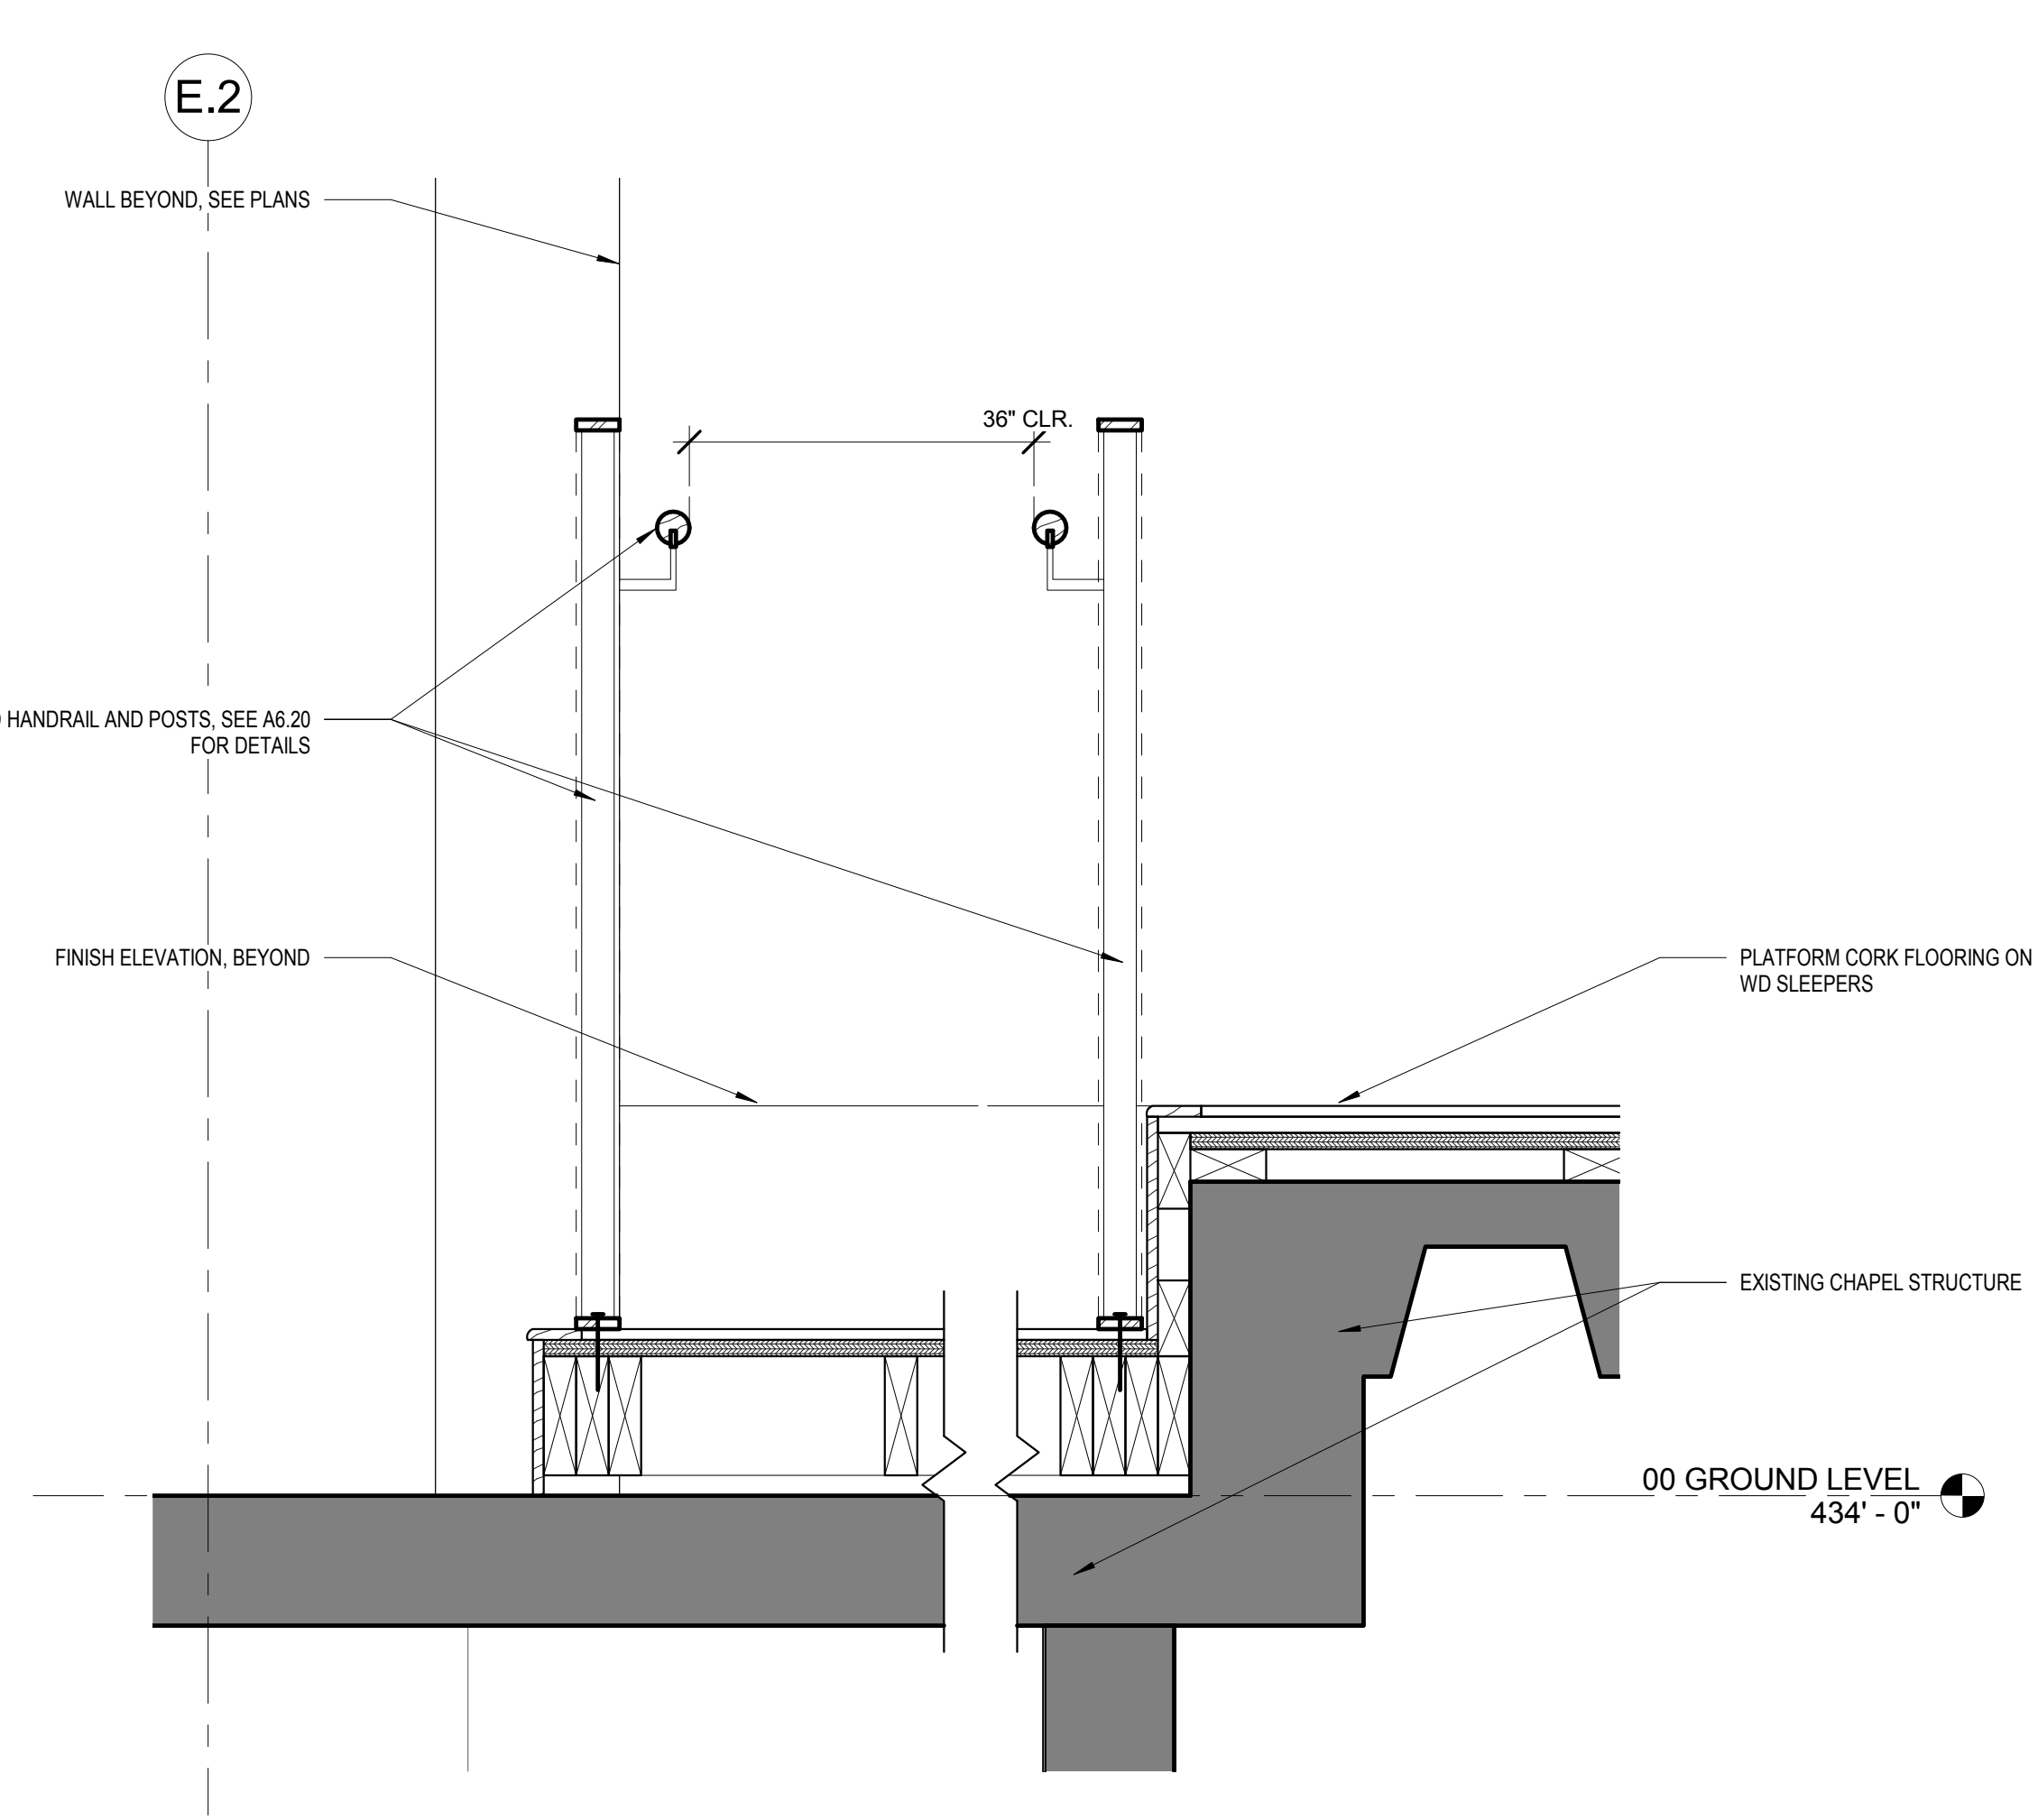
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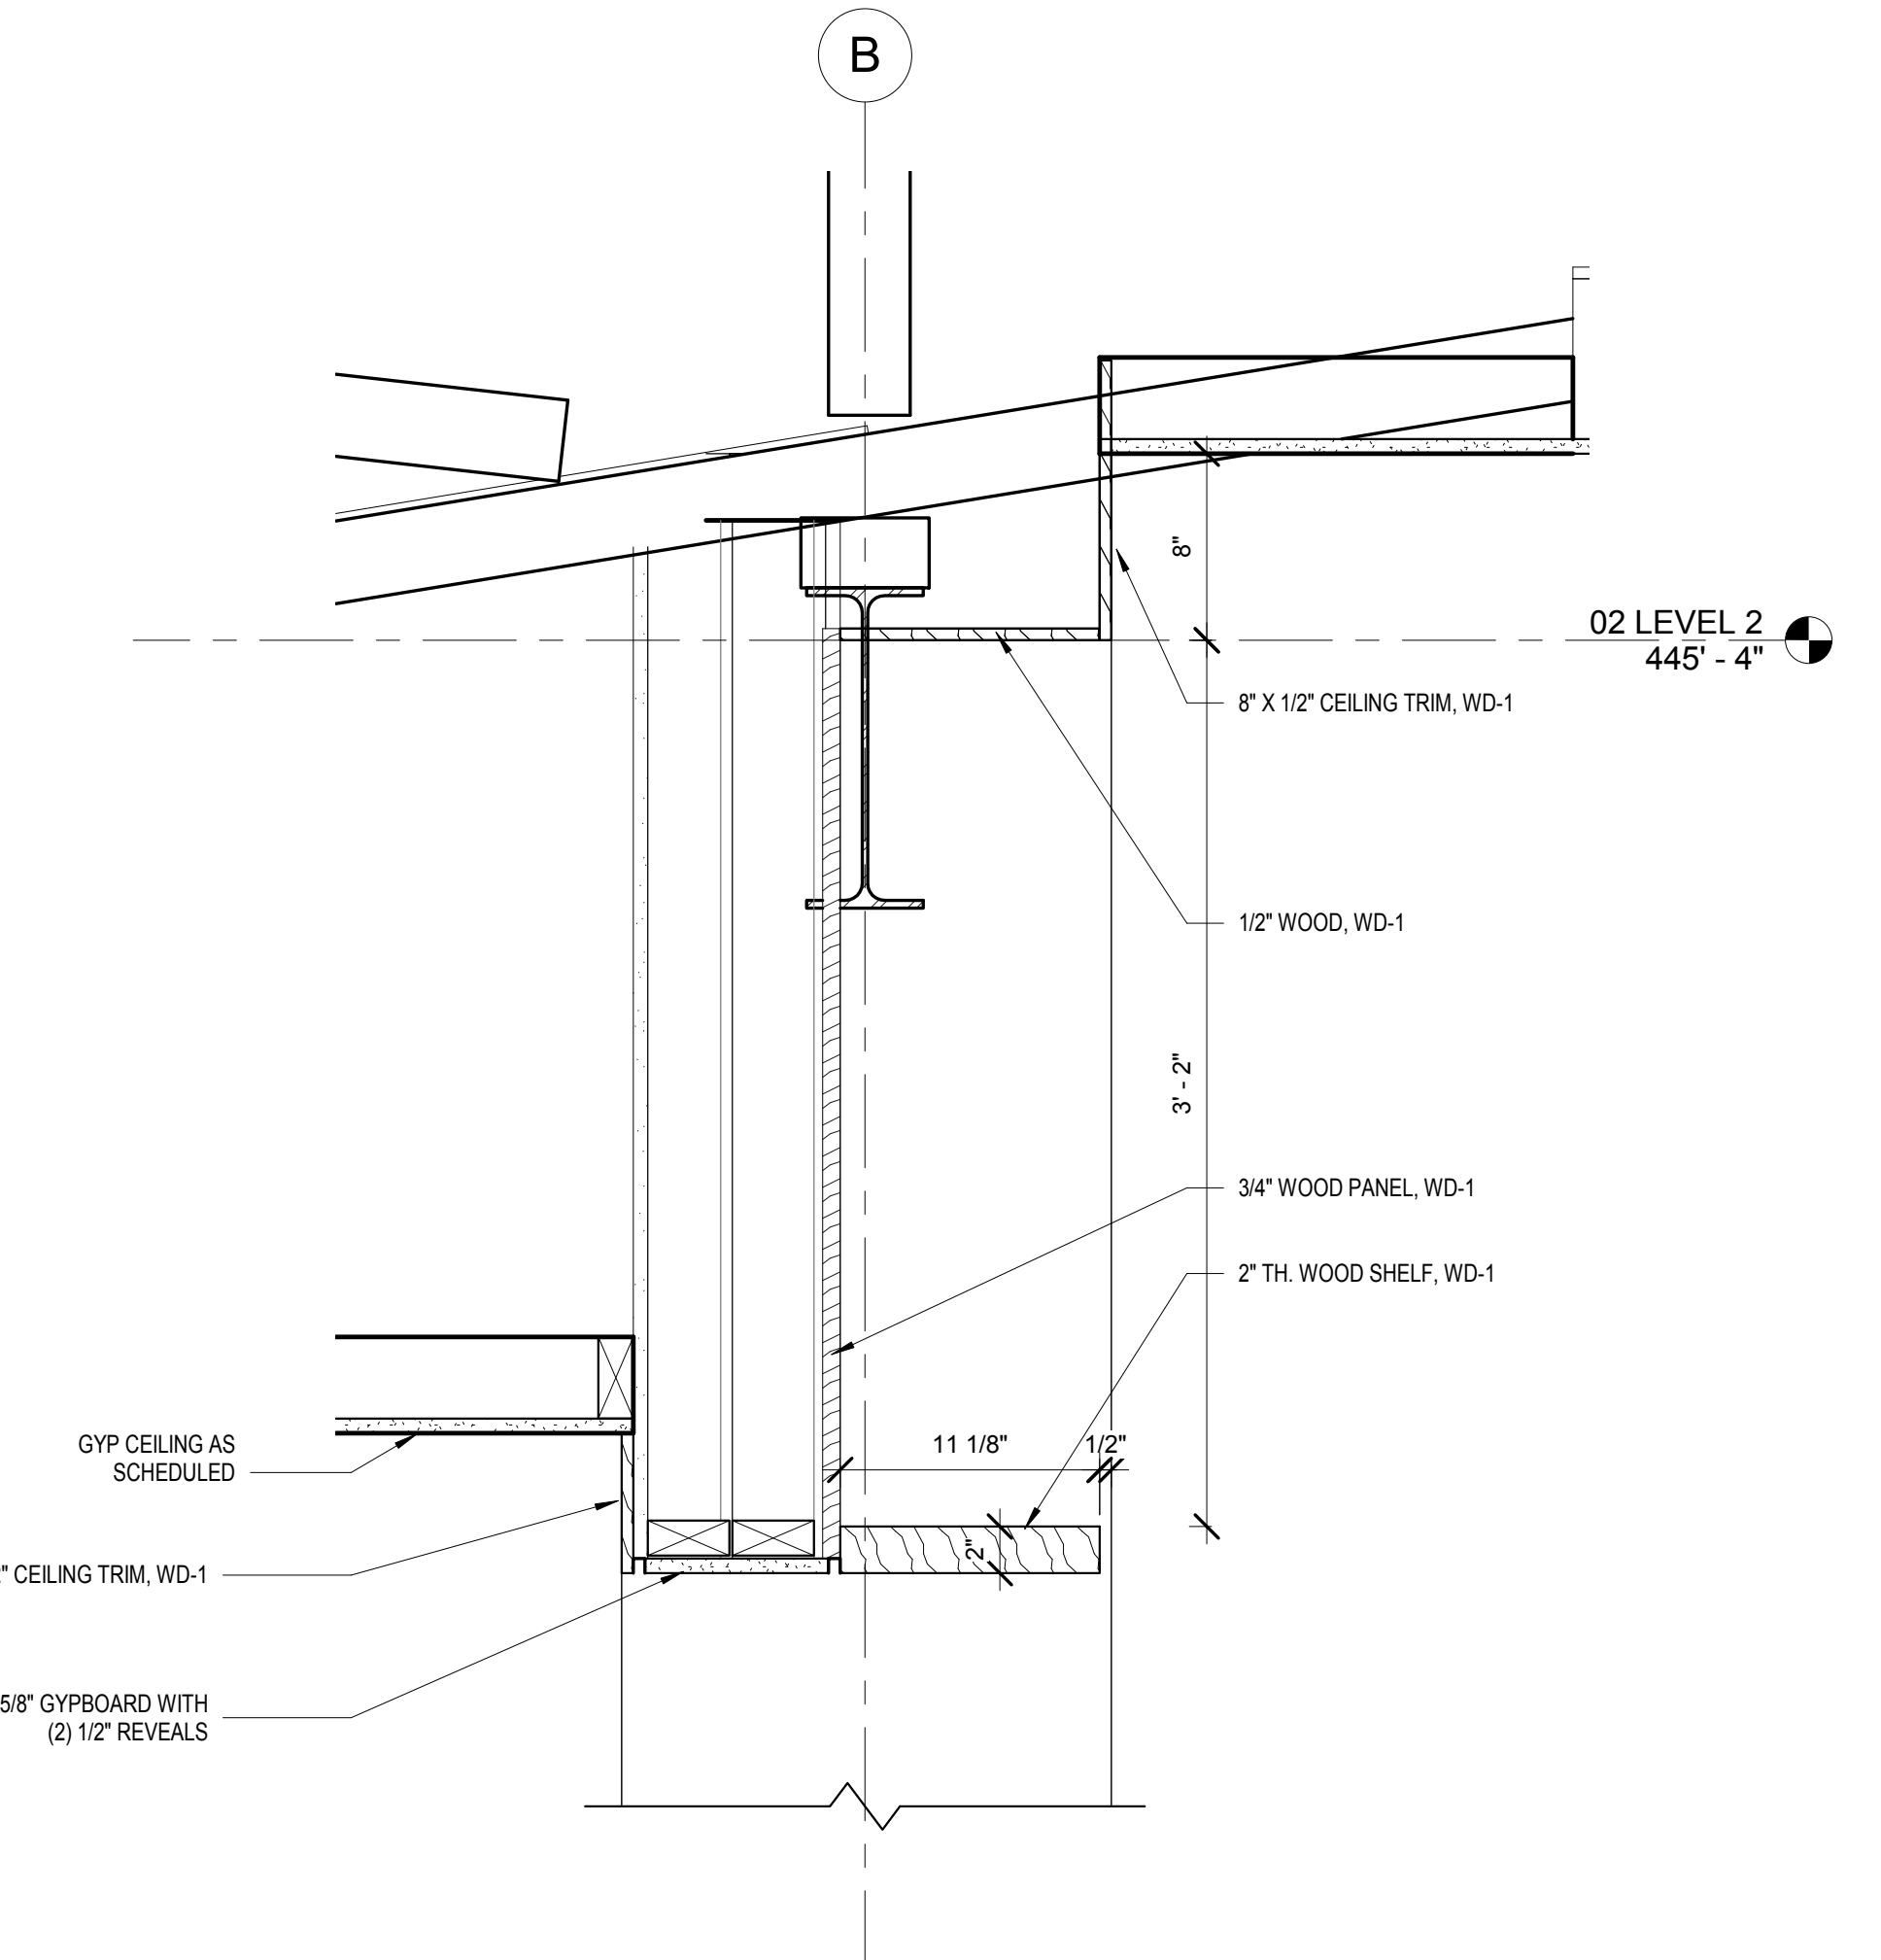
PROJECT DESIGN PHASE
50% CONSTRUCTION DOCUMENTS

DRAWING NAME
INTERIOR DETAILS

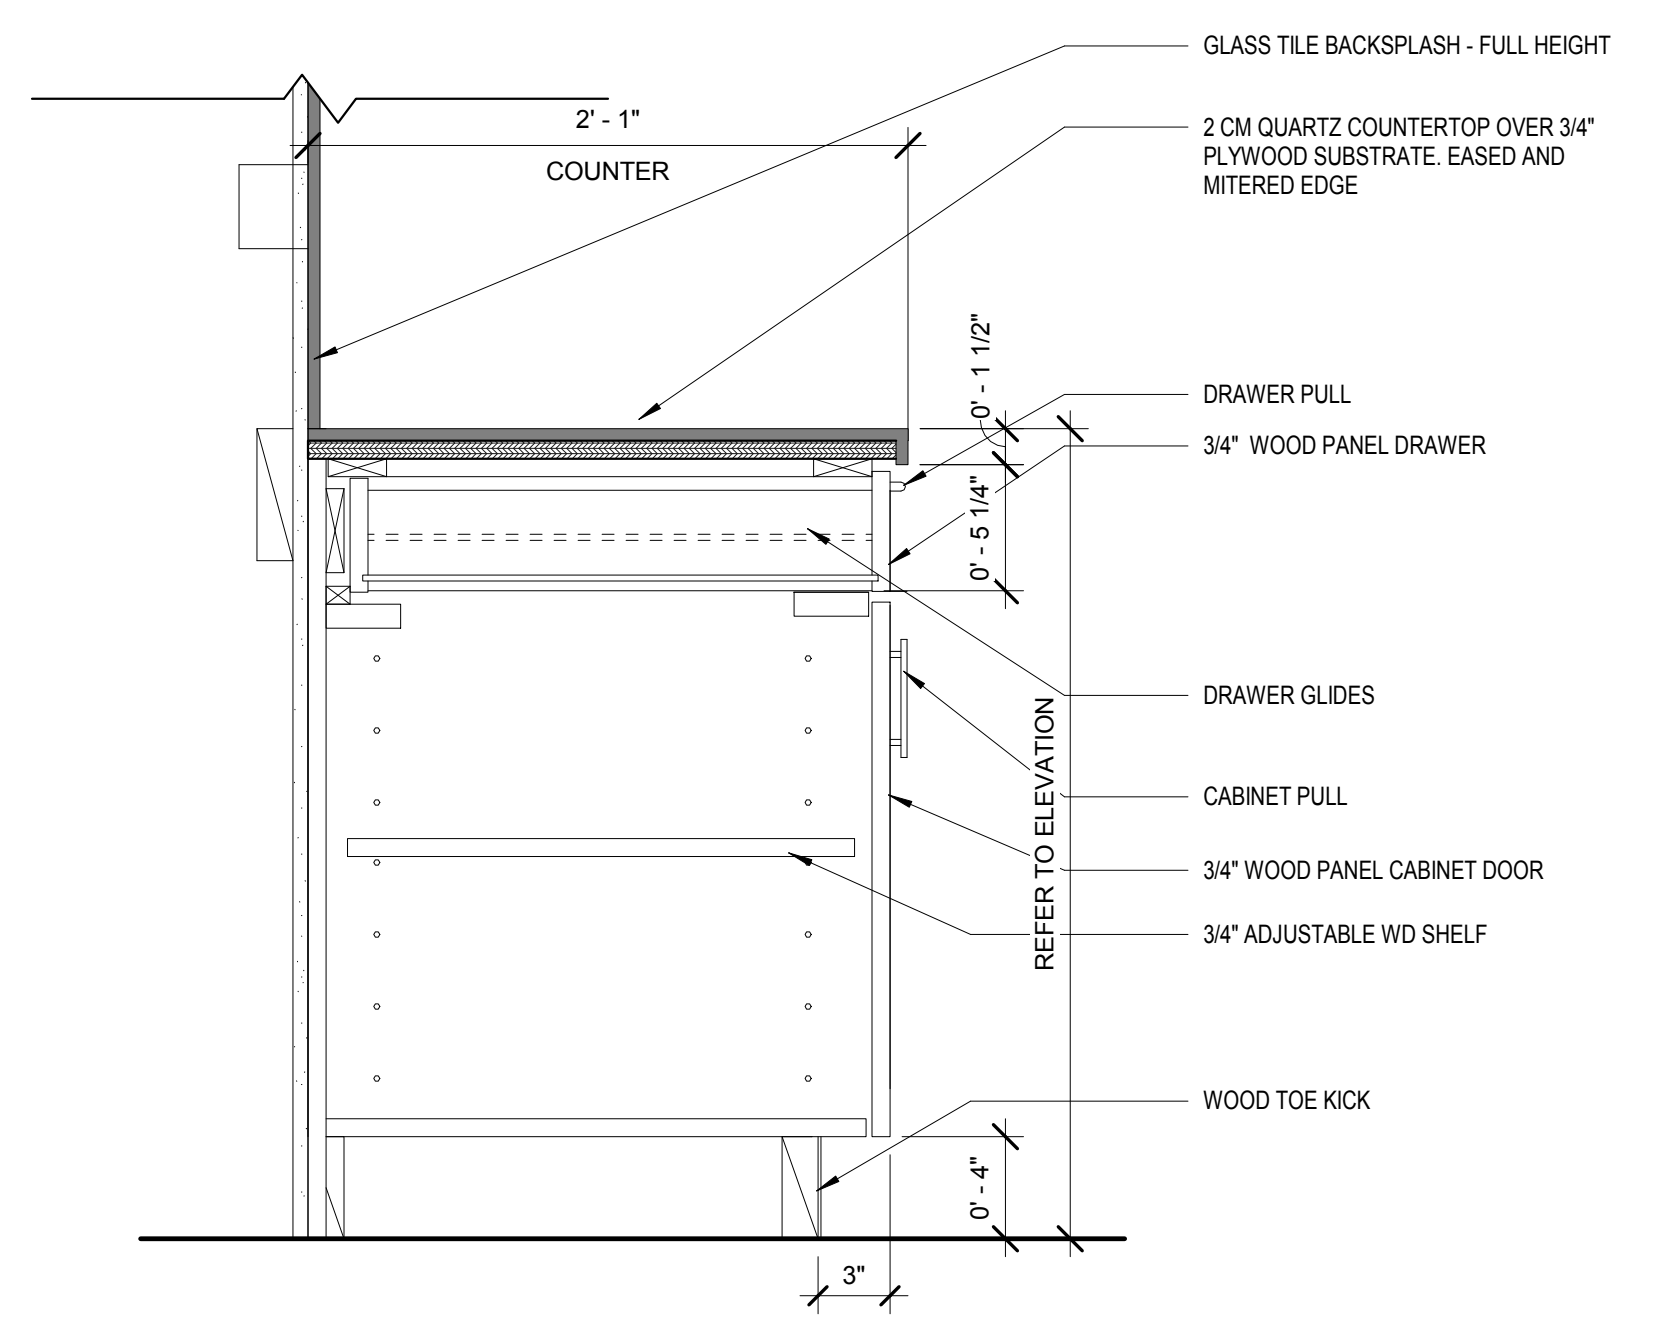
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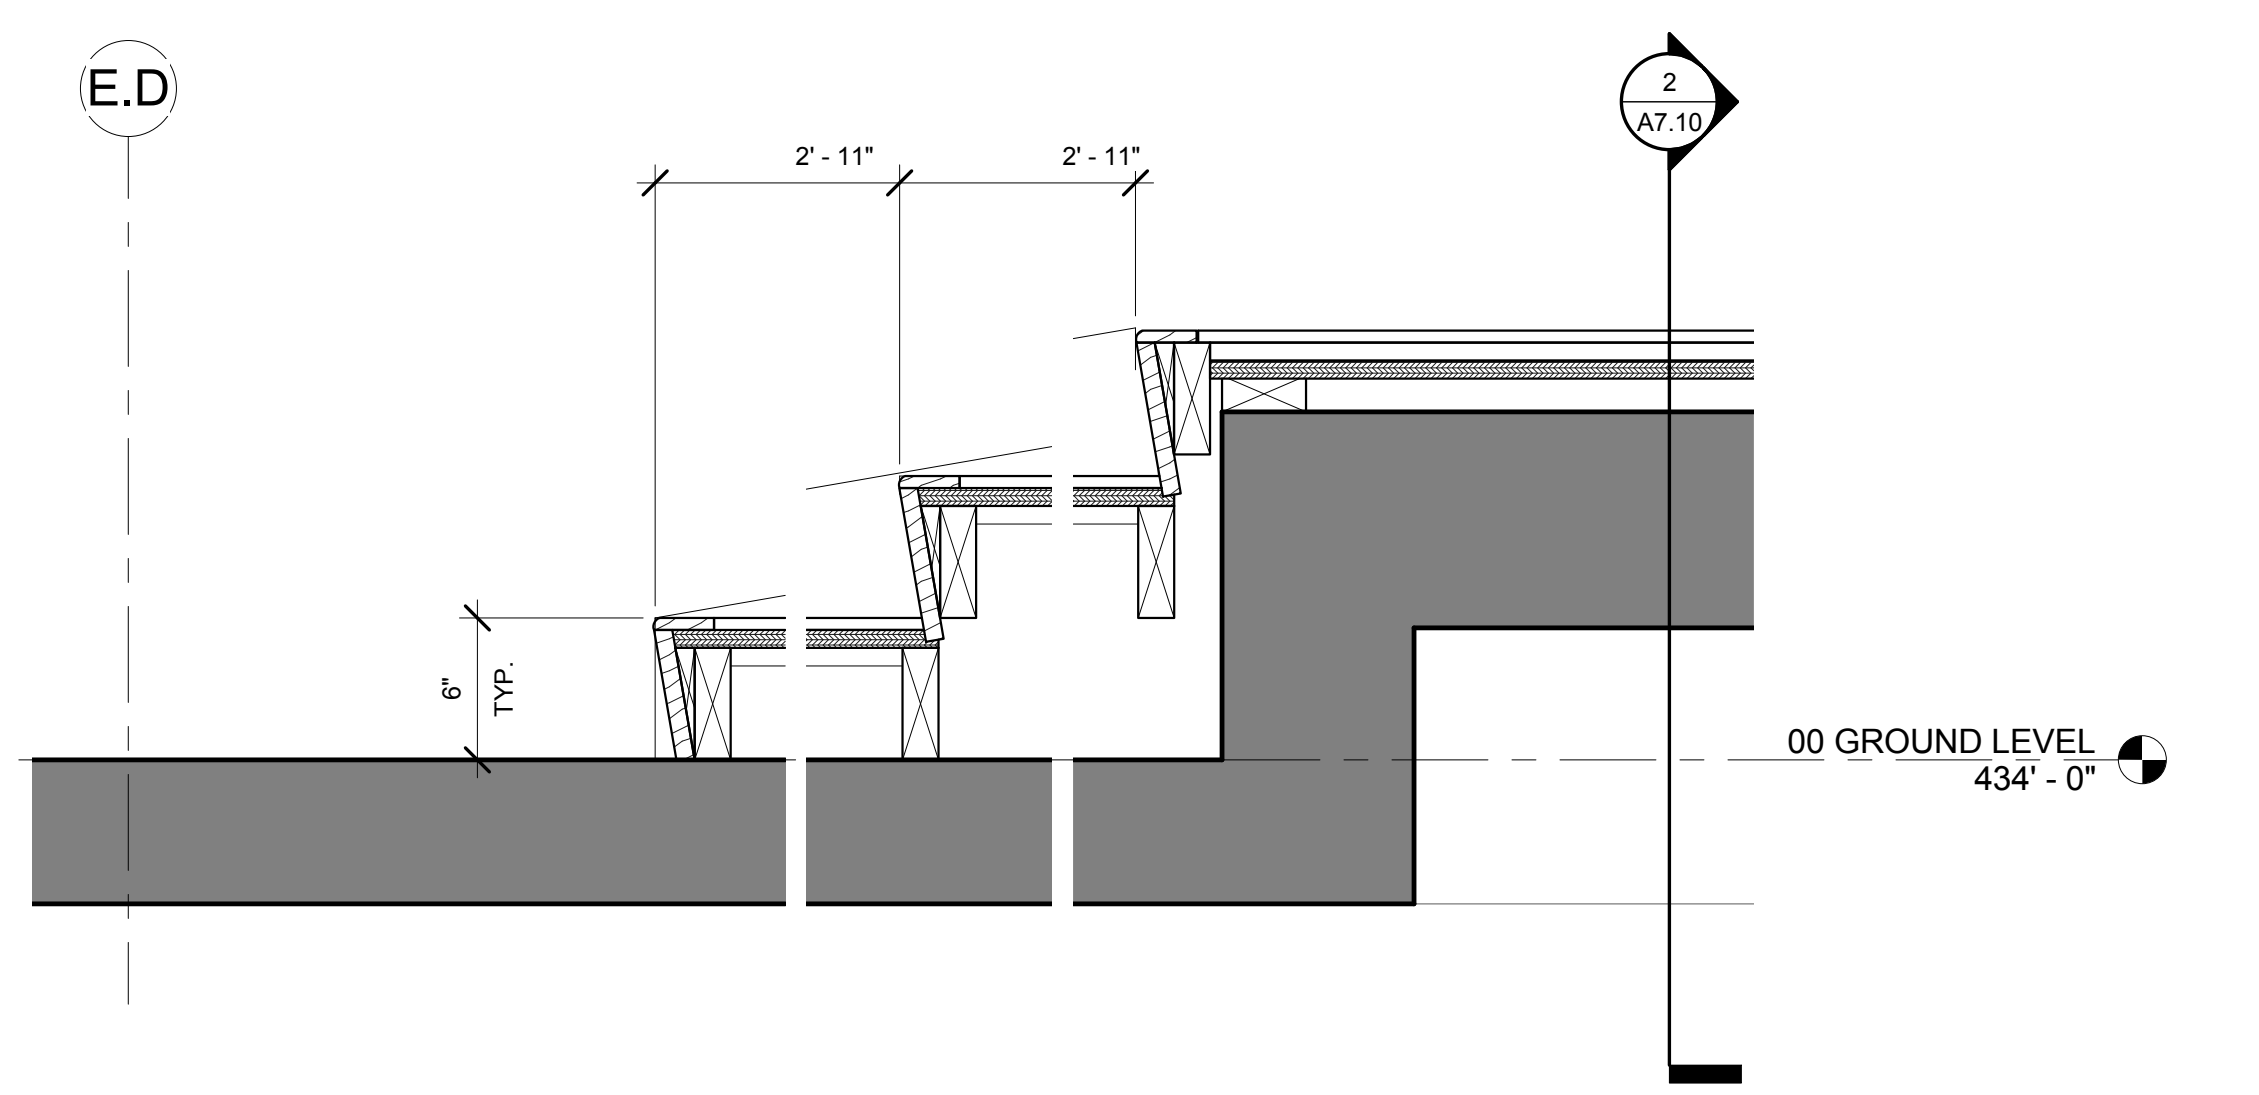
2 CHAPEL PLATFORM - RAMP SECTION
1 1/2" = 1'-0"



1 DOOR WAY MILLWORK SECTION
1 1/2" = 1'-0"



8D KITCHEN BASE CABINET DETAIL
1 1/2" = 1'-0"



3 CHAPEL PLATFORM - STAIR SECTION
1 1/2" = 1'-0"

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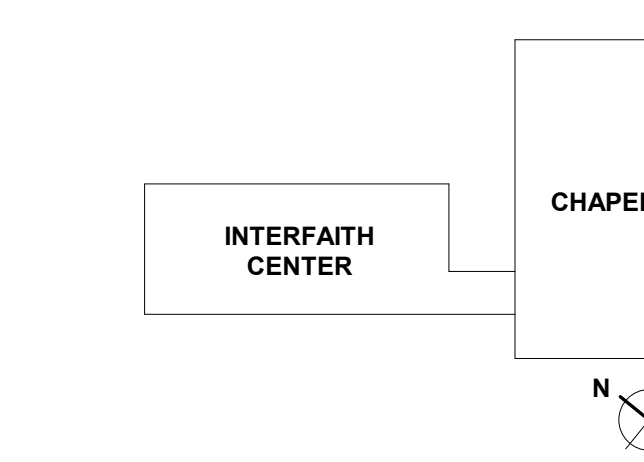
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ISSUE DATE:	04/28/17
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JOB NO.:	21641.00
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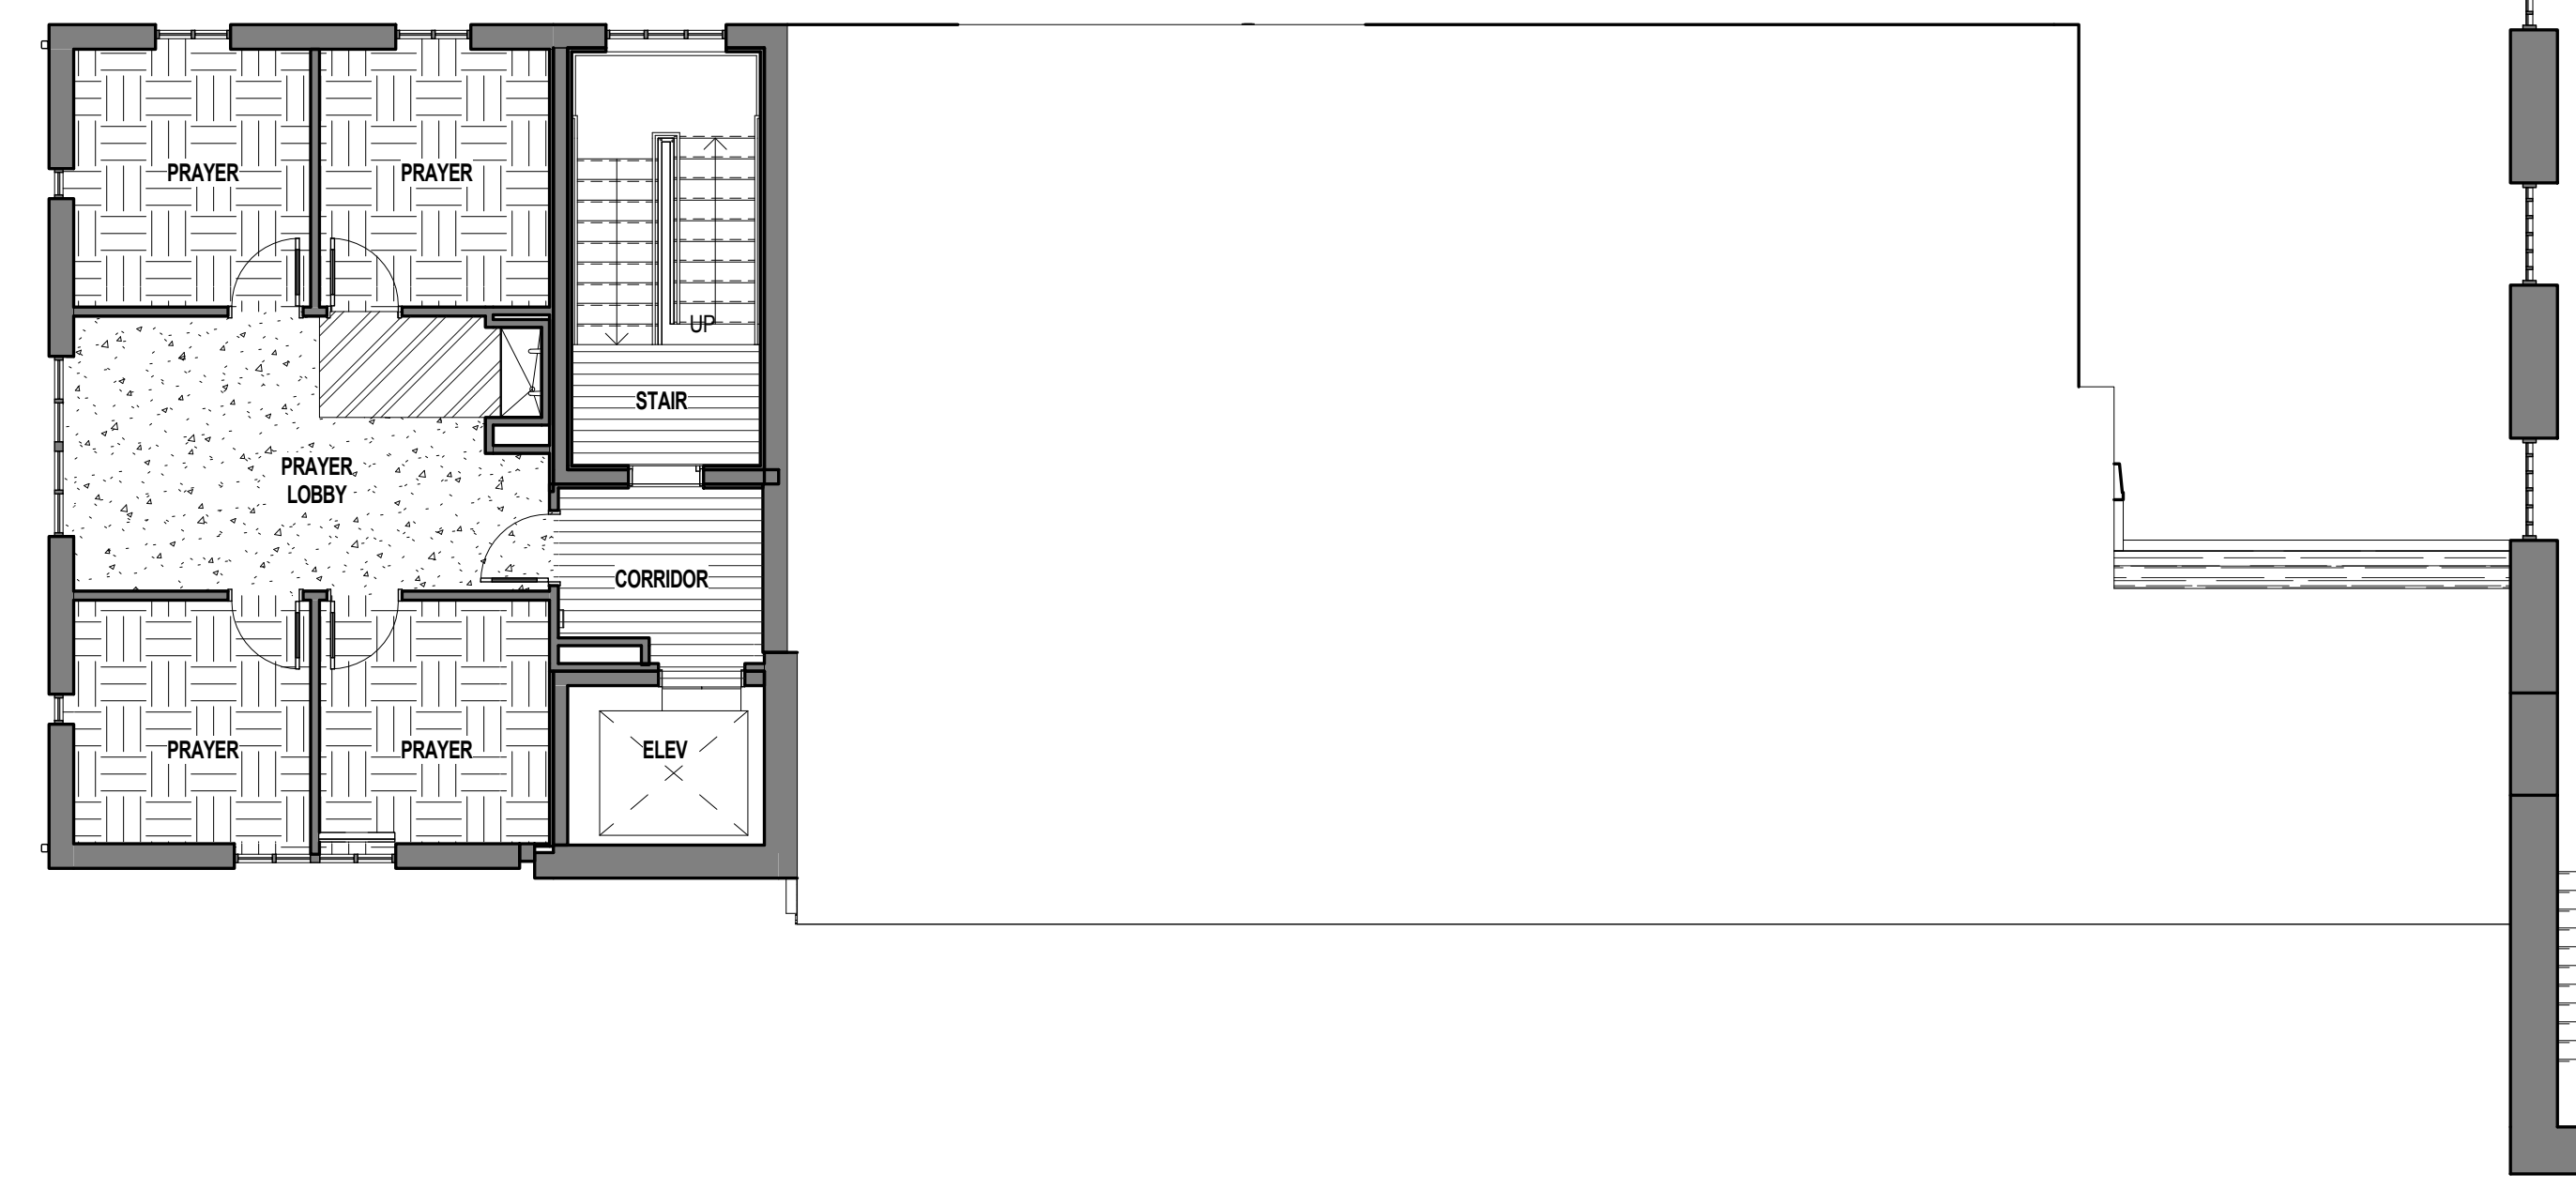
PROJECT DESIGN PHASE
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DRAWING NAME
FINISH FLOOR PLANS


DRAWING NUMBER
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FLOOR FINISH LEGEND


- CPT-1 [Pattern]
- CPT-2 [Pattern]
- CPT-3 [Pattern]
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- CPT-6 [Pattern]
- CPT-7 [Pattern]
- CPT-8 [Pattern]
- CPT-9 [Pattern]
- CPT-10 [Pattern]
- CPT-11 [Pattern]
- CPT-12 [Pattern]
- PFT-1 [Pattern]
- PFT-2 [Pattern]
- PFT-3 [Pattern]
- SCO [Pattern]



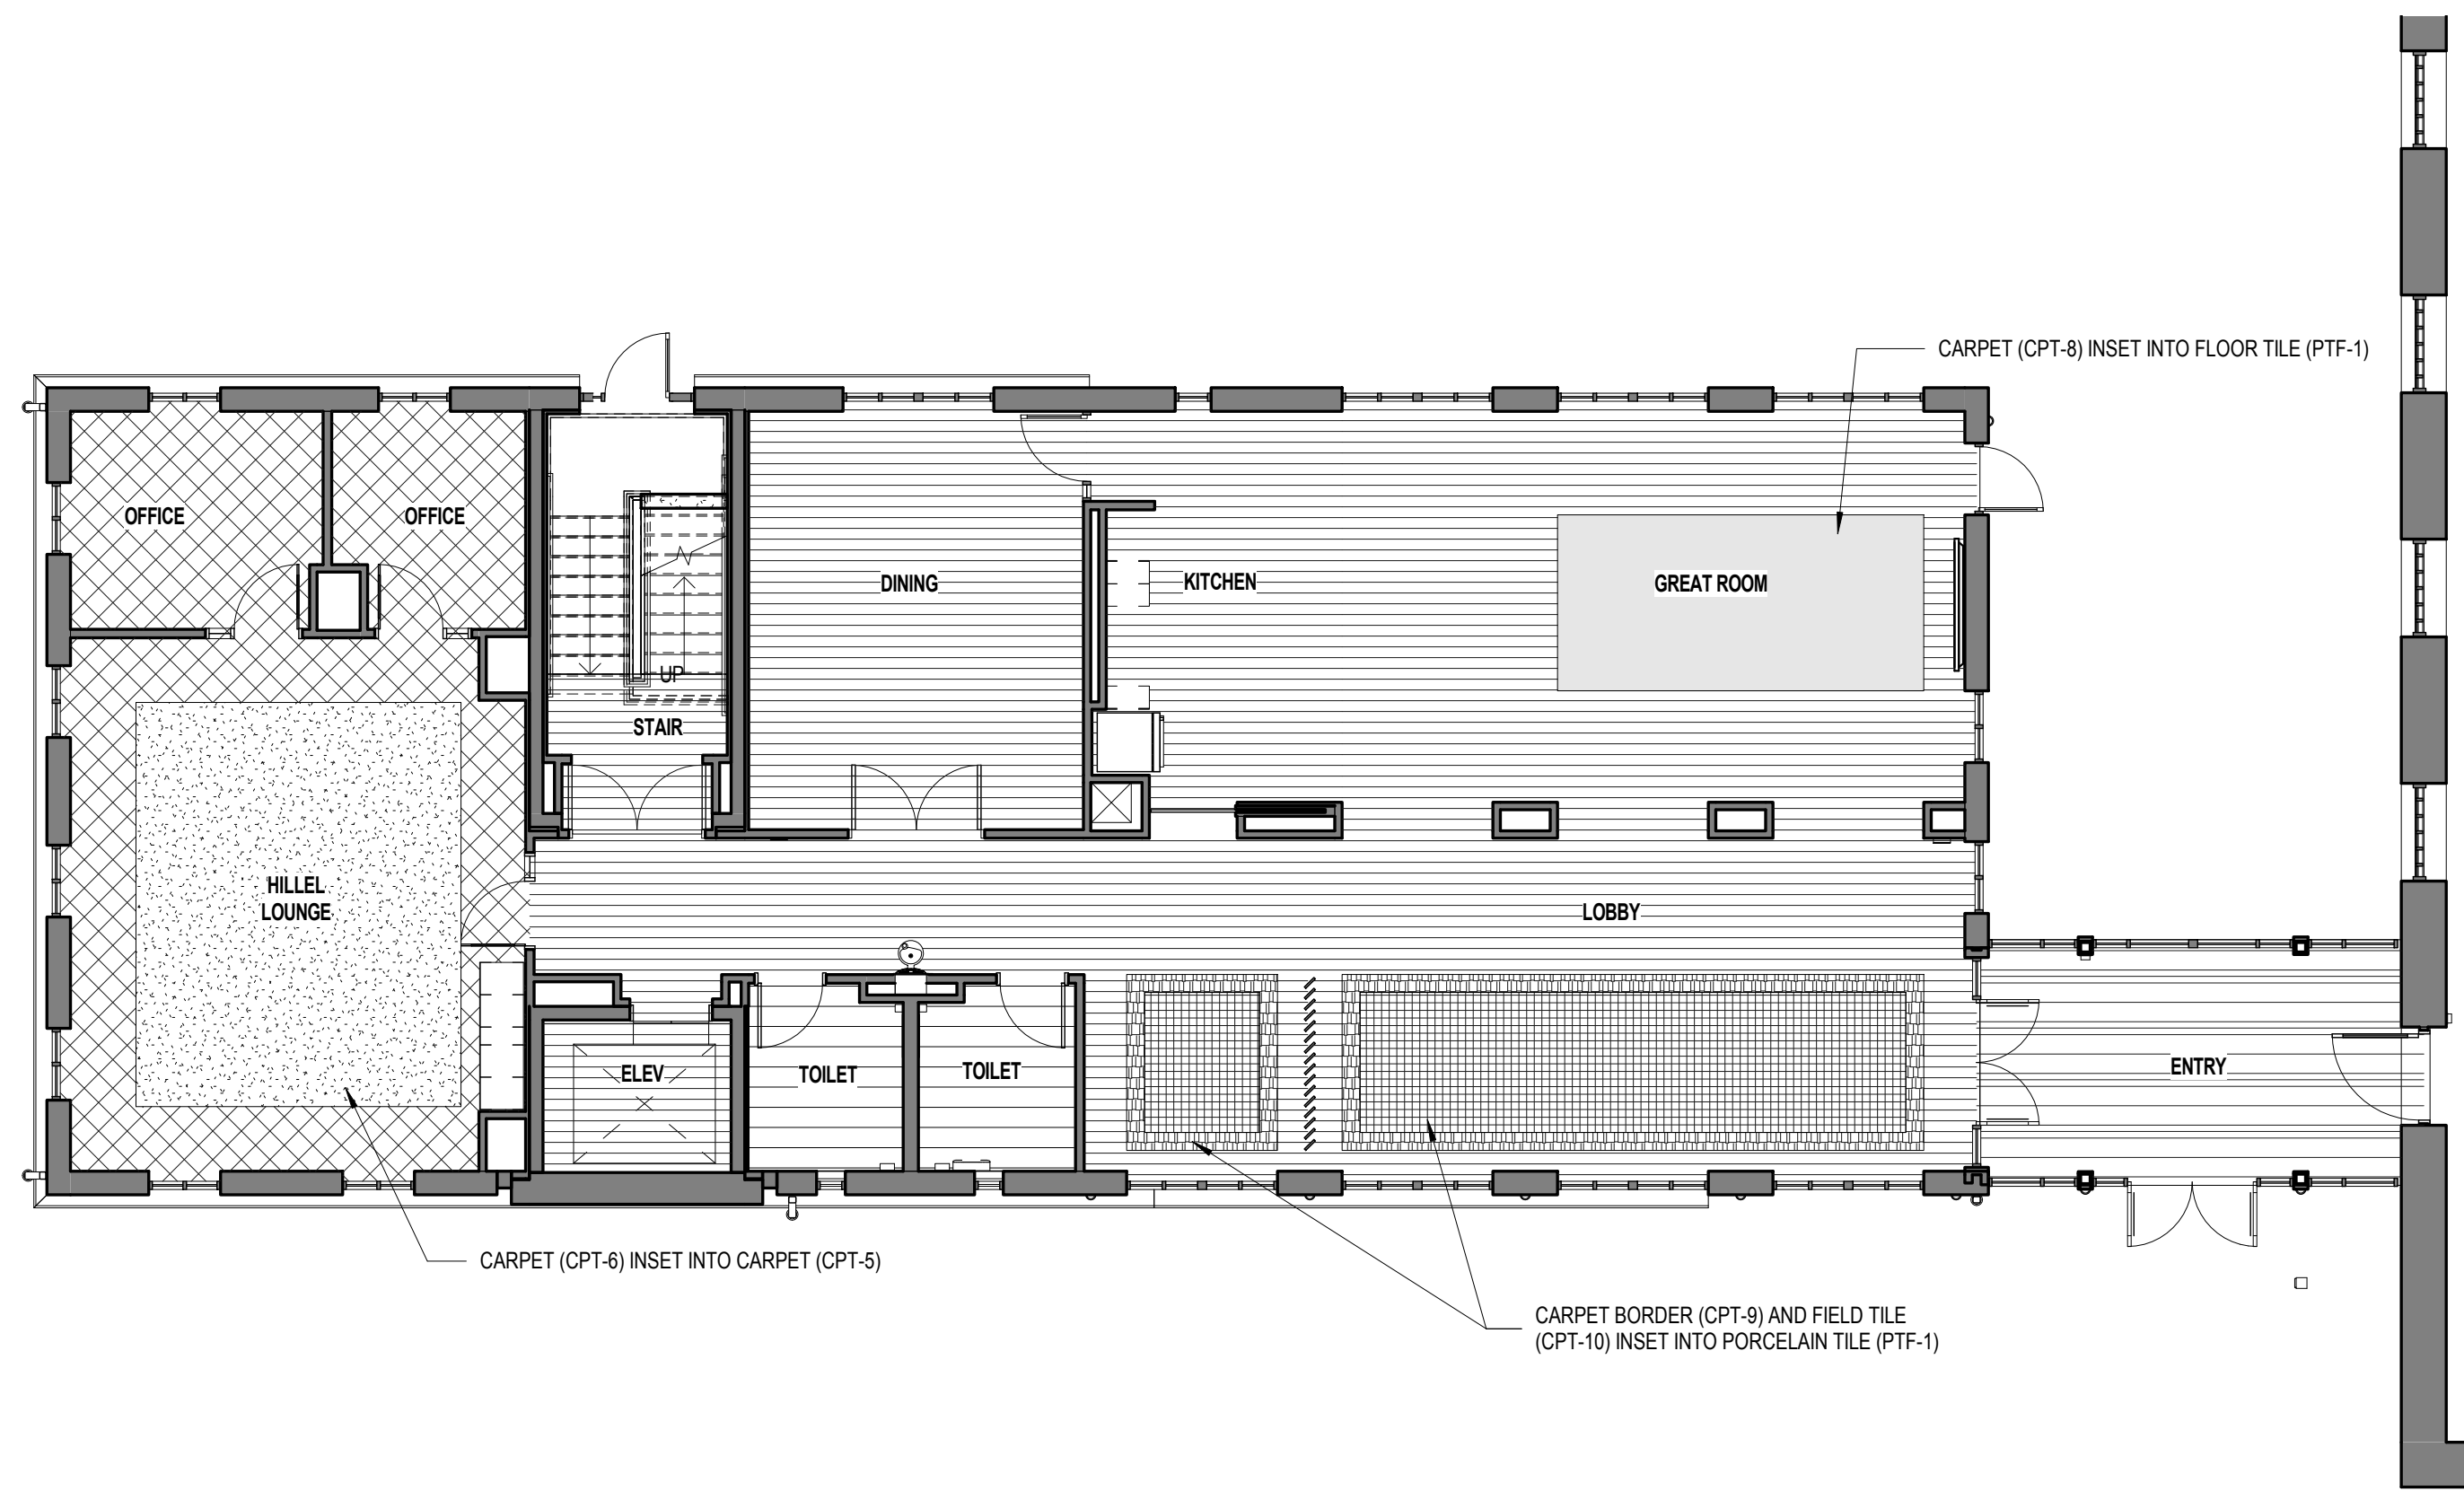1G LEVEL 2 - FINISH PLAN
1/8" = 1'-0"




1C LEVEL 1 - FINISH PLAN
1/8" = 1'-0"

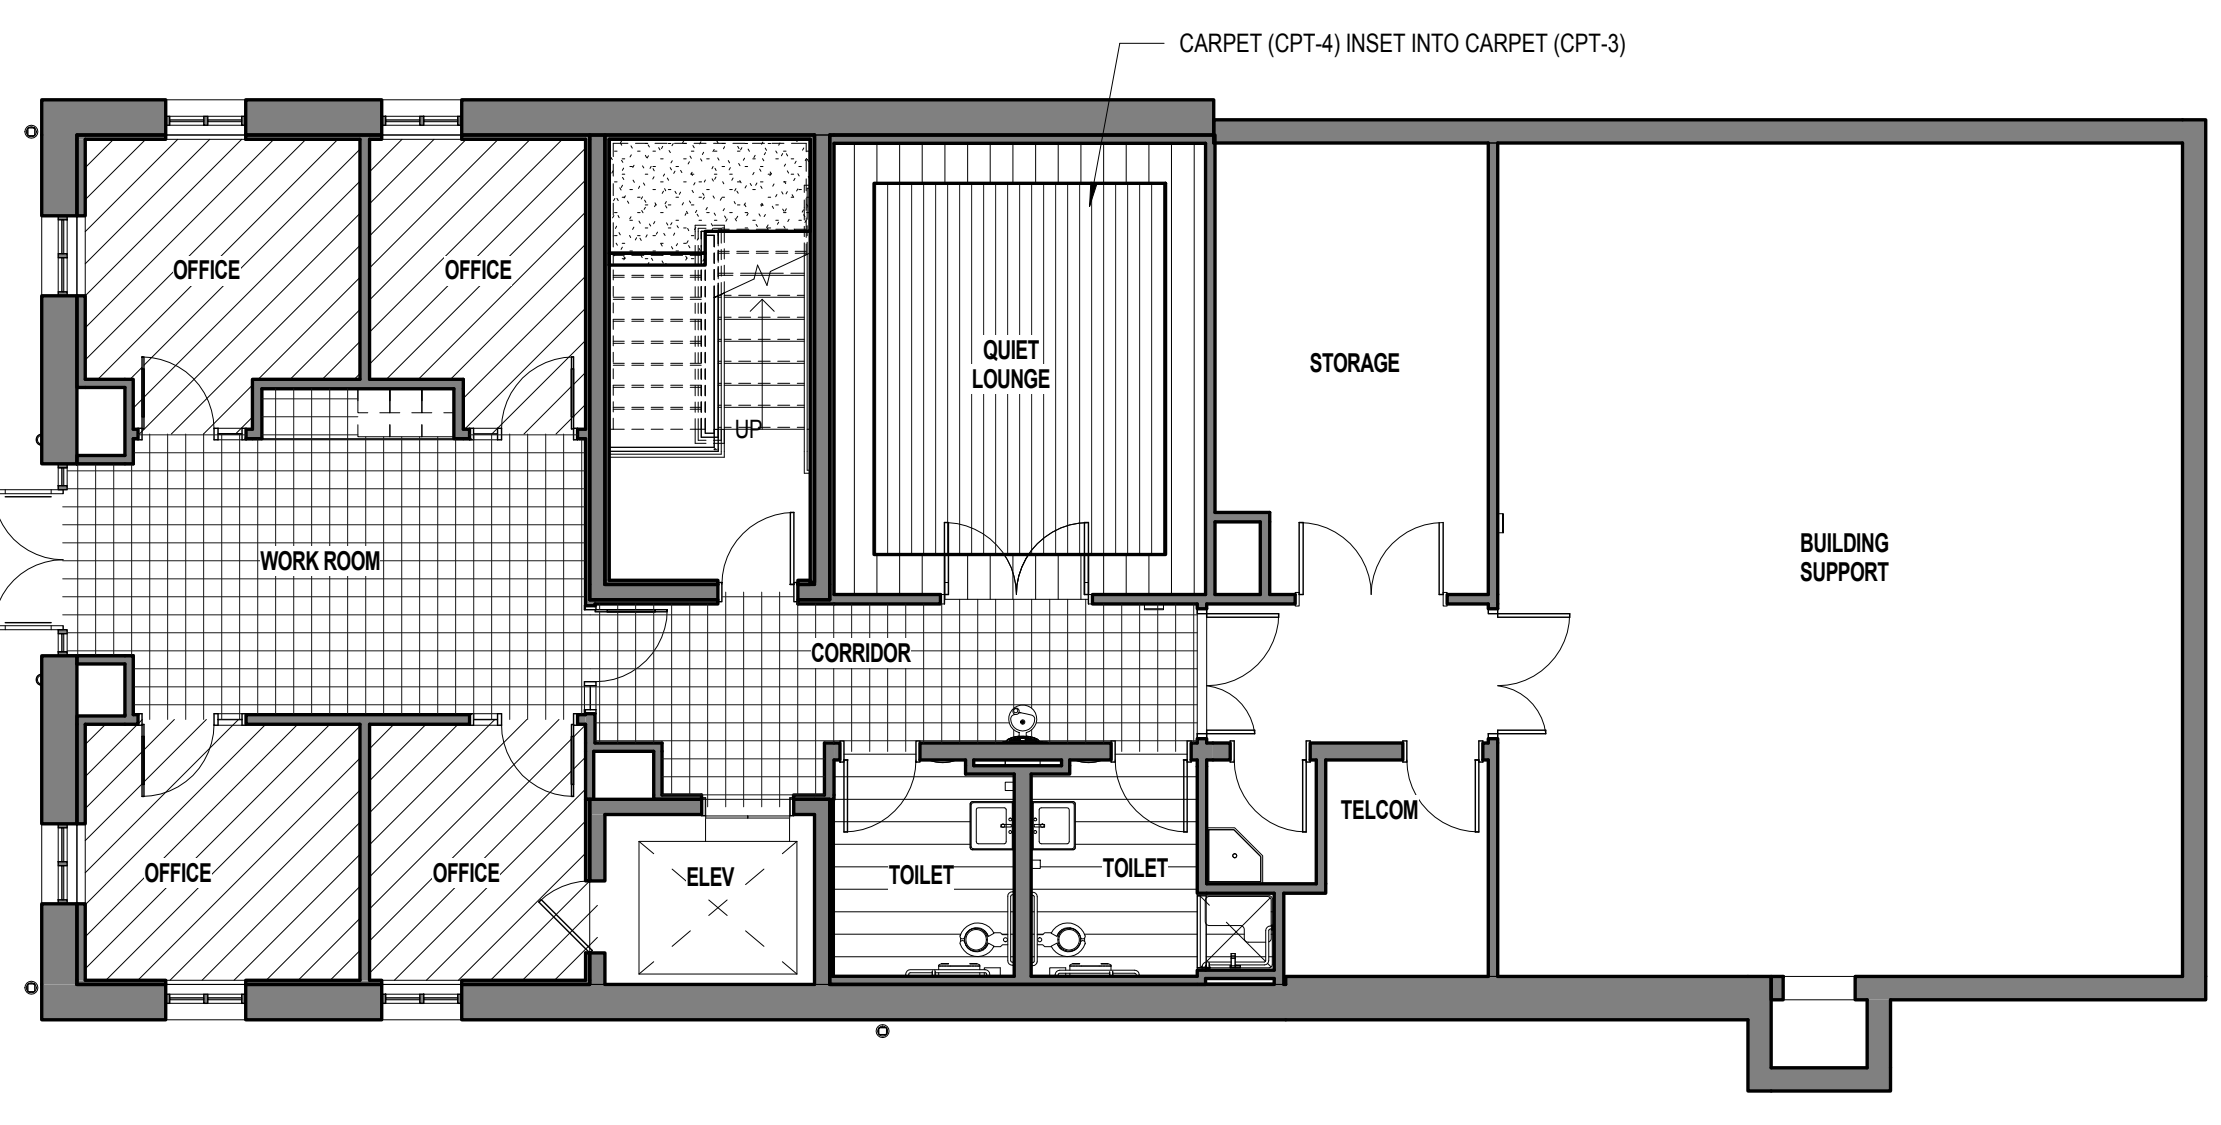

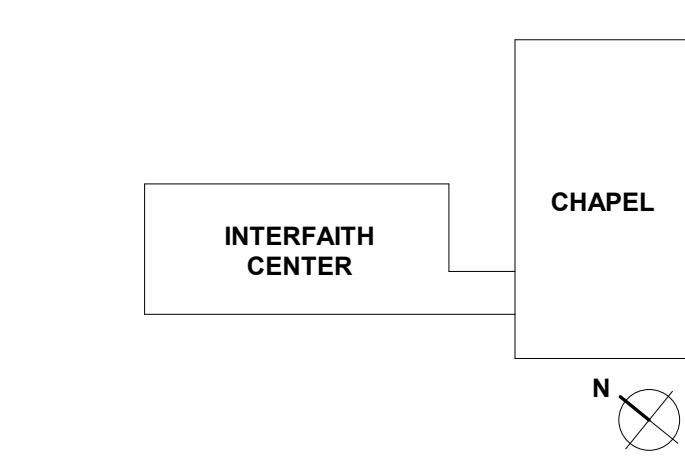1A LOWER LEVEL - FINISH PLAN
1/8" = 1'-0"

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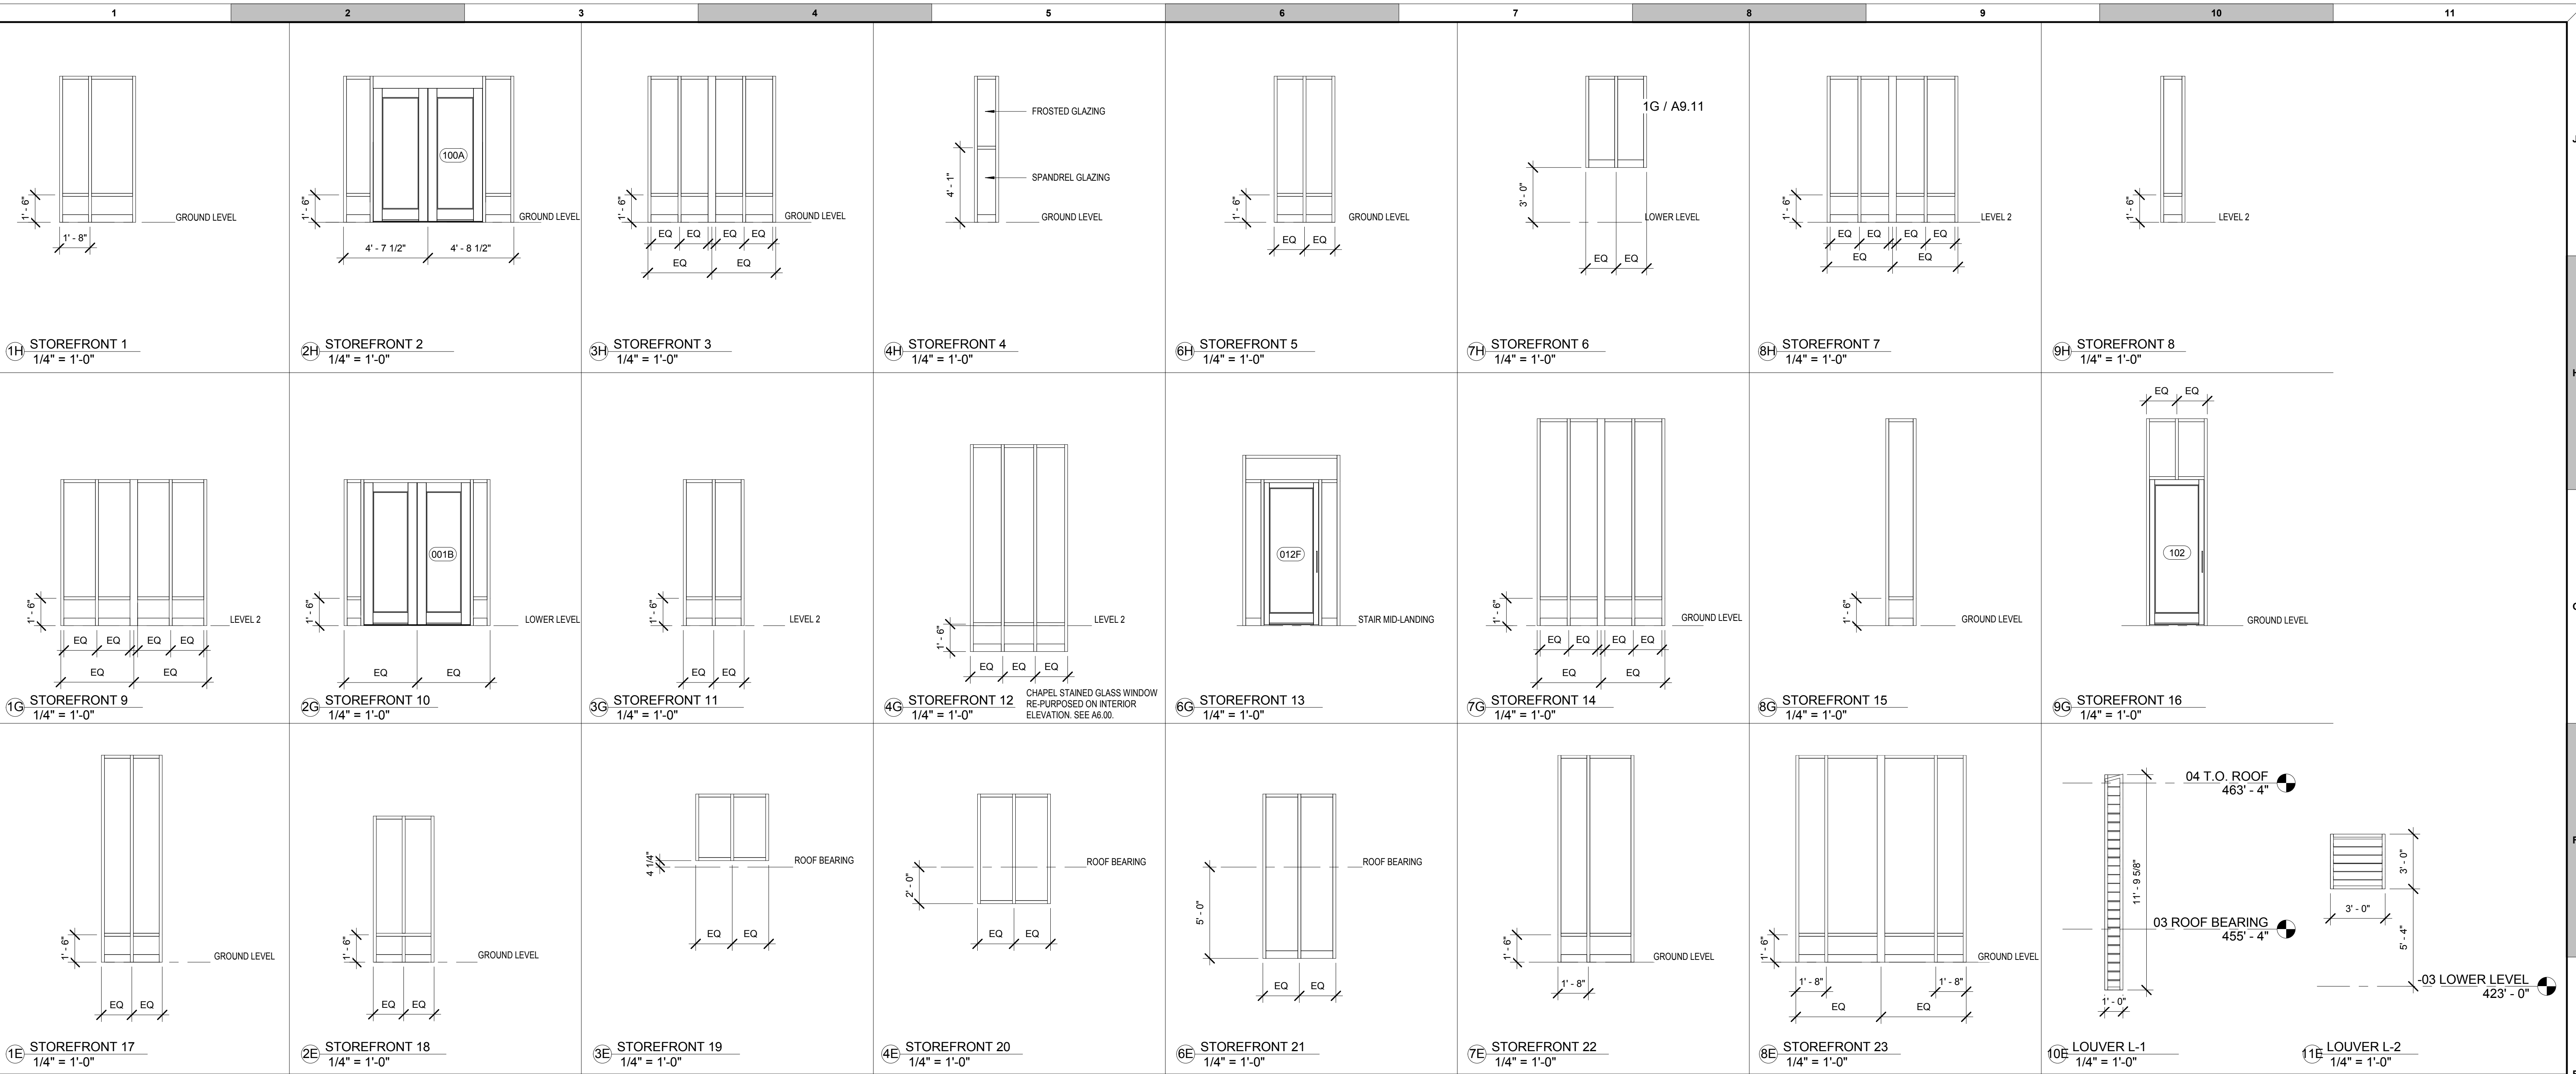
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DOOR & STOREFRONT SCHEDULES & ELEVATIONS

DRAWING NUMBER
A9.00





EXTERIOR STOREFRONT SCHEDULE

MARK	R.O. WIDTH	R.O. HEIGHT	Comments
1	4'-2"	8'-0"	*MULLION DIMENSIONS MIRRORED
2	9'-4"	8'-0"	
3	7'-0"	8'-0"	
4	11'-4"	8'-0"	FROSTED GLAZING
5	3'-4"	8'-0"	
6	3'-4"	5'-0"	
7	7'-2"	8'-0"	
8	1'-4"	8'-0"	
9	8'-0"	8'-0"	
10	8'-0"	8'-0"	
11	3'-4"	8'-0"	
12	5'-4"	11'-4"	
13	5'-4"	9'-4"	
14	7'-0"	11'-4"	
15	1'-8"	11'-4"	
16	3'-4"	11'-4"	
17	3'-4"	11'-4"	
18	3'-4"	8'-0"	
19	4'-0"	3'-7 3/4"	
20	4'-0"	6'-0"	
21	4'-0"	9'-0"	
22	4'-2"	11'-4"	*MULLION DIMENSIONS MIRRORED
23	9'-4"	11'-4"	
L2	3'-0"	3'-0"	

DOOR AND FRAME SCHEDULE

NUMBER	DOOR				FRAME				FIRE RATING	Hardware	Comments		
	SIZE	Type	Material	Finish	Type	Material	Finish	DETAIL					
000	5'-0"	7'-2"	5	HM	PT	2	HM	PT	J2	H2	45 MIN	14	
000B	5'-0"	7'-2"	5	HM	PT	2	HM	PT	J2	H2	45 MIN	14	
001	6'-0"	7'-10"	4	HM	PT	2	HM	PT	J2	H2		5	
001B	5'-10"	7'-10"	3	AL/GL	FAC. F		AL	FAC. F	SF	SF		1	CARD READER. DOOR POSITION SWITCH.
001S	3'-0"	7'-10"	1	WD	CHERRY, STAINED	1	HM	PT	J3	H3	45 MIN	4A	MAGNETIC HOLD OPEN
002	3'-0"	7'-0"	1	HM	PT	2	HM	PT	J2	H2		6	
003	3'-0"	7'-0"	1	HM	PT	2	HM	PT	J2	H2		6	
004	6'-0"	7'-10"	3	WD/GL	CHERRY, STAINED	1	WD	CHERRY, STAINED	J1	H1		13	
005	3'-0"	7'-0"	1	WD	CHERRY, STAINED	2	WD	CHERRY, STAINED	J1	H1		12	
006	3'-0"	7'-0"	1	WD	CHERRY, STAINED	2	WD	CHERRY, STAINED	J1	H1		12	
007	3'-0"	7'-10"	2	WD/GL	CHERRY, STAINED	1	WD	CHERRY, STAINED	J1	H1		9	
007A	3'-0"	7'-10"	2	WD/GL	CHERRY, STAINED	2	WD	CHERRY, STAINED	J1	H1		8	
007B	3'-0"	7'-10"	2	WD/GL	CHERRY, STAINED	2	WD	CHERRY, STAINED	J1	H1		8	
007C	3'-0"	7'-10"	2	WD/GL	CHERRY, STAINED	2	WD	CHERRY, STAINED	J1	H1		8	
007D	3'-0"	7'-10"	2	WD/GL	CHERRY, STAINED	2	WD	CHERRY, STAINED	J1	H1		8	
0102F	3'-0"	7'-10"	2	AL/GL	FAC. F		AL	FAC. F	SF	SF		1	EXTERIOR STAIR DOOR. CARD READER. DOOR POSITION SWITCH.
100A	6'-0"	7'-4"	3	WD/GL	CHERRY, STAINED	SEE SF ELEVATION	AL	FAC. F	SF	SF		1	CARD READER
100B	5'-10"	7'-4"	3	WD/GL	CHERRY, STAINED	SEE SF ELEVATION	AL	FAC. F	SF	SF		3	
101S	6'-0"	7'-10"	4	WD	CHERRY, STAINED	1	HM	PT	A6.00		45 MIN	4	MAGNETIC HOLD OPEN, POCKET PIVOT HINGE - SEE A6.00 FOR DETAIL
102	3'-0"	8'-0"	2	AL/GL	CHERRY, STAINED	SEE SF ELEVATION	AL	FAC. F	SF	SF		2	
103	4'-0"	8'-0"	1	WD	CHERRY, STAINED	QUST. DETAIL	WD	CHERRY, STAINED	J1	H1		11	SLIDING DOOR IN POCKET
104A	6'-0"	7'-10"	4	WD/GL	CHERRY, STAINED	3	WD	CHERRY, STAINED	J1	H1		13	
104B	3'-11"	8'-0"	2	WD/GL	CHERRY, STAINED	2	WD	CHERRY, STAINED	J1	H1		11	
105	3'-0"	7'-10"	1	WD	CHERRY, STAINED	2	WD	CHERRY, STAINED	J1	H1		12	
106	3'-0"	7'-10"	1	WD	CHERRY, STAINED	2	WD	CHERRY, STAINED	J1	H1		12	
107	3'-0"	7'-10"	2	WD/GL	CHERRY, STAINED	2	WD	CHERRY, STAINED	J1	H1		10	
107A	3'-0"	7'-10"	2	WD/GL	CHERRY, STAINED	2	WD	CHERRY, STAINED	J1	H1		8	
107B	3'-0"	7'-10"	2	WD/GL	CHERRY, STAINED	2	WD	CHERRY, STAINED	J1	H1		8	
201S	3'-0"	7'-10"	2	WD/GL	CHERRY, STAINED	1	HM	PT	J3	H3	45 MIN	4A	MAGNETIC HOLD OPEN
202	3'-0"	7'-10"	2	WD/GL	CHERRY, STAINED	2	WD	CHERRY, STAINED	J1	H1		10	
202A	3'-0"	7'-10"	2	WD/GL	CHERRY, STAINED	2	WD	CHERRY, STAINED	J1	H1		11	
202B	3'-0"	7'-10"	2	WD/GL	CHERRY, STAINED	2	WD	CHERRY, STAINED	J1	H1		11	
202C	3'-0"	7'-10"	2	WD/GL	CHERRY, STAINED	2	WD	CHERRY, STAINED	J1	H1		11	
202D	3'-0"	7'-10"	2	WD/GL	CHERRY, STAINED	2	WD	CHERRY, STAINED	J1	H1		11	
C100A	3'-0"	7'-0"	2	WD/GL	CHERRY, STAINED	EXISTING FRAME							REPLACEMENT DOOR AT CHAPEL VESTIBULE. VERIFY R.O. IN FIELD
C100B	6'-0"	7'-0"	3	WD/GL	CHERRY, STAINED	EXISTING FRAME							REPLACEMENT DOOR AT CHAPEL VESTIBULE. VERIFY R.O. IN FIELD
C100C	3'-0"	7'-0"	2	WD/GL	CHERRY, STAINED	EXISTING FRAME							REPLACEMENT DOOR AT CHAPEL VESTIBULE. VERIFY R.O. IN FIELD
C101	4'-0"	8'-0"	2	WD/GL	CHERRY, STAINED	4	AL	FAC. F	SF	SF			
C103	3'-0"	7'-0"	1	WD	CHERRY, STAINED	1	WD	CHERRY, STAINED	J1	H1		12	
C105	3'-0"	7'-0"	1	WD	CHERRY, STAINED	1	WD	CHERRY, STAINED	J1	H1		12	
ELEV1	3'-0"	7'-0"	1	HM	PT	1	HM	PT	J2	H2	45 MIN	7	ELEVATOR ACCESS DOOR

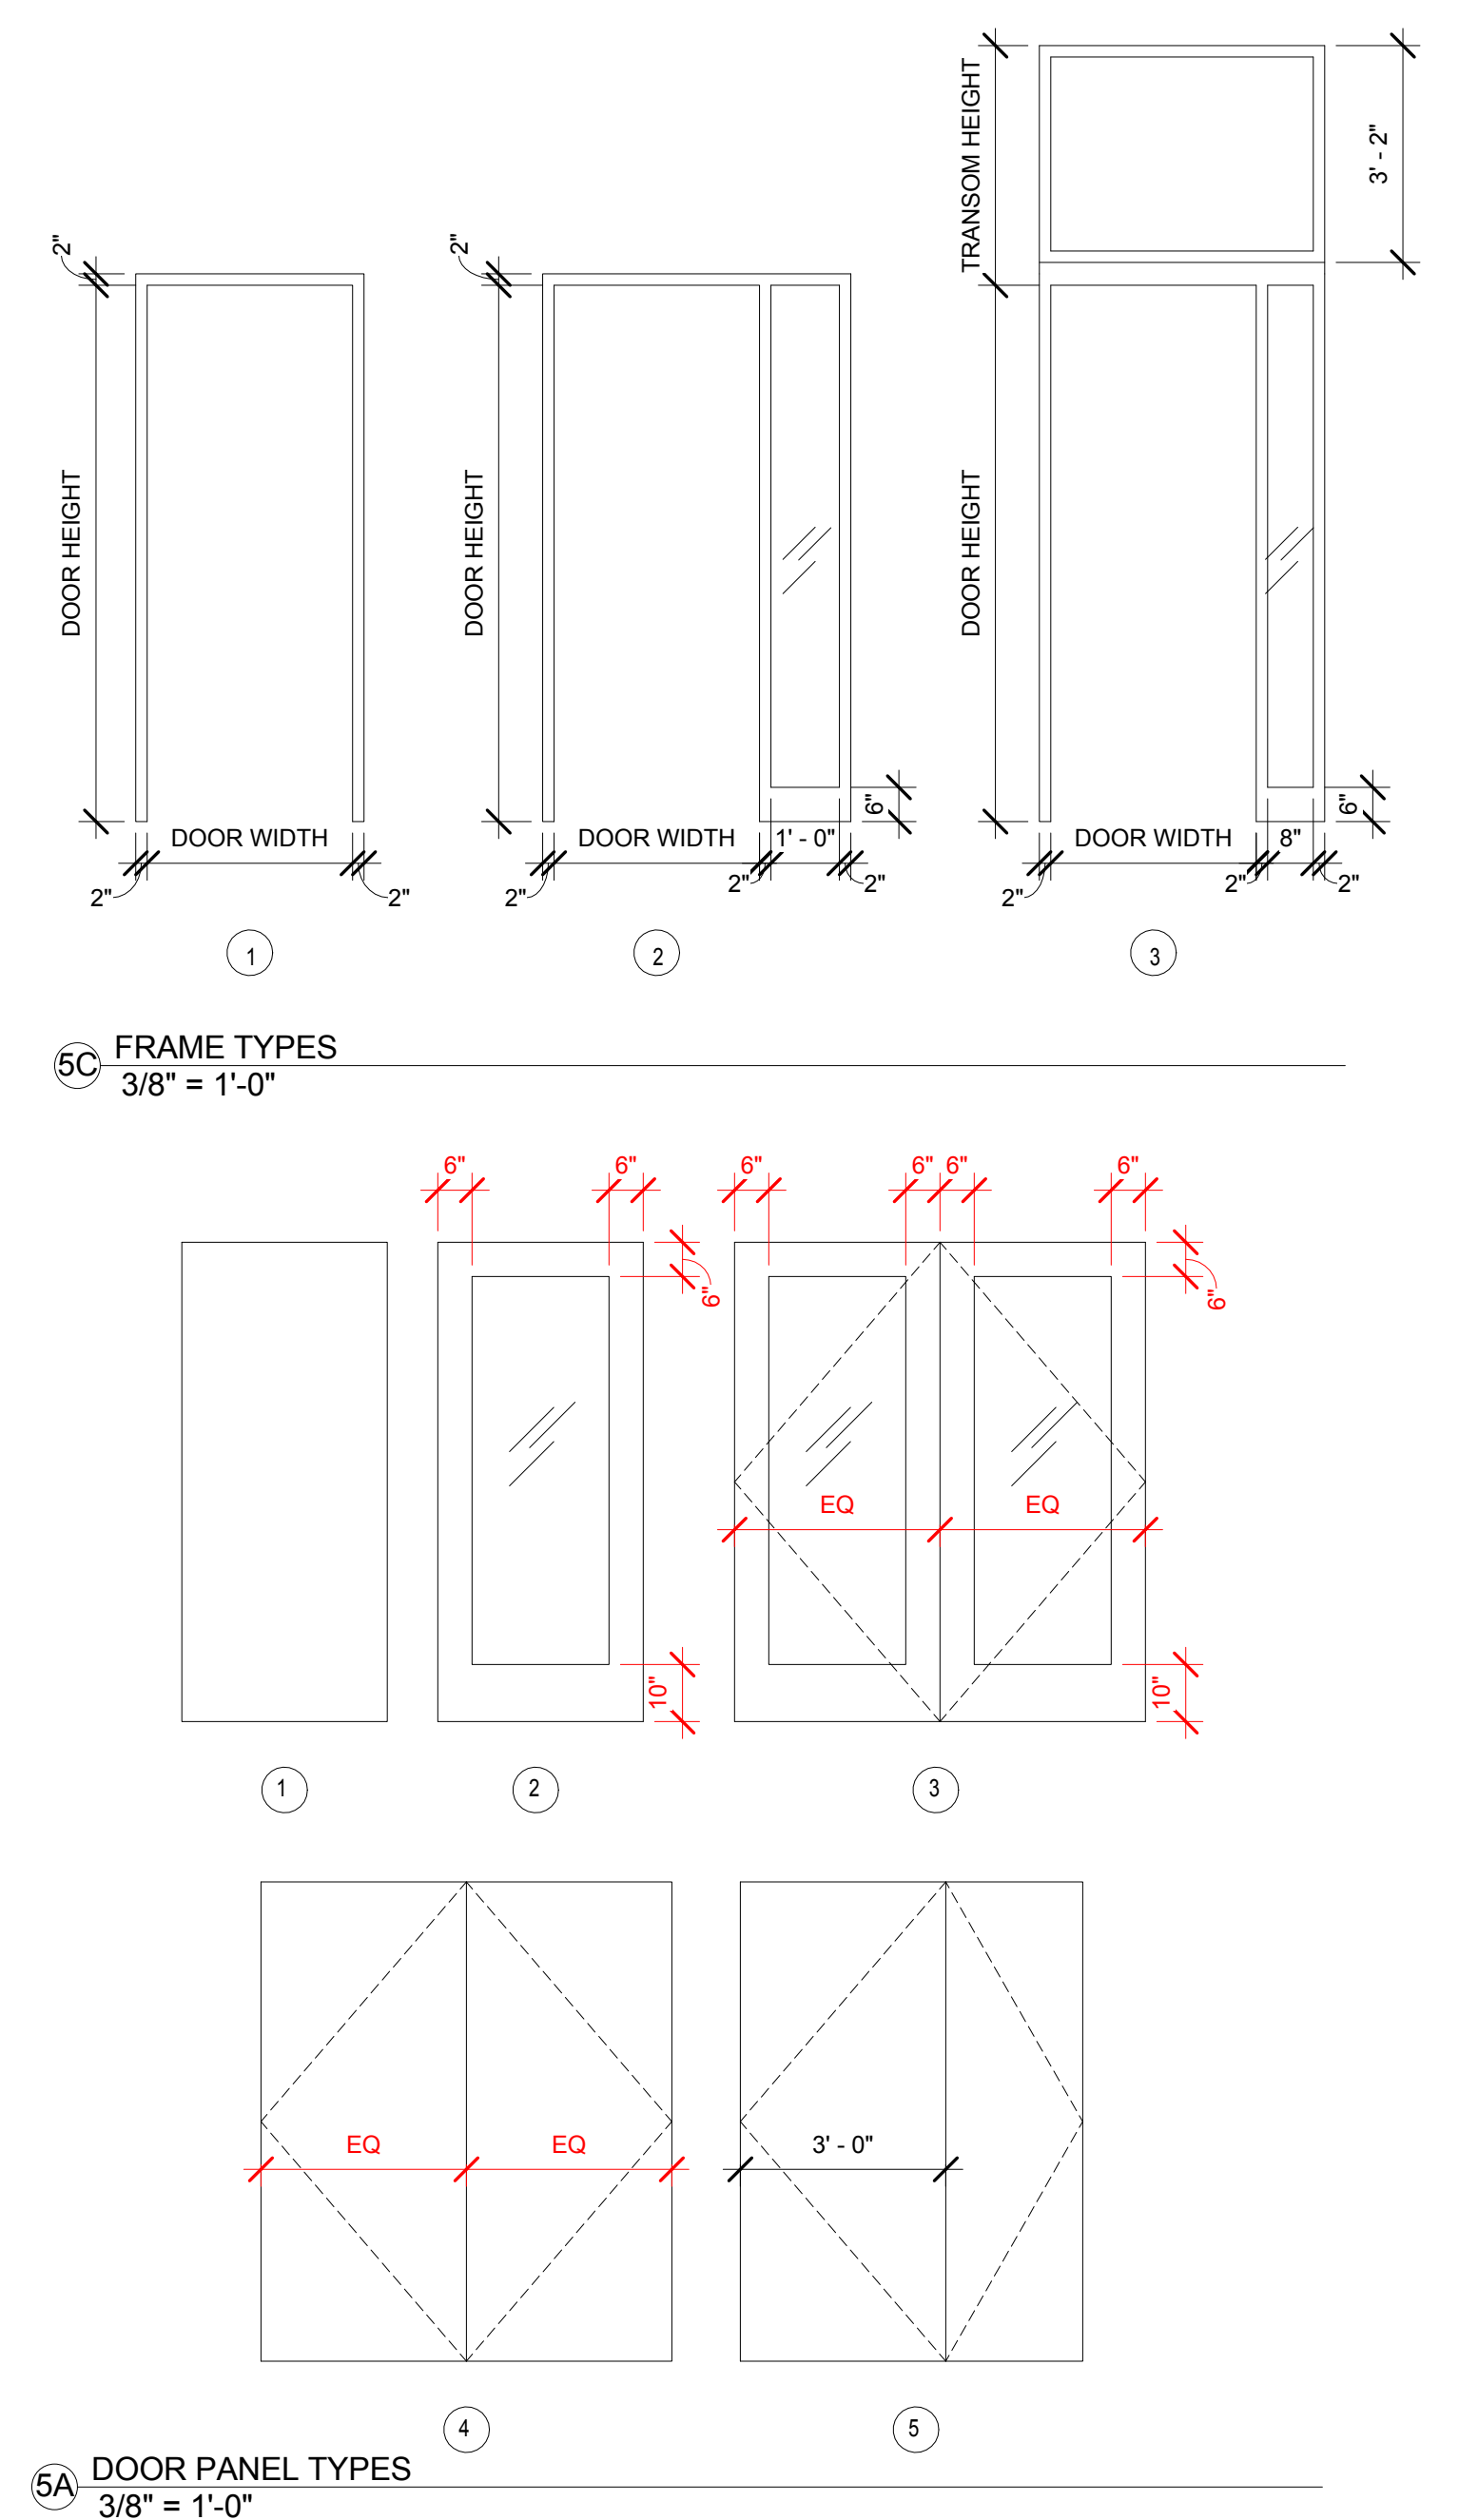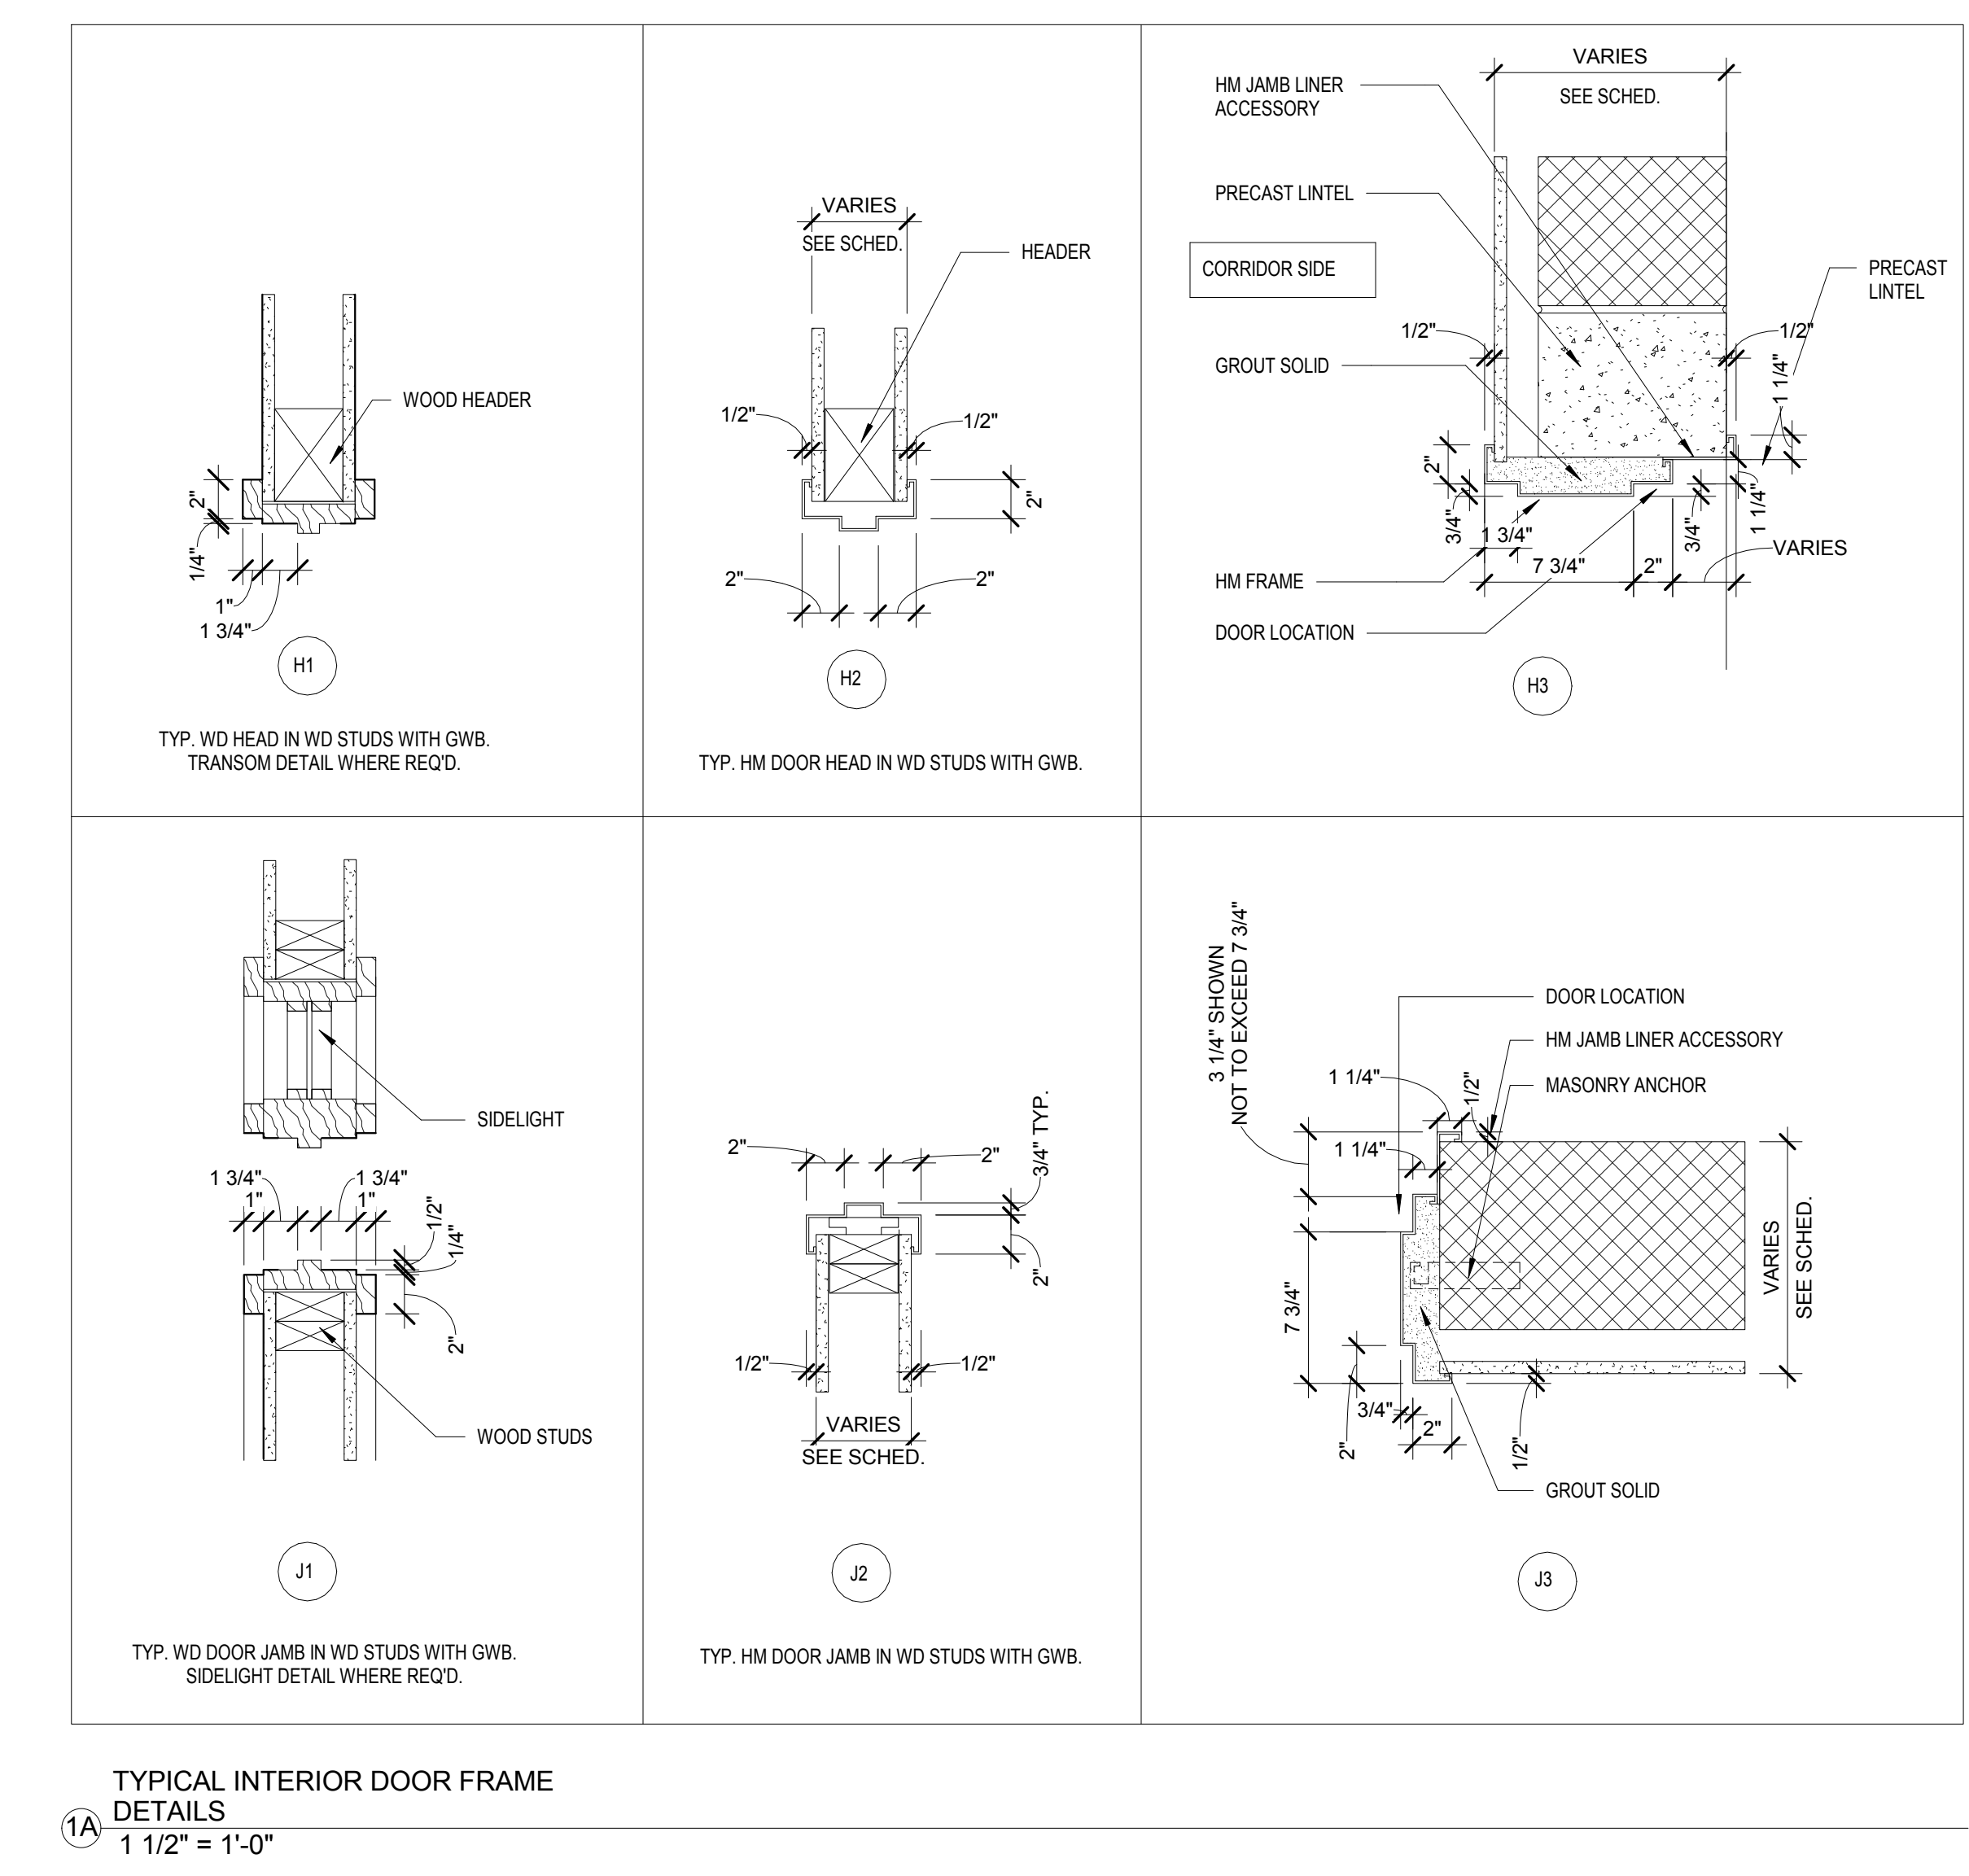

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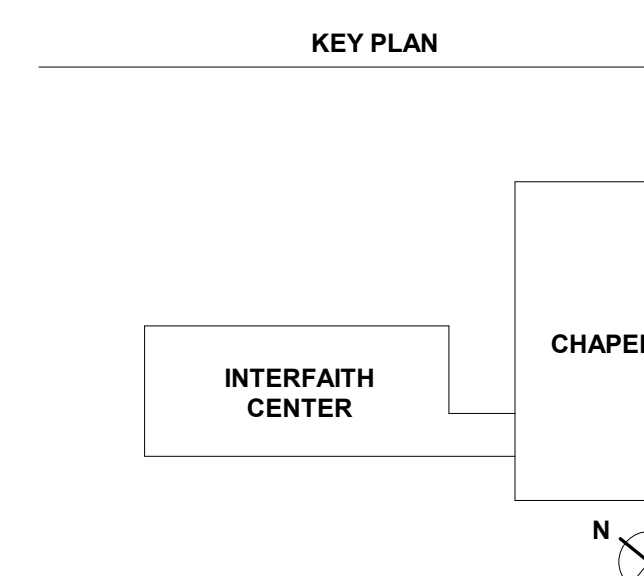
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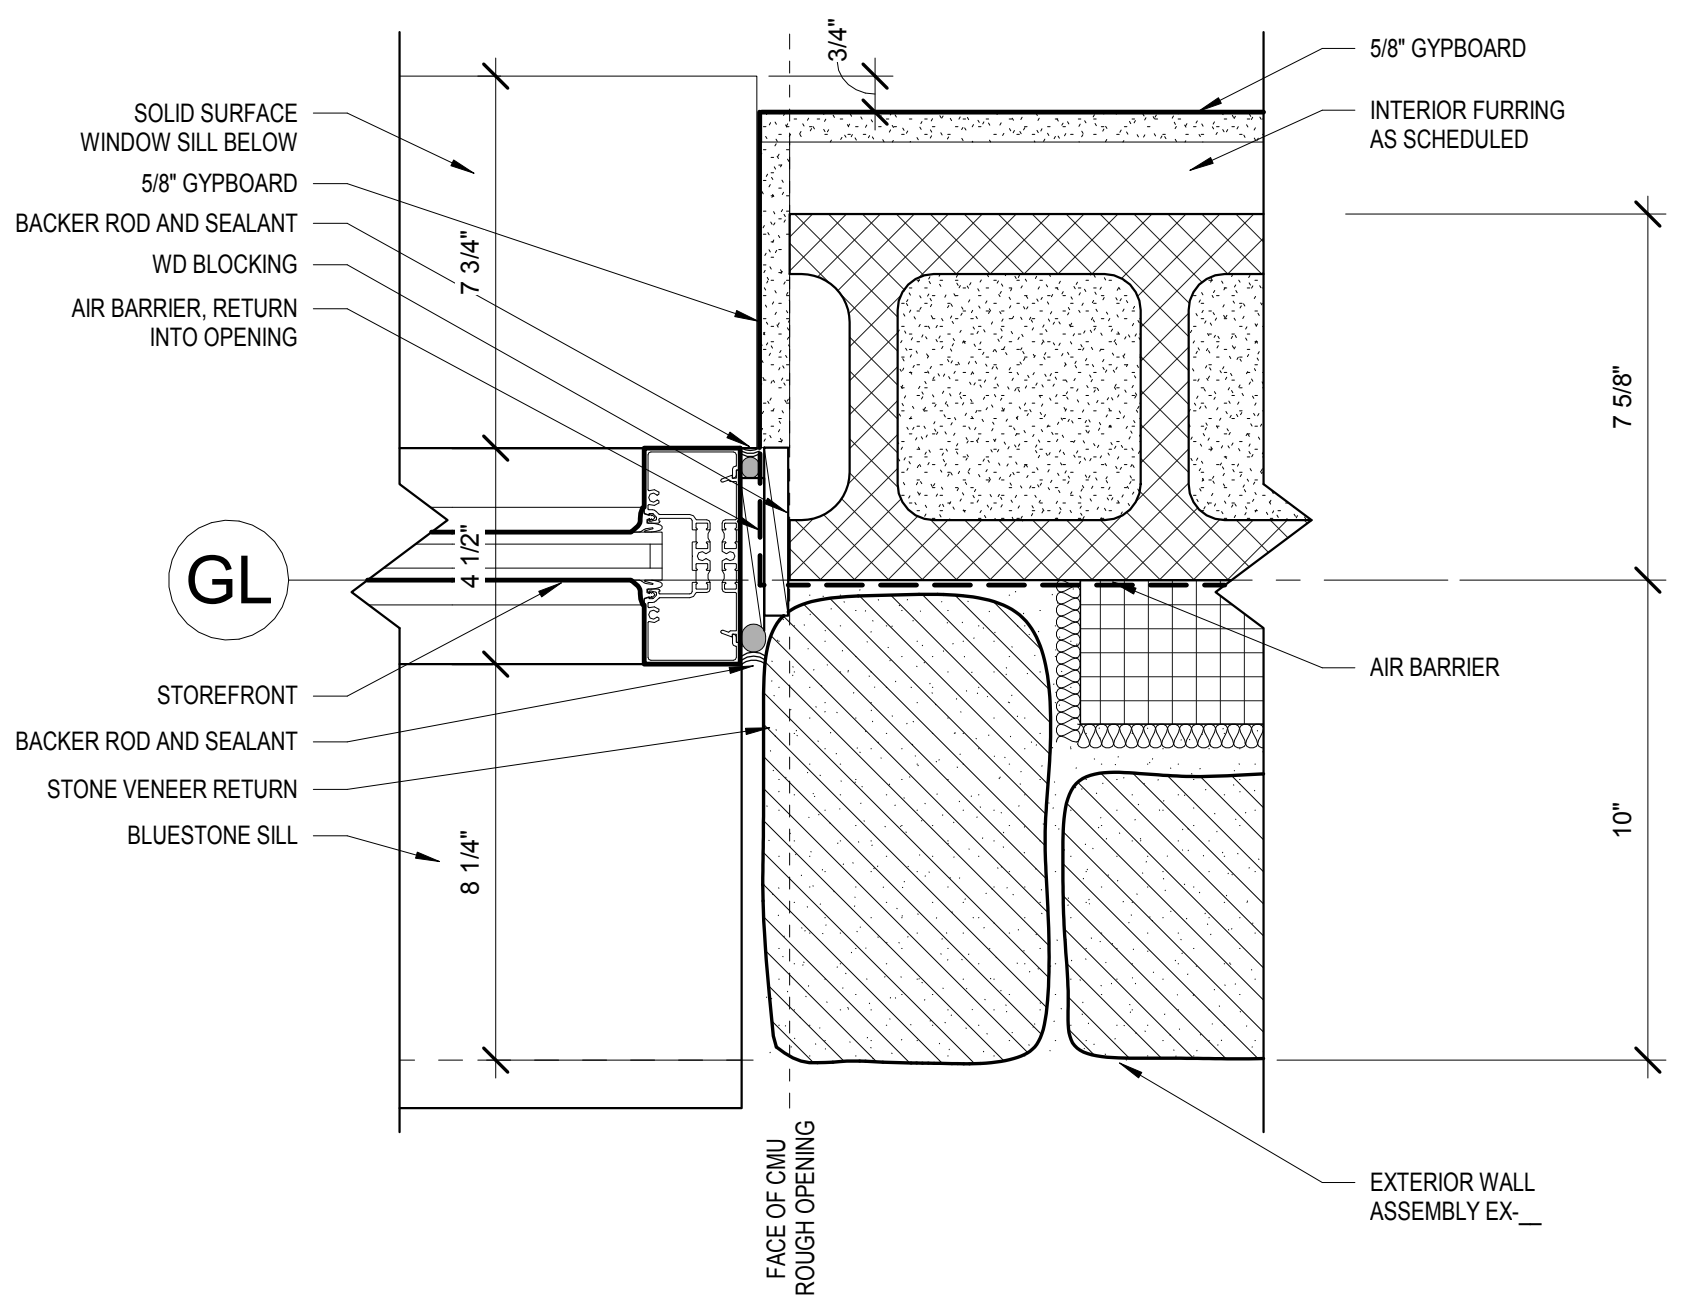
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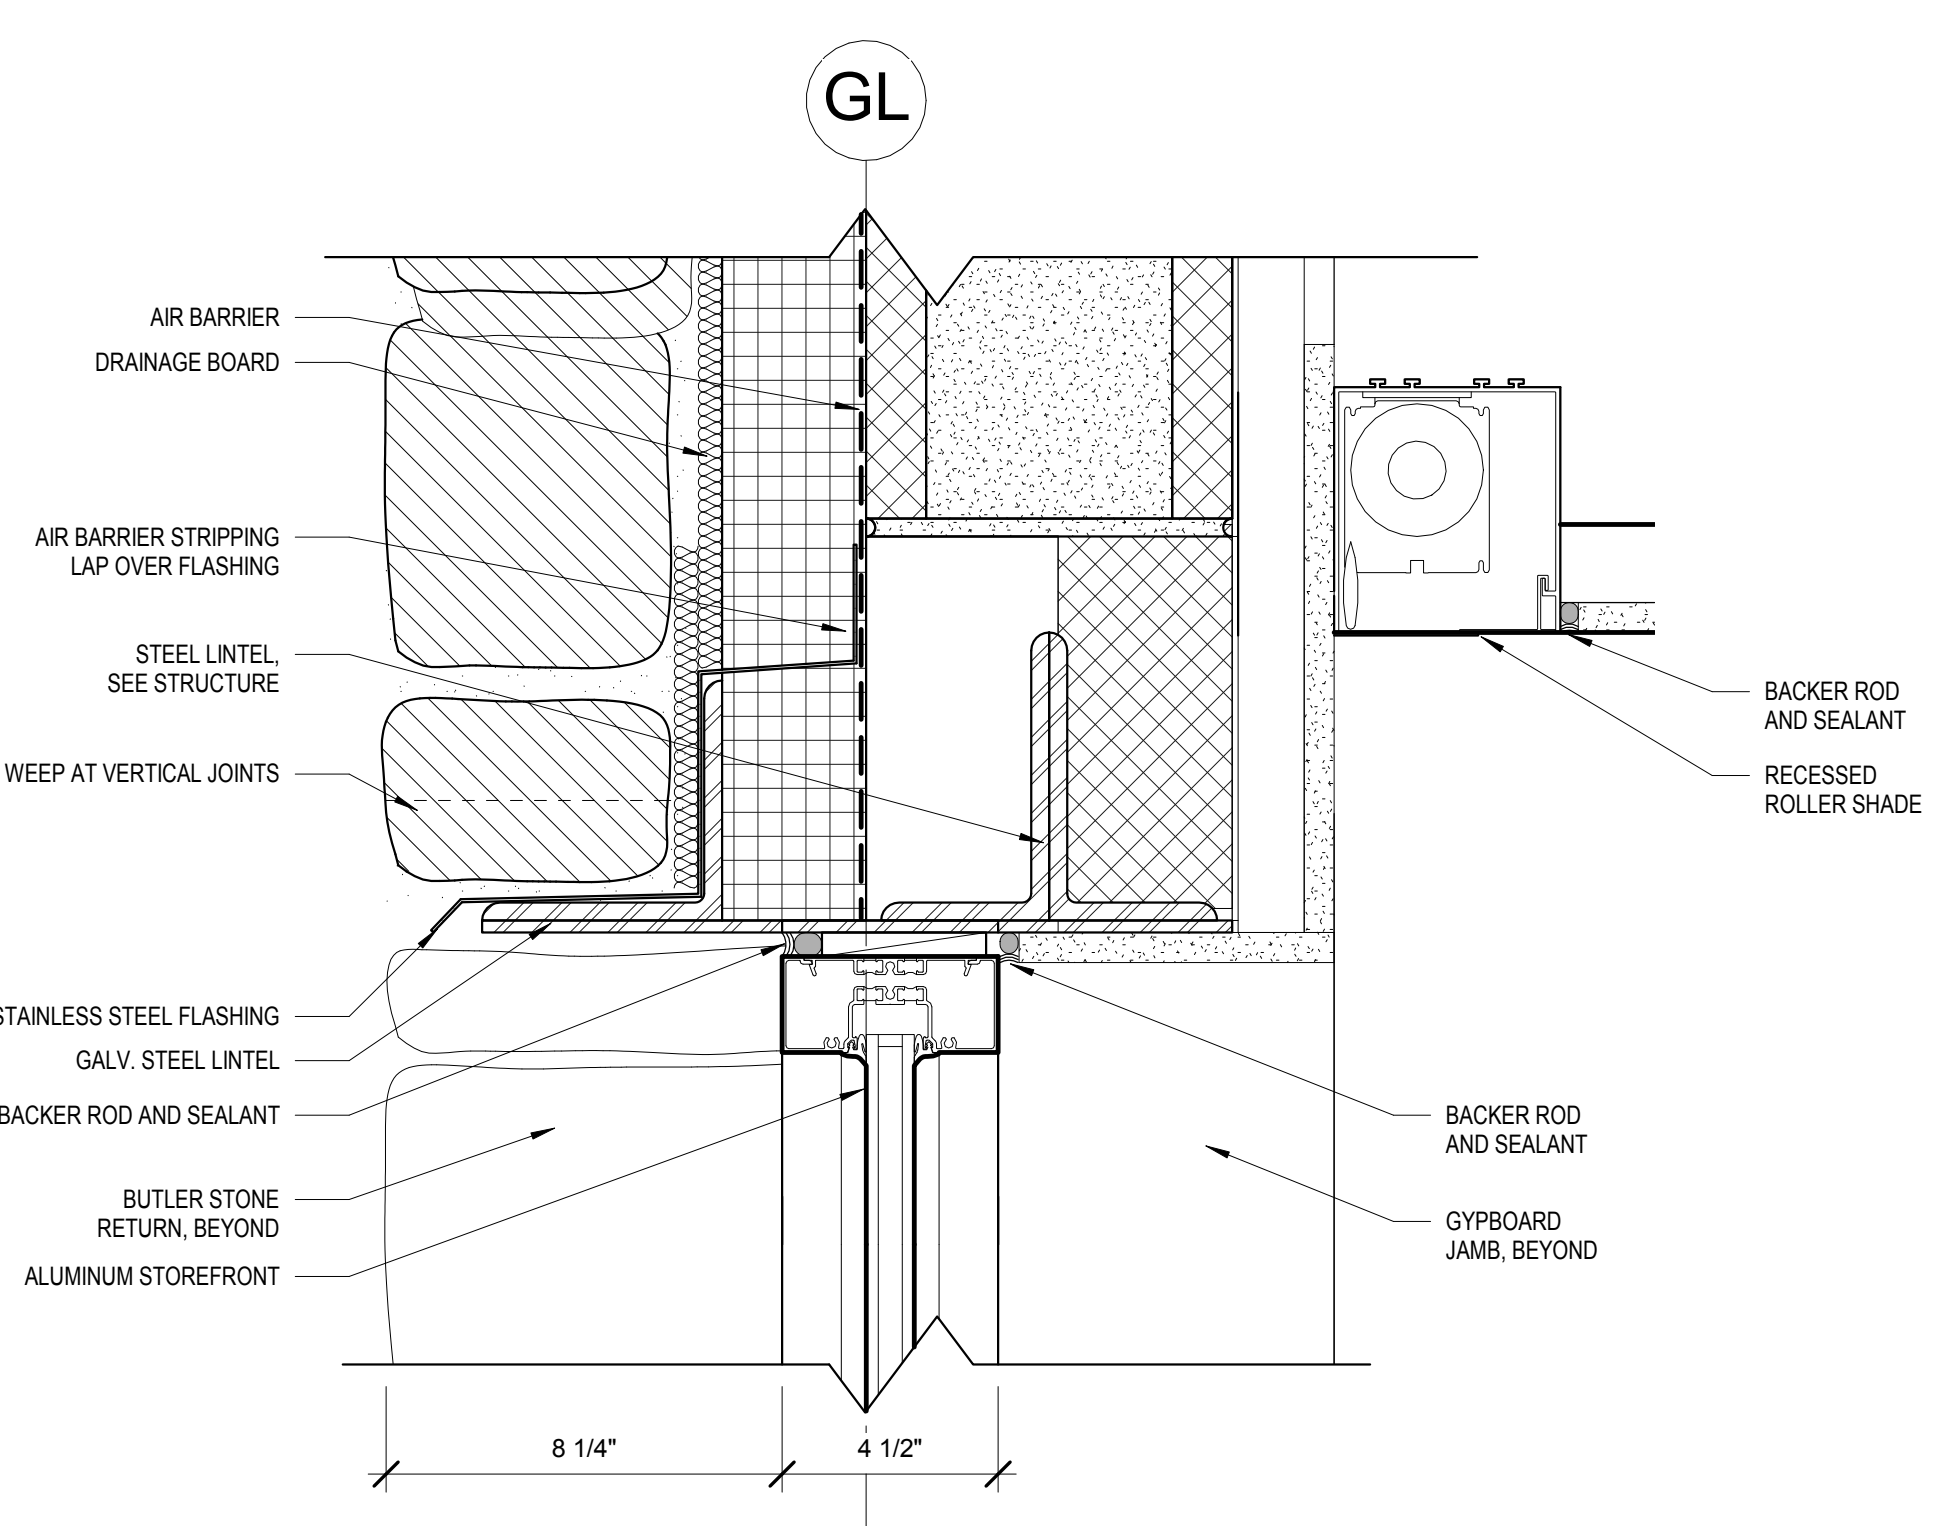
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STOREFRONT DETAILS

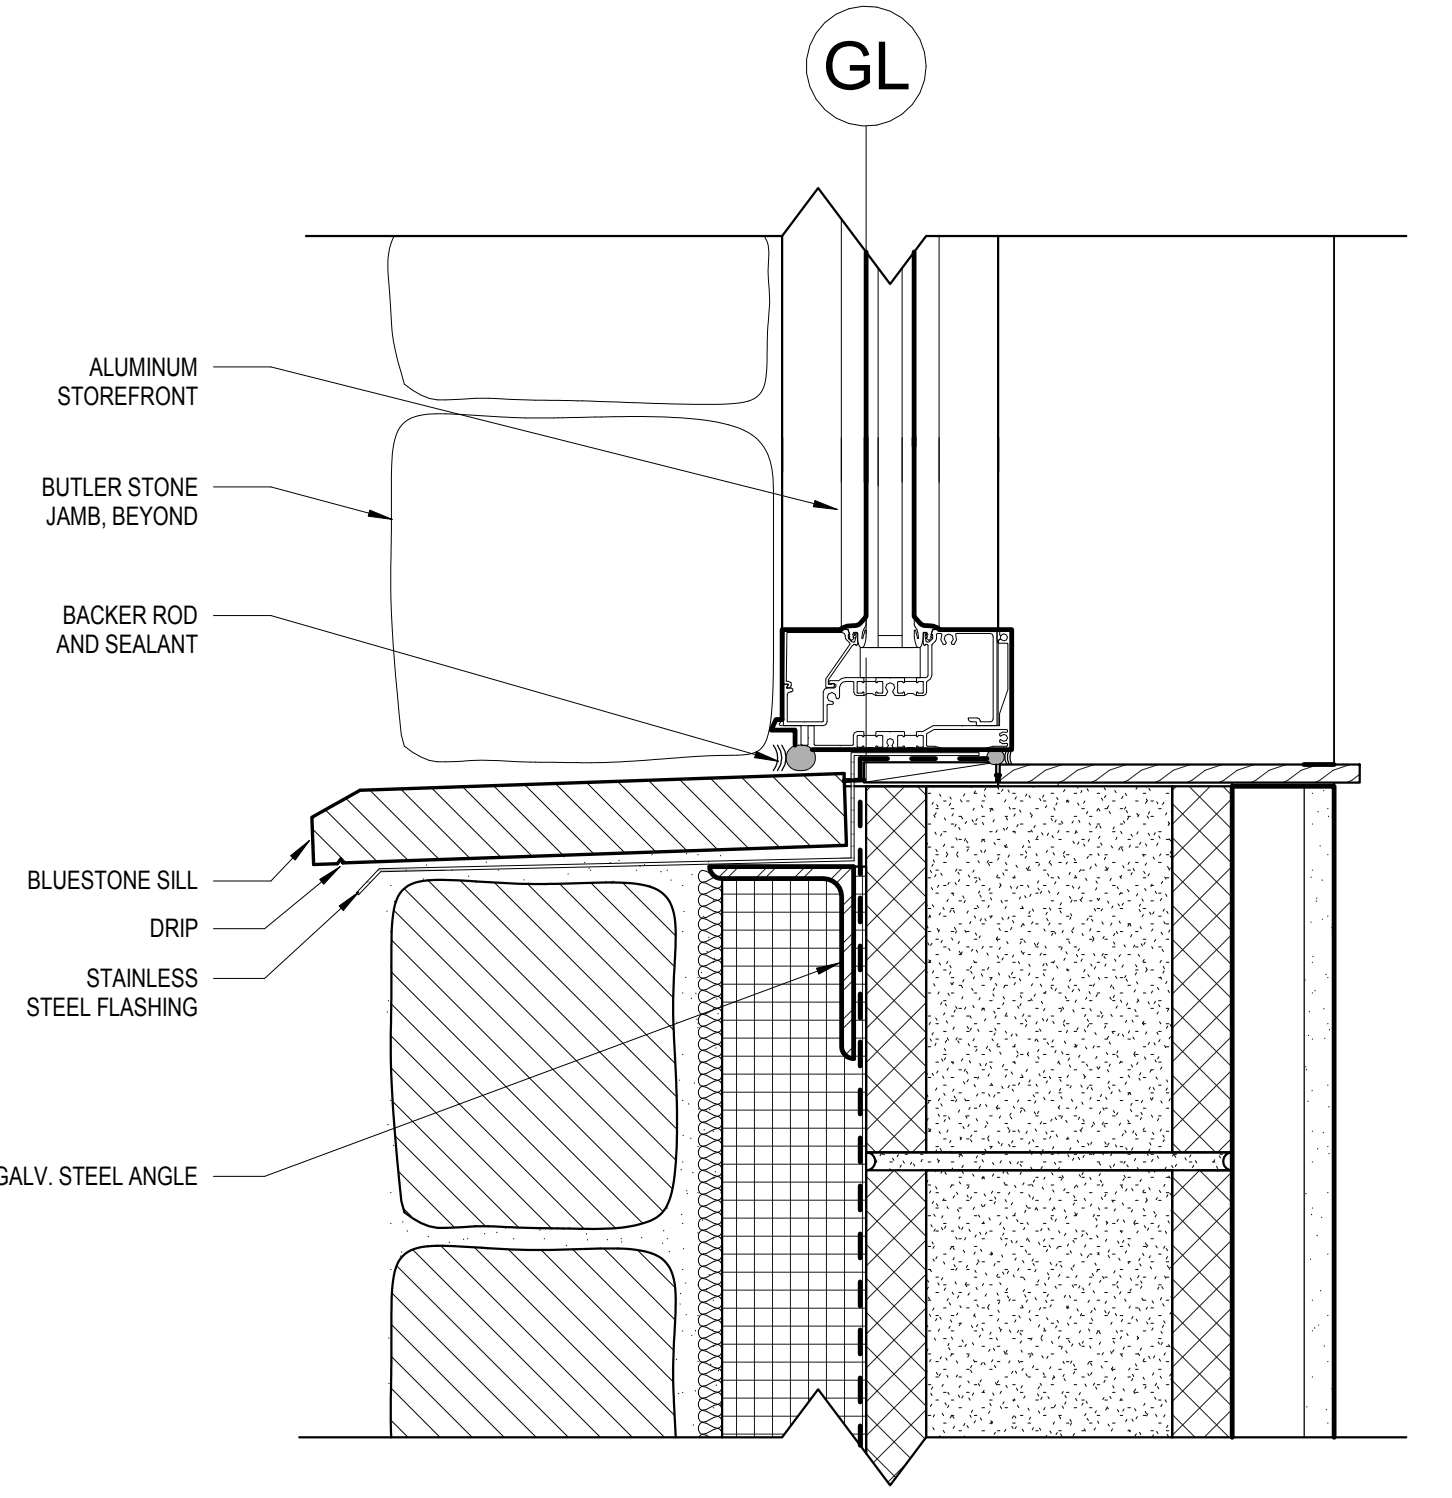
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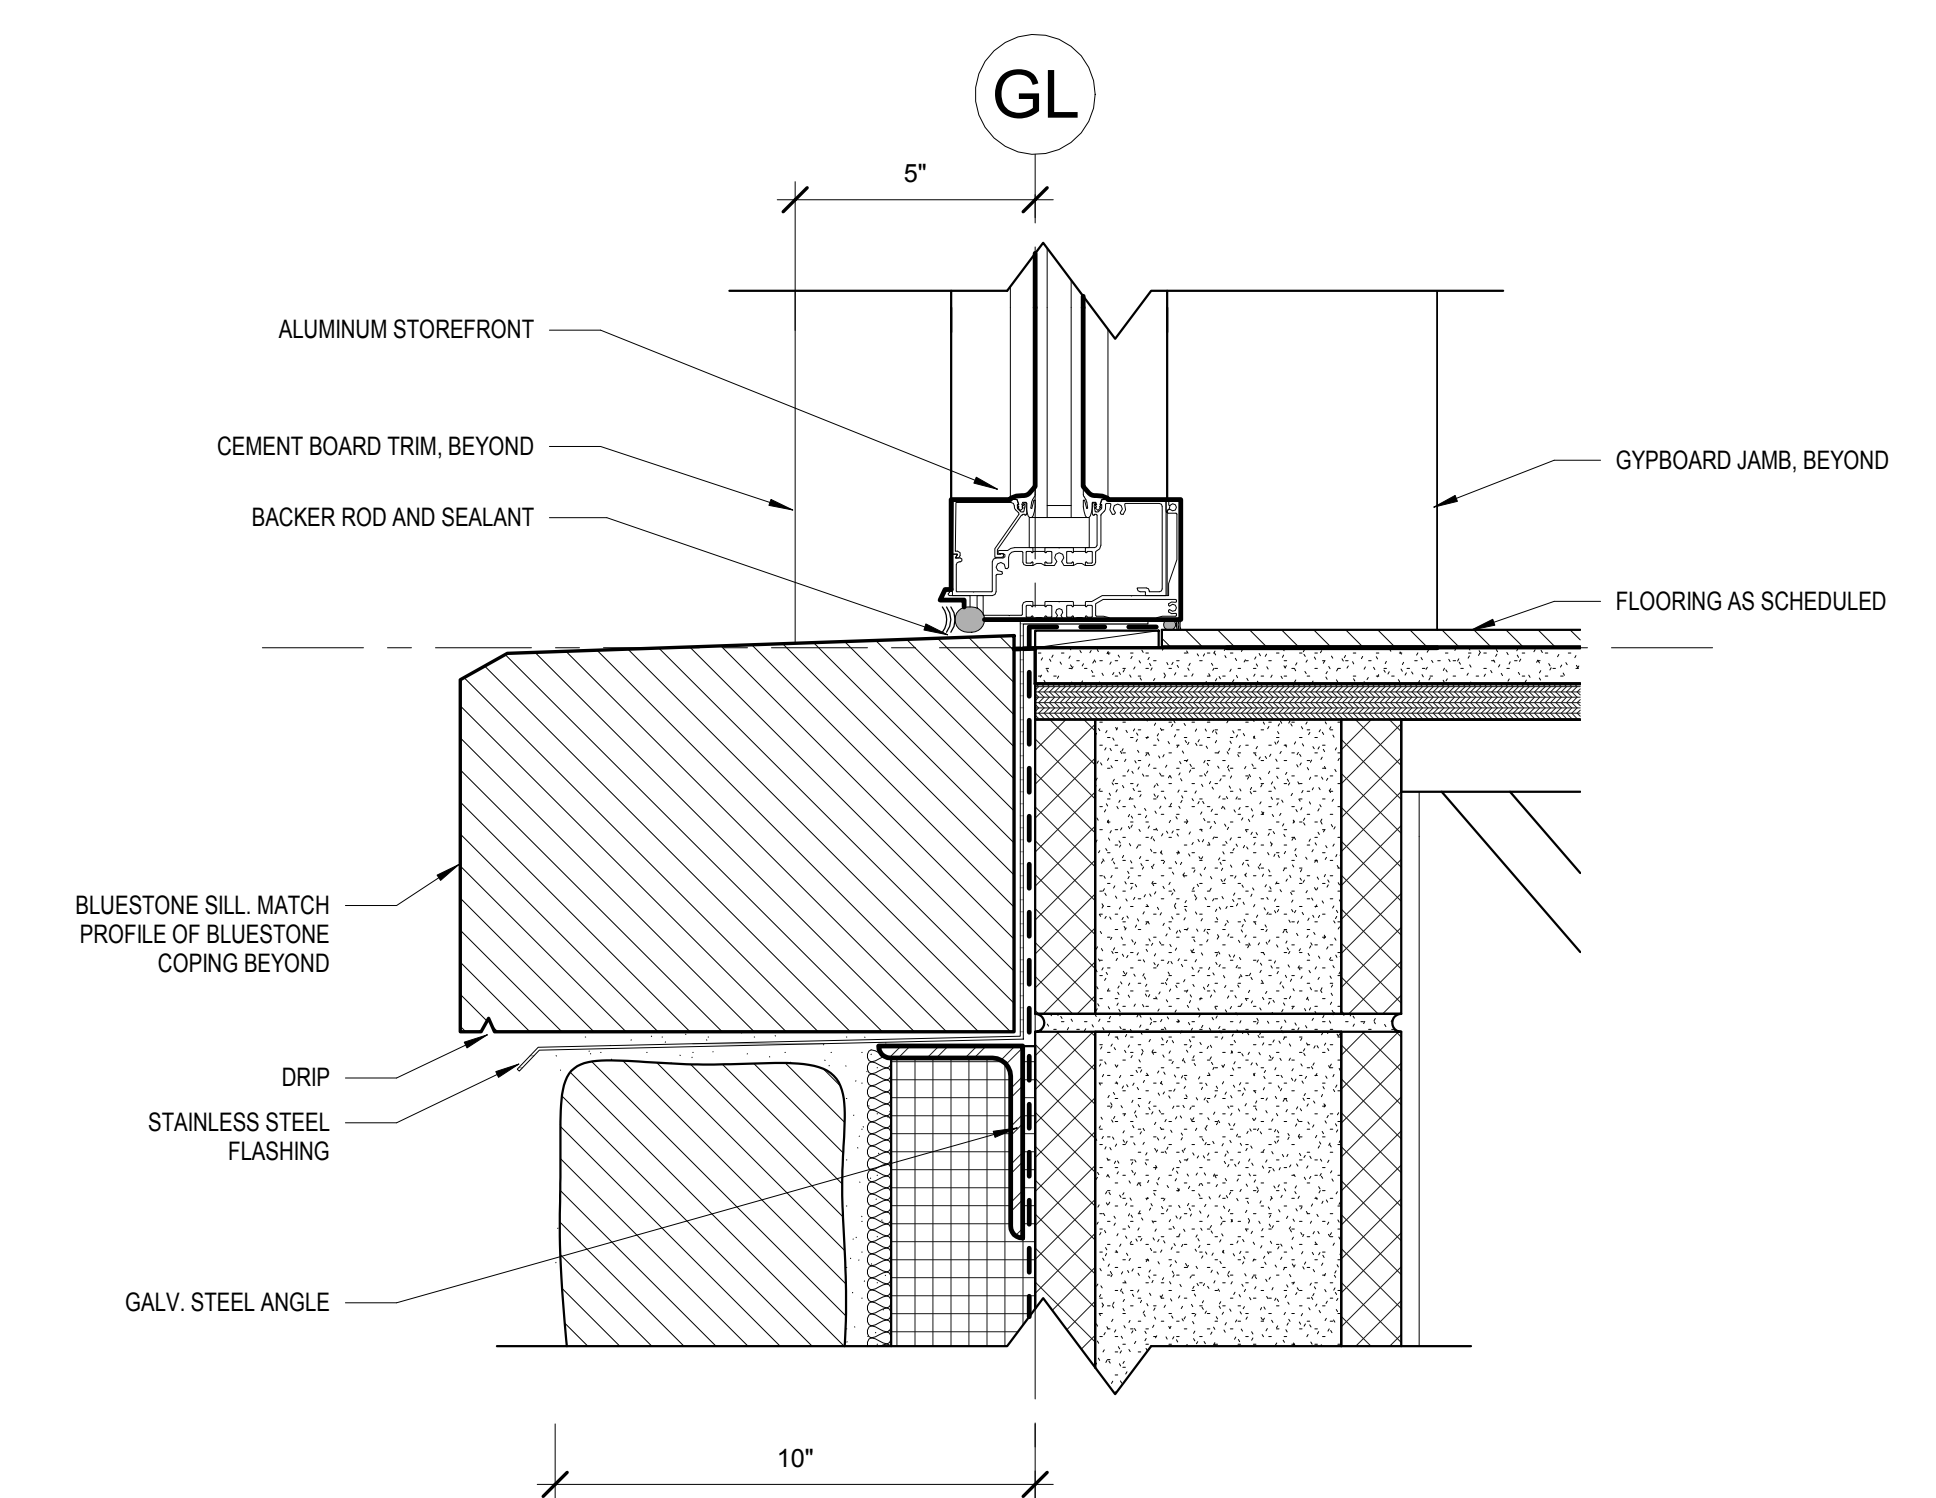
1G TYPICAL STOREFRONT JAMB AT EXTERIOR BUTLER STONE
3" = 1'-0"




1D TYPICAL STOREFRONT HEAD AT BUTLER STONE
3" = 1'-0"




1A TYPICAL STOREFRONT SILL AT BUTLER STONE
3" = 1'-0"



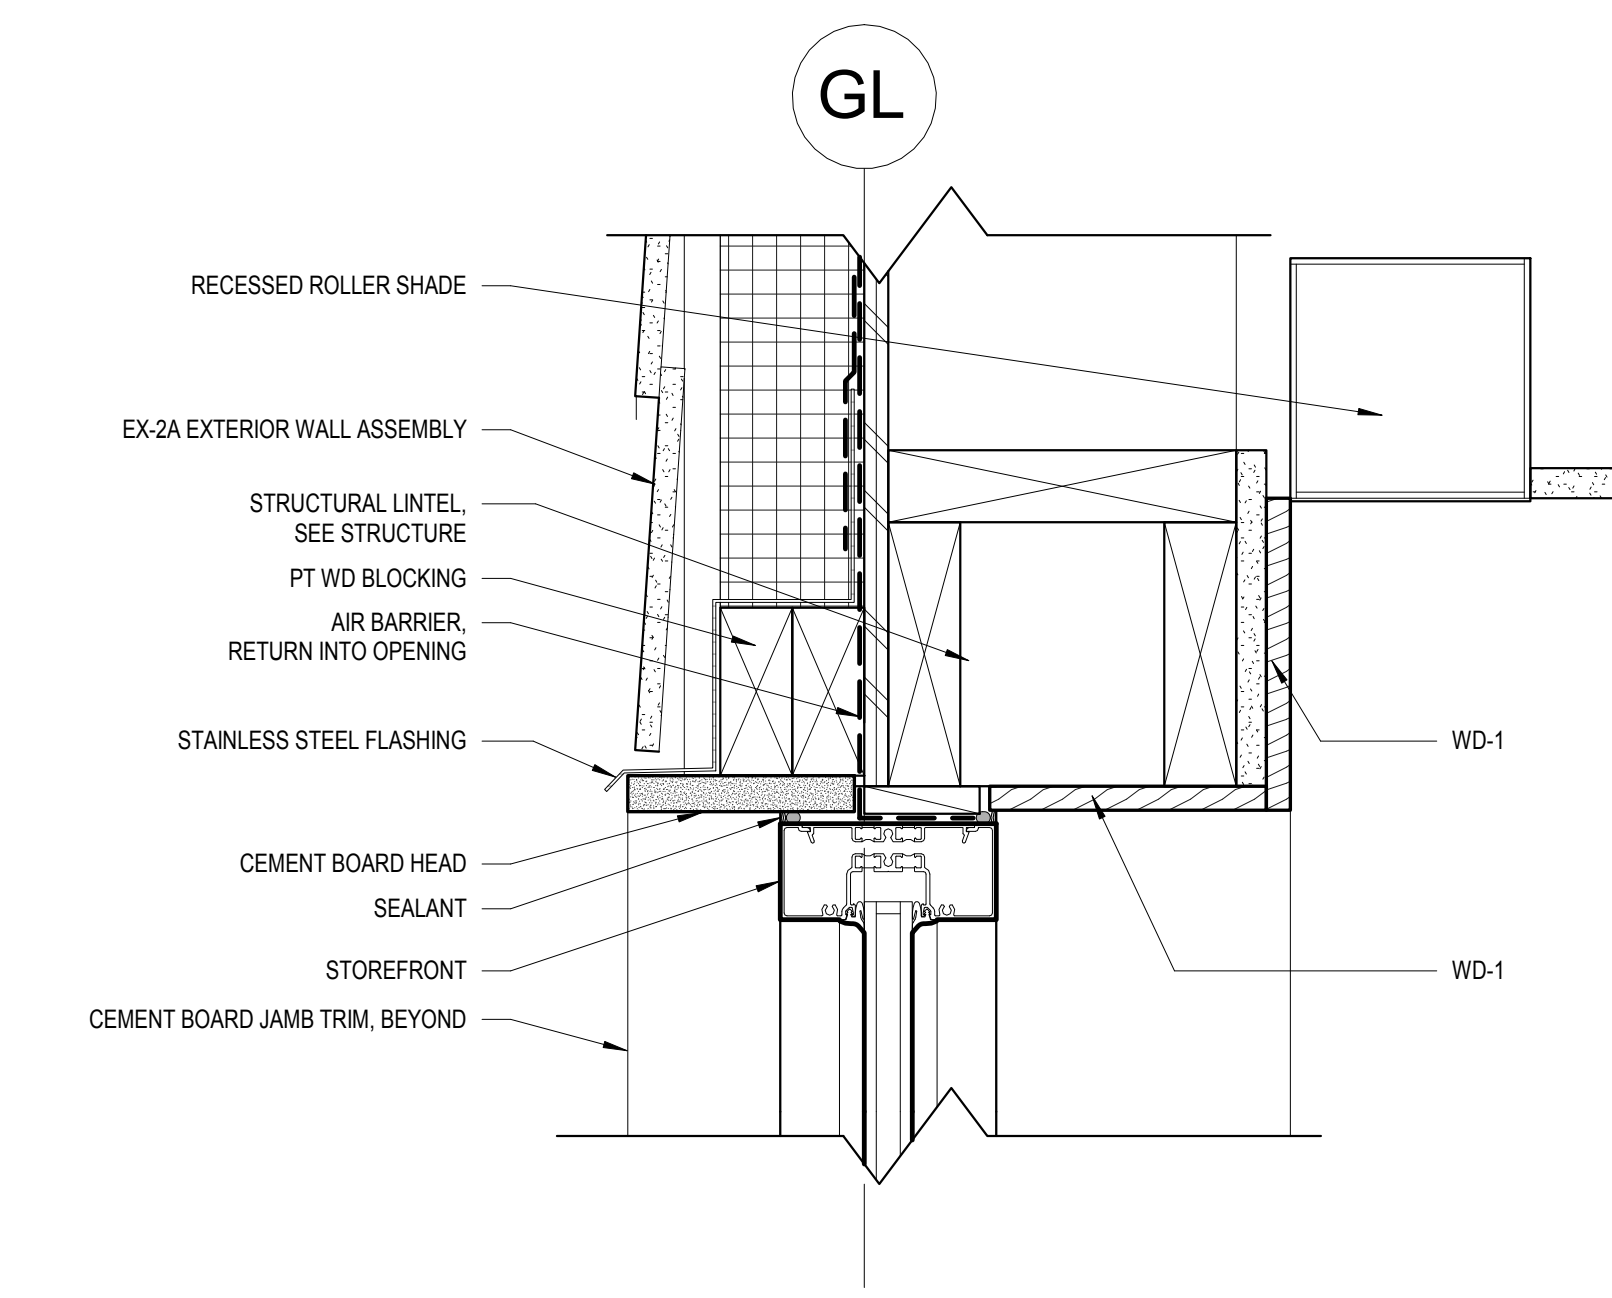
3 TYPICAL STOREFRONT SILL AT BUTLER STONE WITH BLUESTONE COPING
3" = 1'-0"



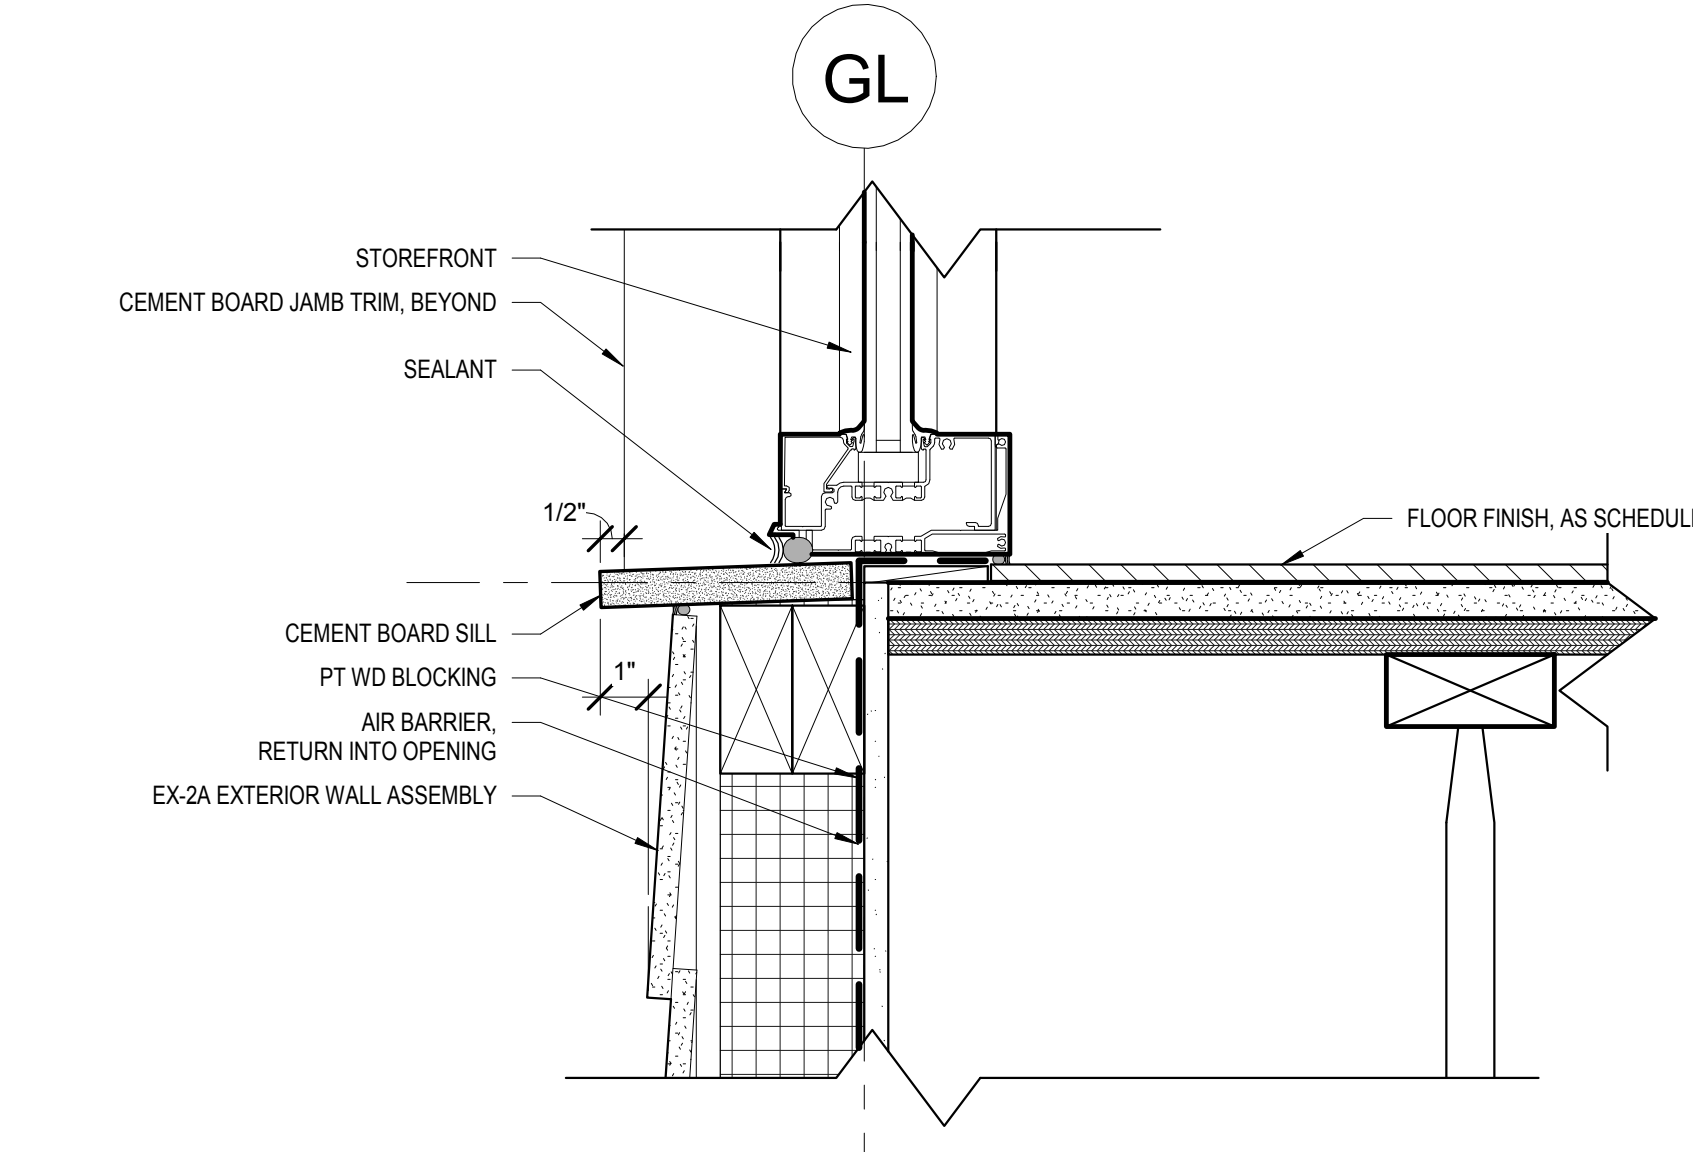8 TYPICAL STOREFRONT HEAD AT CEMENT BOARD SIDING
3" = 1'-0"



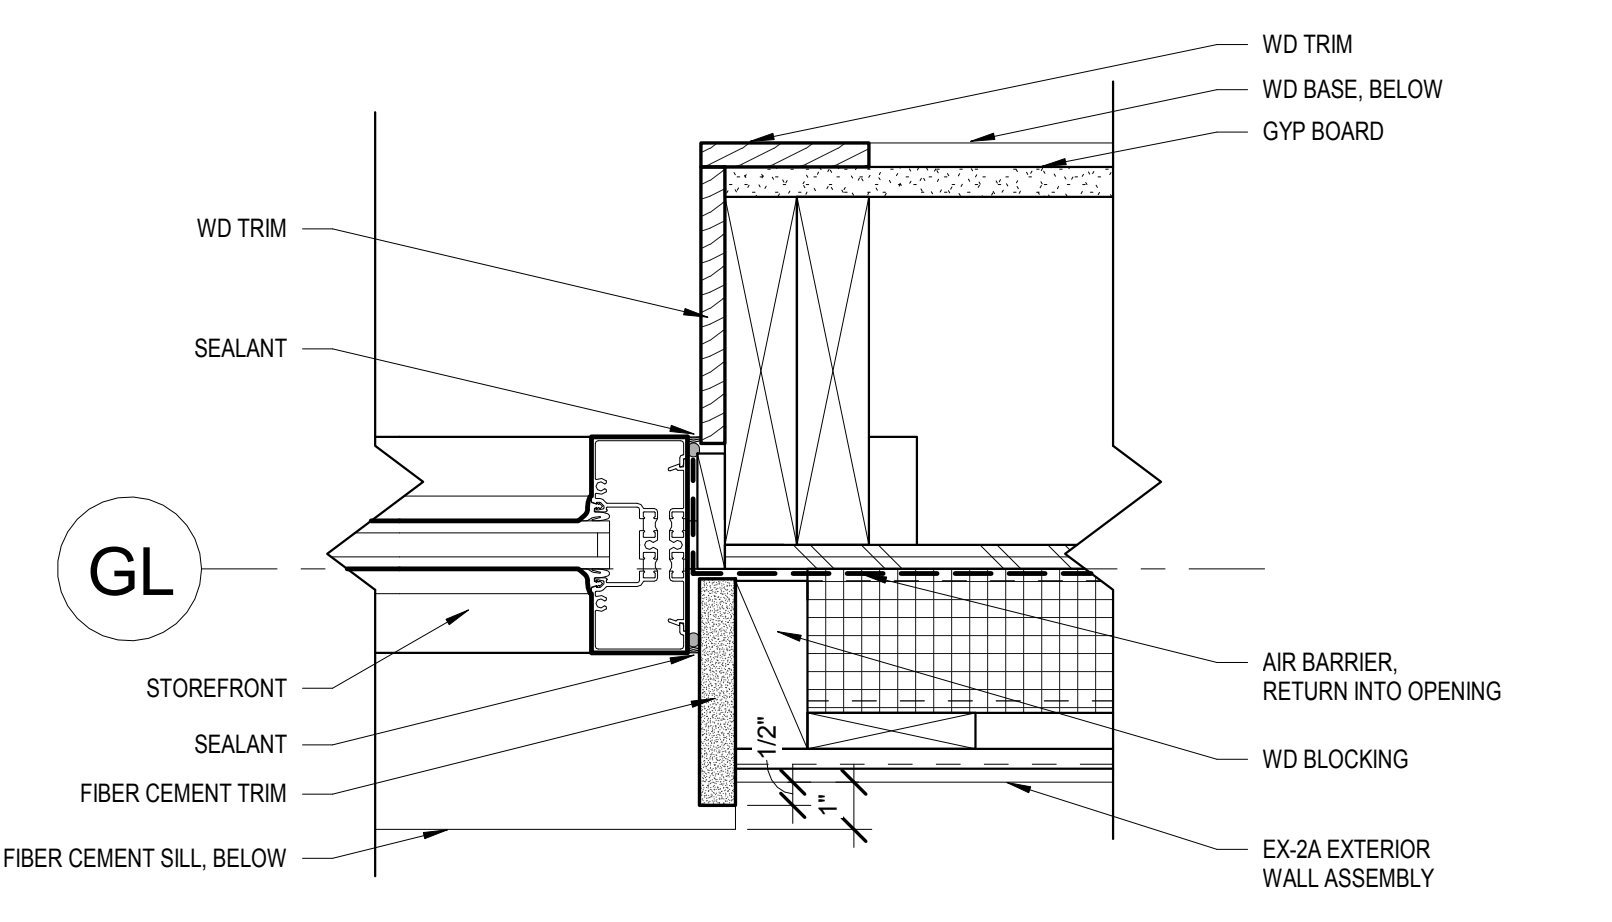2 TYPICAL STOREFRONT SILL AT CEMENT BOARD SIDING
3" = 1'-0"




4 TYPICAL STOREFRONT JAMB AT CEMENT BOARD SIDING
3" = 1'-0"

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PARTITION TYPES


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NOTES:
1. PARTITIONS ARE DISTINGUISHED ON FLOOR PLANS BY SYMBOL, GRAPHIC DESIGNATION, OR A COMBINATION OF BOTH.
2. THE GRAPHIC SYMBOL DESIGNATION HAS THREE BASE CHARACTERS, AND IN SOME CASES A MODIFIER. PARTITION TYPE LABELS GENERALLY FOLLOW THE FORMAT ILLUSTRATED BELOW, UNLESS OTHERWISE NOTED IN PARTITION SCHEDULE.

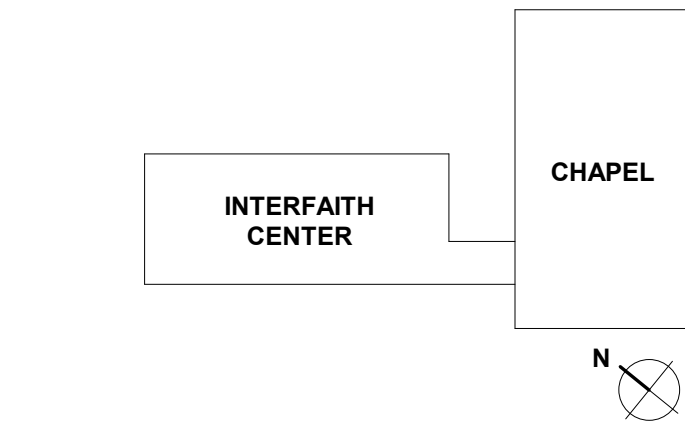WALL CONSTRUCTION TYPE:
A: STUDYDRY WALL PARTITION
C: CMU PARTITION
F: FURRING PARTITION
S: SHAFT WALL
T: MOISTURE-RESISTANT PARTITION (TLT PARTITIONS)
Y: CUSTOM PARTITION


FIRE RATING:
0: NOT RATED
1: 1 HR. RATED
2: 2 HR. RATED

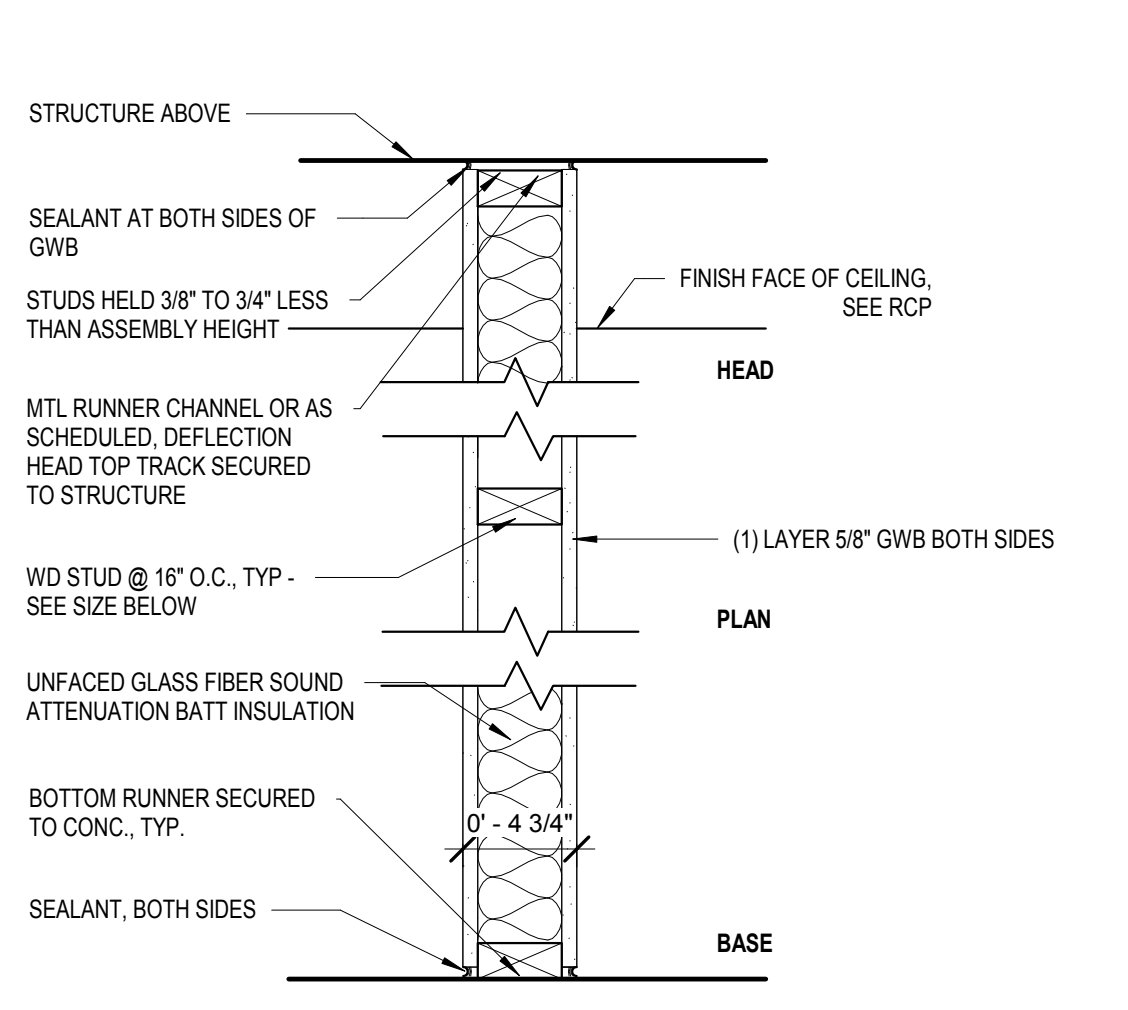STUD/CMU THICKNESS:
1: 1x WOOD FURRING
2: 1 1/2" WOOD STUD
4: 3 1/2" WOOD STUD OR 4" CMU (NOM.) OR 4" CH
6: 5 1/2" WOOD STUD
8: 8" CMU (NOM.)




TYPE	STUD TYPE	FIRE RESIST. TEST	STC RATING	OTHER CRITERIA
A04	WD 2"x4"			3-1/2" UNFACED GLASS FIBER SOUND ATTENUATION BATT INSULATION
A06	WD 2"x6"			5-1/2" UNFACED GLASS FIBER SOUND ATTENUATION BATT INSULATION
A08	WD 2"x8"			7-1/2" UNFACED GLASS FIBER SOUND ATTENUATION BATT INSULATION

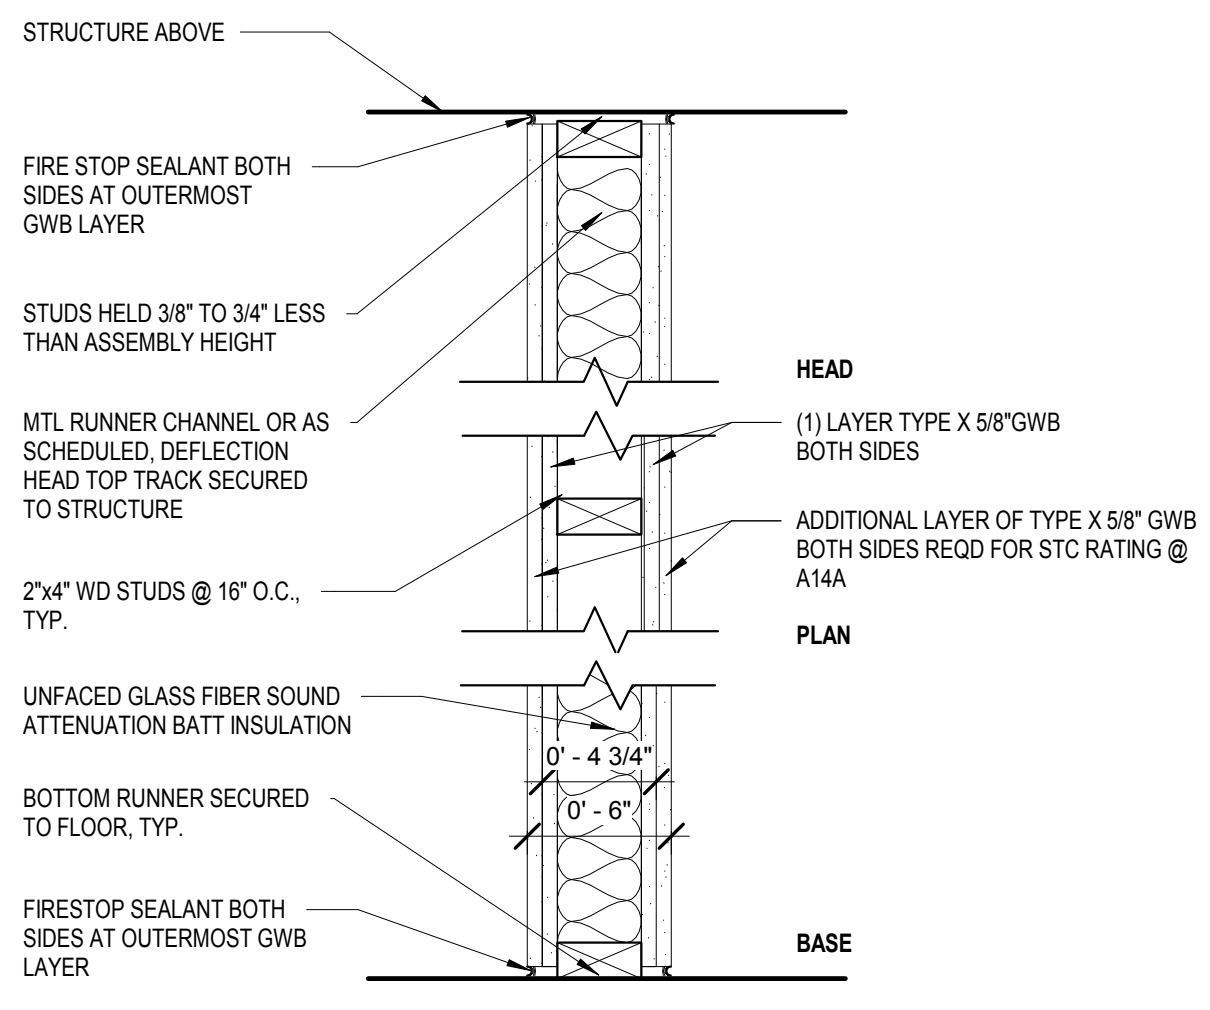A04 - WD STUD, DRYWALL PARTITION
1 1/2" = 1'-0"




TYPE	STUD TYPE	FIRE RESIST. TEST	STC RATING	OTHER CRITERIA
A14	WD 2"x4"	U465		3-1/2" UNFACED GLASS FIBER SOUND ATTENUATION BATT INSULATION
A14	WD 2"x4"	U465	MIN. 50	3-1/2" UNFACED GLASS FIBER SOUND ATTENUATION BATT INSULATION; ADDITIONAL LAYER OF 5/8" GWB ON EACH SIDE

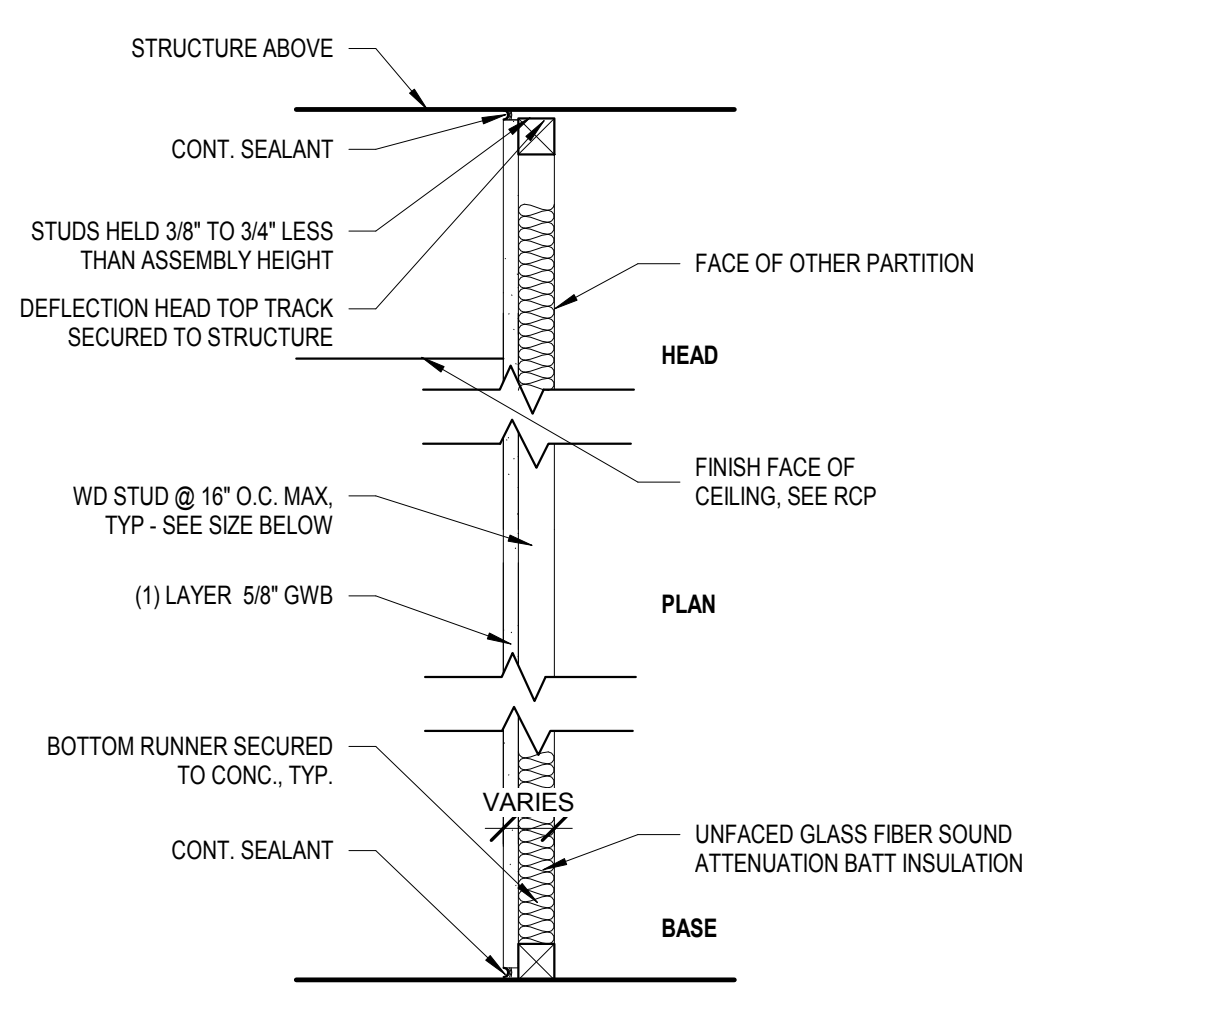A14 - RATED WD STUD, DRYWALL PARTITION
1 1/2" = 1'-0"




TYPE	STUD TYPE	FIRE RESIST. TEST	STC RATING	OTHER CRITERIA
F02	3/4"			
F04	3 1/2"			3-1/2" UNFACED GLASS FIBER SOUND ATTENUATION BATT INSULATION
F06	5 1/2"			5-1/2" UNFACED GLASS FIBER SOUND ATTENUATION BATT INSULATION

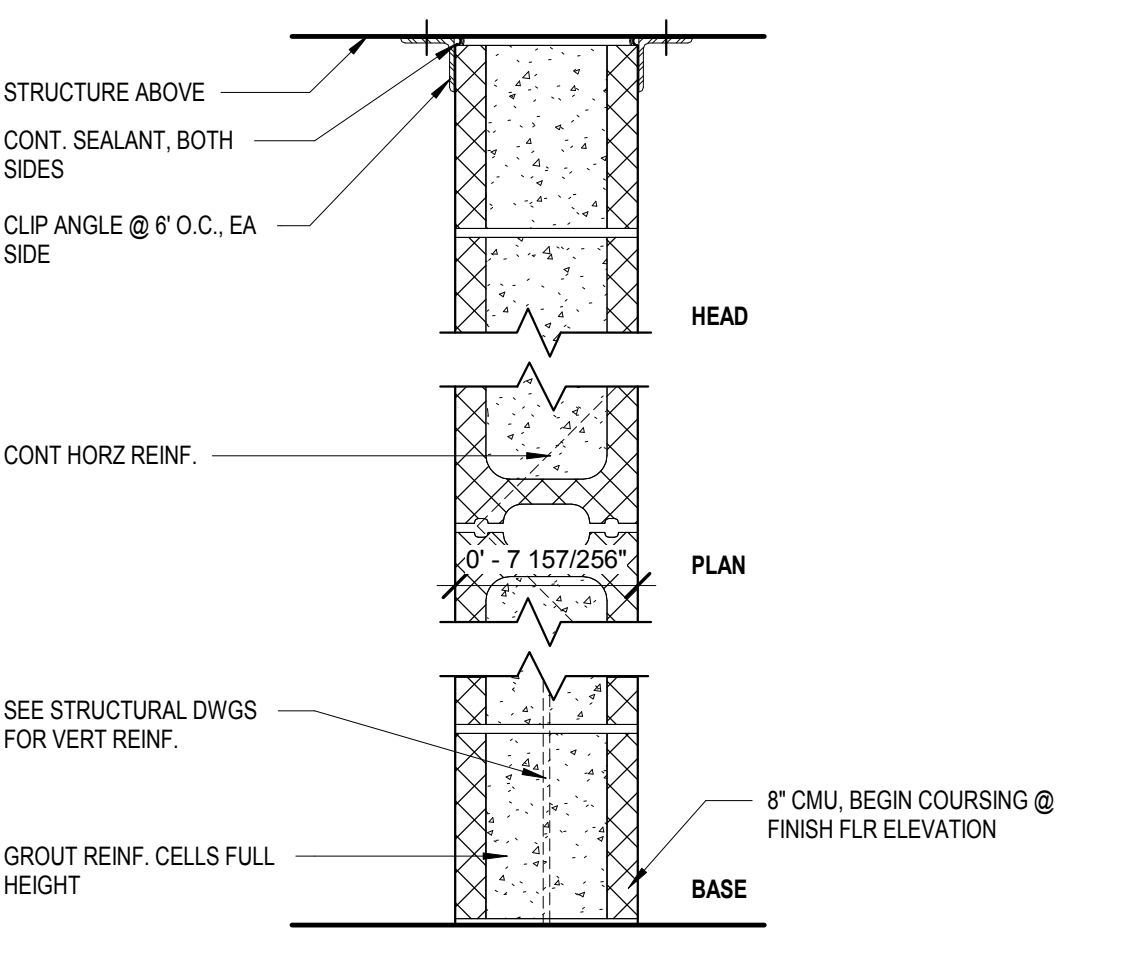F02 - FURRING PARTITION
1 1/2" = 1'-0"




TYPE	STUD TYPE	FIRE RESIST. TEST	STC RATING	OTHER CRITERIA
C18	8" CMU	U905		1 HR. RATED CMU WALL
C28	8" CMU	U905		2 HR. RATED CMU WALL

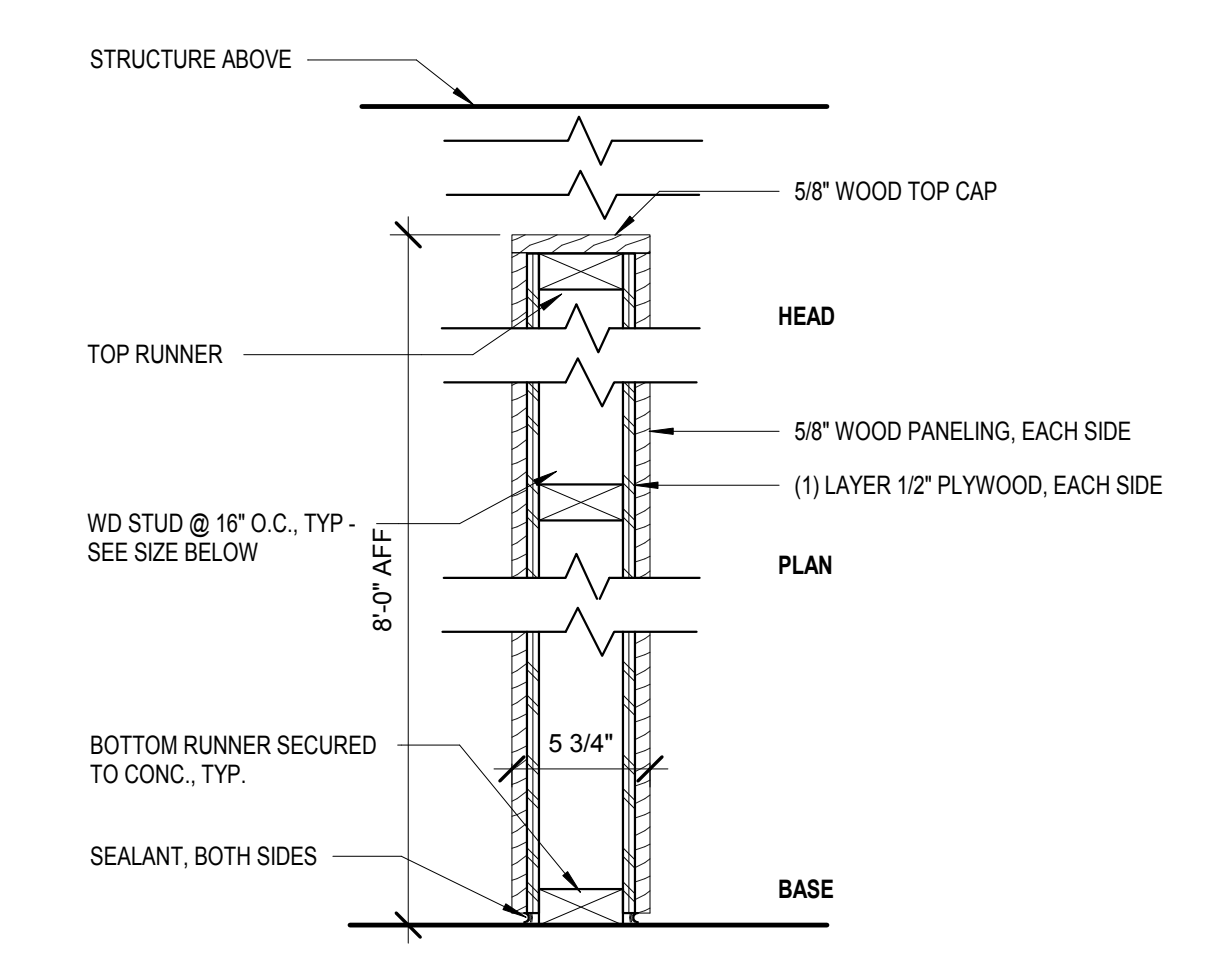C18 - MASONRY PARTITION
1 1/2" = 1'-0"



TYPE	STUD TYPE	FIRE RESIST. TEST	STC RATING	OTHER CRITERIA
Y04	WD 2"x4"			

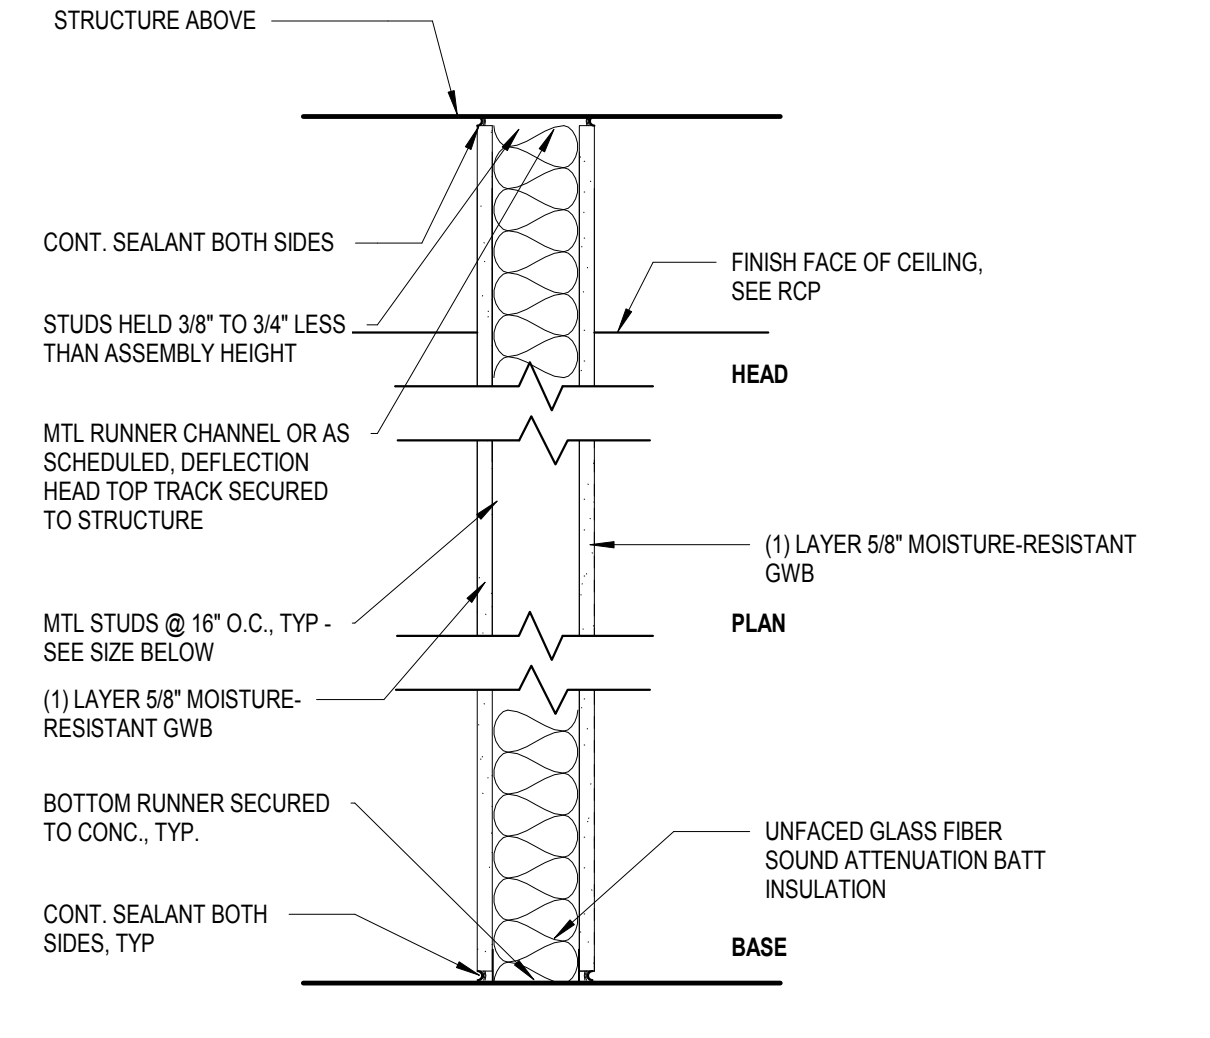Y04 - WD STUD, WD PANEL PARTITION
1 1/2" = 1'-0"




TYPE	STUD TYPE	FIRE RESIST. TEST	STC RATING	OTHER CRITERIA
T01	3/4"			FURRING PARTITION (1) LAYER 5/8" MOISTURE-RESISTANT GWB ON WET ROOM SIDE.
T04	3 1/2"			(1) LAYER 5/8" MOISTURE-RESISTANT GWB ON WET ROOM SIDES; (1) LAYER 5/8" STANDARD GWB ON NON-WET ROOMS; 3-1/2" UNFACED GLASS FIBER SOUND ATTENUATION BATT INSULATION
T04A	3 1/2"			FURRING PARTITION (1) LAYER 5/8" MOISTURE-RESISTANT GWB ON WET ROOM SIDE.
T08	7 1/4"			(1) LAYER 5/8" MOISTURE-RESISTANT GWB ON WET ROOM SIDES; (1) LAYER 5/8" STANDARD GWB ON NON-WET ROOM SIDES; 5-1/4" UNFACED GLASS FIBER SOUND ATTENUATION BATT INSULATION

T01 - WD STUD, MOISTURE-RESISTANT DRYWALL PARTITION
1 1/2" = 1'-0"

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DRAWING NAME
FINISH SCHEDULE

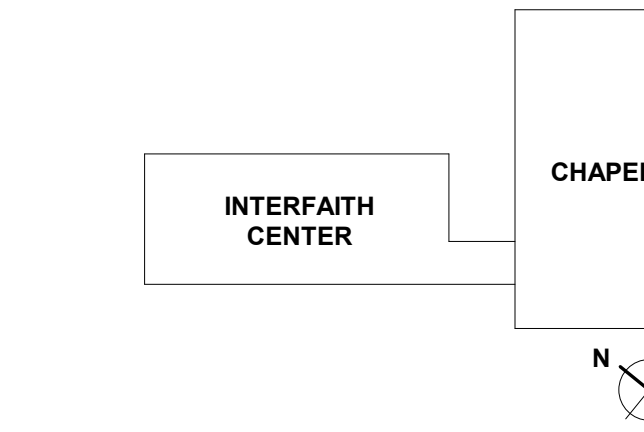DRAWING NUMBER
A9.30

FINISH SCHEDULE							
Key Name	Material	Manufacturer (Basis of Design)	Style	Color	Size	Location	Remarks
1-FLOOR							
CPT-1	CARPET TILE	SHAW	MICA TILE, ASHLAR INSTALLATION	SMOKY QUARTZ	18X36	OFFICES	ALLOW \$30/SY MATERIAL COST
CPT-2	CARPET TILE	SHAW	QUARTZ TILE, ASHLAR INSTALLATION	SMOKY QUARTZ	18X36	WORK ROOM	ALLOW \$30/SY MATERIAL COST
CPT-3	CARPET TILE	INTERFACE	HUMAN NATURE, HN 830, ASHLAR INSTALLATION	BONE 104244	25CM X 1M	QUIET LOUNGE BORDER	ALLOW \$30/SY MATERIAL COST
CPT-4	CARPET TILE	INTERFACE	URBAN RETREAT, UR 304, BRICK INSTALLATION	STRAW / BLUE 103659	50CM X 50CM	QUIET LOUNGE INSET	ALLOW \$40/SY MATERIAL COST
CPT-5	CARPET TILE	SHAW	UNCOVER TILE, ST150, ASHLAR INSTALLATION	BURNISHED PEWTER, 50516	9X36	HILLEL BORDER AND OFFICES	ALLOW \$40/SY MATERIAL COST
CPT-6	CARPET TILE	INTERFACE	WORLD WOVEN, WW895, ASHLAR INSTALLATION	HIGHLAND WEAVE, 105377	25CM X 1M	HILLEL INSET	
CPT-7	WALK-OFF MAT	TANDUS CENTIVA	ASSERTIVE ACTION 04837, BRICK INSTALLATION	LEAD SHOT, 26207	24X24	ENTRY	ALLOW \$20/SY MATERIAL COST
CPT-8	CARPET TILE	SHAW	DYE LAB, 5T041, BRICK INSTALLATION	INDIGO, 41496	24X24	GREAT ROOM INSET	
CPT-9	CARPET TILE	INTERFACE	HUMAN NATURE, HN 830, ASHLAR INSTALLATION	COBALT 104240	25CM X 1M	LOBBY INSET BORDER	
CPT-10	CARPET TILE	INTERFACE	HUMAN NATURE, HN 840, ASHLAR INSTALLATION	EARTH 104227	25CM X 1M	LOBBY INSET FIELD	
CPT-11	CARPET TILE	INTERFACE	PIN LINE, BRICK INSTALLATION	STRAW	50CM X 50CM	PRAYER ROOMS - INSTALLED AT 45 DEGREE ANGLE TO ROOM	
CPT-12	BROADLOOM CARPET	SHAW	SHADOW PLUSH 5A127	MUSE 24110	12'	PRAYER LOBBY	
PTF-1	PORCELAIN TILE FLOOR	MOSAIC TILE	SPEAK EASY AV283, 1/3 ASHLAR INSTALLATION	SWEET GEORGIA BROWN	6X36	LOBBY / GREAT ROOM / KITCHEN / DINING	ALLOW \$8/SF MATERIAL COST
PTF-2	PORCELAIN TILE FLOOR	ARCHITECTURAL CERAMICS	WOOD STOCK, 1/3 ASHLAR INSTALLATION	VANILLA	6X36	BATHROOMS	ALLOW \$6/SF MATERIAL COST
PTF-3	PORCELAIN TILE FLOOR	NOVABELL IMPERIAL	HONED RECTIFIED, BRICK INSTALLATION	CREMA	24X48	ABLUTION AREAS	ALLOW \$8/SF MATERIAL COST
SCO	SEALED CONCRETE	-	SEALED CONCRETE			BUILDING SUPPORT/TELCOM/JANITOR	
2-BASE							
RBB-1	RUBBER BASE	JOHNSONITE	COVE BASE		4" HIGH ROLL	BUILDING SUPPORT/TELCOM/JANITOR/OFFICES/CORRIDOR 000A	
WDB-1	WOOD BASE		CHERRY, QUARTER SAWN	STAIN COLOR TBD	6" HIGH X 5/8" TH.	LOBBY/CORRIDOR 101/GREAT ROOM104/KITCHEN 103/DINING 102, PRAYER ROOMS, PRAYER LOBBY, HILLEL, WORKROOM	
WDB-2	WOOD BASE		MATCH EXISTING AT CHAPEL	STAIN TO MATCH EXISTING AT CHAPEL		CHAPEL	
3-WALL							
CTW-1	CERAMIC TILE WALL	DALTILE	ELEVARE	WHITE	4X16	BATHROOM WALLS	
CTW-2	CERAMIC TILE WALL	NOVABELL IMPERIAL	PROVENZALE	CREMA	12X12 SHEET OF MOSAICS	ABLUTION AREA WALLS	ALLOW \$15/SF MATERIAL COST
GTW-1	GLASS TILE WALL	TILE BAR	KERRIE	KELLY BLUE	12X12 SHEET OF MOSAICS	KITCHEN BACKSPLASH - FULL HEIGHT - REFER TO ELEVATIONS, DINING ROOM BACKSPLASH	ALLOW \$15/SF MATERIAL COST
PLW-1	PLASTIC LAMINATE WALL PANEL	WILSONART PREMIUM AEON				ELEVATOR CAB	
TWS-1	TACKABLE WALL SURFACE	FORBO BULLETIN BOARD		2206 OYSTER SHELL	6MM	LOBBY 101 CORRIDOR	
WDP-1	WOOD PANELING	CUSTOM	MATCH EXISTING AT CHAPEL	STAIN TO MATCH EXISTING AT CHAPEL		CHAPEL	
4-CEILING							
APC-1	ACOUSTIC PANEL CEILING	ARMSTRONG	CIRRUS TEGULAR		24X24 WITH 9/16" GRID	OFFICES, CORRIDOR 000A	
APC-2	ACOUSTIC PANEL CEILING	ARMSTRONG	OPTIMA SQUARE TEGULAR		30X60 WITH 9/16" GRID	DINING, LOBBY, HILLEL	
ECO	EXPOSED CEILING	-	-	-	-	MECH / ELEC / CUSTODIAL	
GWB	PAINTED GYPSUM WALL BOARD	-	-	-	-	PT-2, UNLESS OTHERWISE NOTED	
4-MISC							
RSS-1	RECESSED SOLAR SHADE - MANUAL	LUTRON	SHEER WEAVE 2390 - 5%	BASKETWEAVE 90		ALL WINDOWS, U.N.O.	
SC-1	SHOWER CURTAIN - @ SHOWER	IINPRO CLICKEZE	SUPER BIO STAT	WHITE		SHOWER ENCLOSURE	
5-MILLWORK							
QTZ-1	QUARTZ COUNTERTOP	ZODIAQ		CALACATTA NATURA	2CM	KITCHEN AND DINING COUNTERTOPS	
SS-1	SOLID SURFACE	HI-MACS		IVORY WHITE S29	2CM	WINDOW SILLS	
SS-2	SOLID SURFACE	CORIAN		GLACIER ICE	2CM	ABLUTION FLOOR SINKS	
SS-3	SOLID SURFACE	CORIAN		DUNE PRIMA	2CM	WORK ROOM COUNTERTOP	
WD-1	WOOD		CHERRY, QUARTER SAWN	STAIN COLOR TBD	VARIES	COLUMN SURROUNDS, CEILING TRIM, WINDOW TRIM, BUILT-IN MILLWORK, LOBBY SCREEN	
WDT-1	WOOD TREAD	WINDFALL LUMBER	CHERRY, SIDE GRAIN	STAIN COLOR TBD	1" TH.	STAIR TREADS WITH INTEGRATED METAL NOSING	
6-PAINT							
P-1	PAINT	SHERWIN WILLIAMS	EGGSHELL FINISH	SW 7570 EGRET WHITE		WALLS THROUGHOUT, UNLESS OTHERWISE NOTED	
P-2	PAINT	SHERWIN WILLIAMS	FLAT FINISH	SW 7008 ALABASTER		GYP BOARD CEILING/SOFFIT THROUGHOUT, UNLESS OTHERWISE NOTED	
P-3	PAINT	SHERWIN WILLIAMS	SEMI-GLOSS FINISH	SW 6531 INDIGO		BATHROOM WALLS	
P-4	PAINT	SHERWIN WILLIAMS	EGGSHELL FINISH	TBD		ACCENT WALLS - LOCATION TBD	
P-5	PAINT	SHERWIN WILLIAMS	EGGSHELL FINISH	TBD		ACCENT WALLS - LOCATION TBD	