GOUCHER —college—

PROJECT INFORMATION

11

PROJECT TEAM

ARCHITECT
AYERS SAINT GROSS
1040 HULL STREET, SUITE 100
BALTIMORE, MD 21230
410.347.8500
www.asg-architects.com

M/E/P & FIRE PROTECTION ENGINEER

MUELLER ASSOCIATES

1306 CONCOURSE DRIVE, SUITE 100

LINTHICUM, MD 21090

410.646.4500

www.muellerassoc.com

STRUCTURAL ENGINEER

MORABITO CONSULTANTS

952 RIDGEBROOK ROAD, SUITE 1700
SPARKS, MD 21152
410.467.2377
www.morabitoconsultants.com

CIVIL ENGINEER

WBCM
300 EAST JOPPA ROAD, SUITE 200
BALTIMORE, MD 21286

410.512.4500

www.wbcm.com

LANDSCAPE ARCHITECT

AYERS SAINT GROSS

1040 HULL STREET, SUITE 100

BALTIMORE, MD 21230

1040 HULL STREET, SUITE 100 BALTIMORE, MD 21230 410.347.8500 www.asg-architects.com

IT / AV / SECURITY

SPEXSYS
7257 PARKWAY DRIVE, SUITE 260
HANOVER, MD 21076
410.712.0390
www.spexsys.com

COMMISSIONING KIBART

KIBART 901 DULANEY VALLEY ROAD, SUITE 301 TOWSON, MD 21204 410.494.1111 www.kibart.com

CODE CONSULTANT

KOFFEL ASSOCIATES


8815 CENTRE PARK DRIVE, SUITE 200

COLUMBIA, MD 21045

410.750.2246

www.koffel.com

REV. # DESCRIPTION DATE

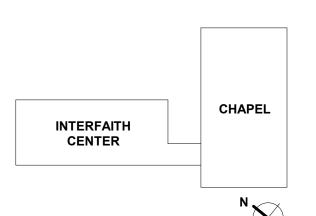

AYERS
SAINT
GROSS

ARCHITECTS + PLANNERS

NOT FOR CONSTRUCTION

| DRAWING INFORMATION |
| ISSUE DATE: 04/28/17 |
| SCALE: 1/8" = 1'-0" |
| JOB NO.: 21641.00 |
| DRAWN BY: EJD |
| PROJECT DESIGN PHASE |
| FOO/ CONSTRUCTION

50% CONSTRUCTION DOCUMENTS

LEGEND

DRAWING NAME

MO.01



1 VERTICAL FAN COIL UNIT IN CLOSET. PROVIDE SIDE ACESS PANEL WITH INTEGRAL RETURN AIR GRILLE.

11

- 2 DIFFUSER PLENUM UP THRU FLOOR TO FLOOR-MOUNTED
- DIFFUSER ON GROUND FLOOR ABOVE.

 3 HVAC WORK WITHIN THIS AREA IS NOT IN CONTRACT.

GOUCHER -college-

PROJECT INFORMATION

PROJECT TEAM

ARCHITECT
AYERS SAINT GROSS
1040 HULL STREET, SUITE 100
BALTIMORE, MD 21230
410.347.8500
www.asg-architects.com

M/E/P & FIRE PROTECTION ENGINEER

MUELLER ASSOCIATES

1306 CONCOURSE DRIVE, SUITE 100

LINTHICUM, MD 21090

410.646.4500

www.muellerassoc.com

STRUCTURAL ENGINEER

MORABITO CONSULTANTS
952 RIDGEBROOK ROAD, SUITE 1700
SPARKS, MD 21152
410.467.2377
www.morabitoconsultants.com

CIVIL ENGINEER
WBCM

300 EAST JOPPA ROAD, SUITE 200 BALTIMORE, MD 21286 410.512.4500 www.wbcm.com

AYERS SAINT GROSS 1040 HULL STREET, SUITE 100 BALTIMORE, MD 21230 410.347.8500

www.asg-architects.com

IT / AV / SECURITY

SPEXSYS
7257 PARKWAY DRIVE, SUITE 260

www.spexsys.com

COMMISSIONING

KIBART


HANOVER, MD 21076 410.712.0390

901 DULANEY VALLEY ROAD, SUITE 301 TOWSON, MD 21204 410.494.1111 www.kibart.com

KOFFEL ASSOCIATES 8815 CENTRE PARK DRIVE, SUITE 200 COLUMBIA, MD 21045 410.750.2246 www.koffel.com

CODE CONSULTANT

REV. # DESCRIPTION DATE

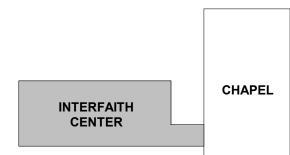



ARCHITECTS + PLANNERS

NOT FOR CONSTRUCTION

DRAWING INFO	ORMATION
ISSUE DATE:	04/28/17
SCALE:	1/8" = 1'-0"
JOB NO.:	21641.00
DRAWN BY:	СВН
PROJECT DESI	GN PHASE

50% CONSTRUCTION DOCUMENTS

FLOOR PLAN - LOWER LEVEL -


HVAC

M2.01

© COPYRIGHT AYERS SAINT GROSS, 2017

IF DRAWING IS REDUCED,
USE GRAPHIC SCALE
0' 4' 8'

1/8" = 1'-0"

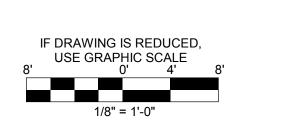

PART FLOOR PLAN - GROUND LEVEL - HVAC
N
1/8" = 1'-0"

11

GOUCHER —college—

PROJECT INFORMATION

PROJECT TEAM

ARCHITECT
AYERS SAINT GROSS
1040 HULL STREET, SUITE 100
BALTIMORE, MD 21230
410.347.8500

www.asg-architects.com

M/E/P & FIRE PROTECTION ENGINEER

MUELLER ASSOCIATES

1306 CONCOURSE DRIVE, SUITE 100

LINTHICUM, MD 21090

410.646.4500

www.muellerassoc.com

STRUCTURAL ENGINEER

MORABITO CONSULTANTS

952 RIDGEBROOK ROAD, SUITE 1700

SPARKS, MD 21152

410.467.2377

www.morabitoconsultants.com

CIVIL ENGINEER

WBCM

300 EAST JOPPA ROAD, SUITE 200 BALTIMORE, MD 21286 410.512.4500 www.wbcm.com

LANDSCAPE ARCHITECT
AYERS SAINT GROSS
1040 HULL STREET, SUITE 100
BALTIMORE, MD 21230
410.347.8500

www.asg-architects.com

IT / AV / SECURITY

SPEXSYS
7257 PARKWAY DRIVE, SUITE 260
HANOVER, MD 21076
410.712.0390
www.spexsys.com

COMMISSIONING KIBART


901 DULANEY VALLEY ROAD, SUITE 301 TOWSON, MD 21204 410.494.1111 www.kibart.com


CODE CONSULTANT

KOFFEL ASSOCIATES
8815 CENTRE PARK DRIVE, SUITE 200
COLUMBIA, MD 21045
410.750.2246
www.koffel.com

REVISIONS

REV. # DESCRIPTION DATE

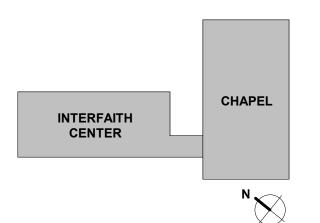

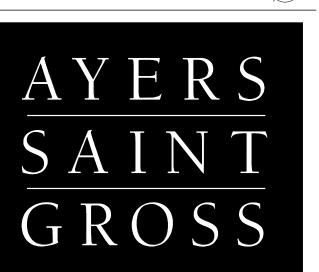

ARCHITECTS + PLANNERS

NOT FOR CONSTRUCTION

DRAWING INFORM	ATION
ISSUE DATE:	04/28/17
SCALE:	1/8" = 1'-0"
JOB NO.:	21641.00
DRAWN BY:	СВН
PROJECT DESIGN	PHASE

50% CONSTRUCTION DOCUMENTS

DRAWING NAME

FLOOR PLAN - GROUND LEVEL - HVAC

DRAWING NUMBER

M2.02

8'-0" LENGTH, (1) 8'-0" LENGTH PLENUM D 1 FLOOR PLAN - LEVEL 2 - HVAC N 1/8" = 1'-0"

5

SPECIAL NOTES:

1 FLOOR-MOUNTED GRILLE. 2 HVAC WORK WITHIN THIS AREA IS NOT IN CONTRACT. 11

PROJECT INFORMATION

PROJECT TEAM

ARCHITECT AYERS SAINT GROSS 1040 HULL STREET, SUITE 100 BALTIMORE, MD 21230 410.347.8500 www.asg-architects.com

M/E/P & FIRE PROTECTION ENGINEER MUELLER ASSOCIATES 1306 CONCOURSE DRIVE, SUITE 100 LINTHICUM, MD 21090 410.646.4500 www.muellerassoc.com

STRUCTURAL ENGINEER MORABITO CONSULTANTS 952 RIDGEBROOK ROAD, SUITE 1700 SPARKS, MD 21152

410.467.2377 www.morabitoconsultants.com

300 EAST JOPPA ROAD, SUITE 200 BALTIMORE, MD 21286 410.512.4500 www.wbcm.com

CIVIL ENGINEER

LANDSCAPE ARCHITECT AYERS SAINT GROSS 1040 HULL STREET, SUITE 100 BALTIMORE, MD 21230

410.347.8500 www.asg-architects.com IT / AV / SECURITY SPEXSYS

7257 PARKWAY DRIVE, SUITE 260 HANOVER, MD 21076 410.712.0390 www.spexsys.com


KIBART 901 DULANEY VALLEY ROAD, SUITE 301 TOWSON, MD 21204 410.494.1111


www.kibart.com

COMMISSIONING

CODE CONSULTANT KOFFEL ASSOCIATES
8815 CENTRE PARK DRIVE, SUITE 200
COLUMBIA, MD 21045
410.750.2246
www.koffel.com

KEY PLAN

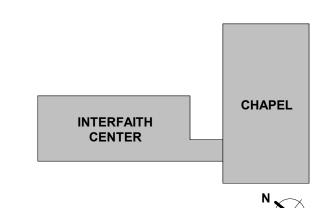

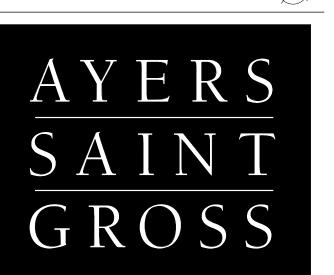

ARCHITECTS + PLANNERS

NOT FOR CONSTRUCTION

DRAWING INFO	ORMATION
ISSUE DATE:	04/28/17
SCALE:	1/8" = 1'-0"
JOB NO.:	21641.00
DRAWN BY:	СВН
PROJECT DES	IGN PHASE

50% CONSTRUCTION DOCUMENTS

FLOOR PLAN - LEVEL 2 - HVAC

DRAWING NAME

DRAWING NUMBER M2.03

© COPYRIGHT AYERS SAINT GROSS, 2017

IF DRAWING IS REDUCED, USE GRAPHIC SCALE 0' 4'

1 HVAC WATER
TREATMENT **EQUIPMENT** HOUSEKEEPING PAD BY ARCH—— BUILDING SUPPORT HOUSEKEEPING PAD BY ARCH 012 16x16 SA B REFER TO M2.01 FOR CONTINUATION -<u>AHU-1</u> SIDE-CLEARANCE FOR AHU — __10x8 EA C D 12x12 OA-/ - CONNECT TO 24x24 PLENUM AND BLANKOFF UNUSED 12x12 PLENUM AND BLANKOFF UNUSED PORTION OF ARCHITECTURAL LOUVER IN WALL PORTION OF ARCHITECTURAL LOUVER IN WALL

1 MECHANICAL ROOM PART PLAN - LOWER LEVEL - HVAC N 1/4" = 1'-0"

5

3

1 TO CAMPUS DISTRIBUTION LOOP - REFER TO CIVIL DRAWINGS FOR CONTINUATION. 2 TO/FROM SYSTEM PUMPS - REFER TO SCHEMATICS FOR PIPING CONFIGURATION.

SPECIAL NOTES:

11

PROJECT TEAM

ARCHITECT AYERS SAINT GROSS 1040 HULL STREET, SUITE 100 BALTIMORE, MD 21230 410.347.8500 www.asg-architects.com

PROJECT INFORMATION

M/E/P & FIRE PROTECTION ENGINEER MUELLER ASSOCIATES 1306 CONCOURSE DRIVE, SUITE 100 LINTHICUM, MD 21090 410.646.4500 www.muellerassoc.com

STRUCTURAL ENGINEER MORABITO CONSULTANTS 952 RIDGEBROOK ROAD, SUITE 1700 SPARKS, MD 21152 410.467.2377

www.morabitoconsultants.com **CIVIL ENGINEER**

300 EAST JOPPA ROAD, SUITE 200 BALTIMORE, MD 21286 410.512.4500 www.wbcm.com

LANDSCAPE ARCHITECT AYERS SAINT GROSS 1040 HULL STREET, SUITE 100 BALTIMORE, MD 21230 410.347.8500

www.asg-architects.com IT / AV / SECURITY SPEXSYS 7257 PARKWAY DRIVE, SUITE 260 HANOVER, MD 21076


410.712.0390 www.spexsys.com COMMISSIONING **KIBART**


410.494.1111 www.kibart.com CODE CONSULTANT

901 DULANEY VALLEY ROAD, SUITE 301 TOWSON, MD 21204

KOFFEL ASSOCIATES
8815 CENTRE PARK DRIVE, SUITE 200
COLUMBIA, MD 21045
410.750.2246
www.koffel.com

REVISIONS **KEY PLAN**

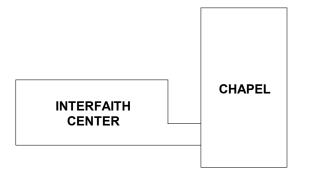

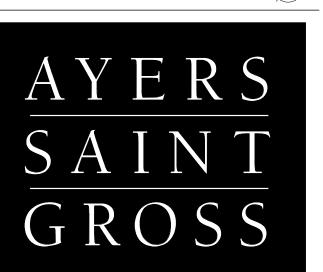

ARCHITECTS + PLANNERS

NOT FOR CONSTRUCTION

DRAWING INFO	ORMATION
ISSUE DATE: 04/28/	
SCALE:	1/4" = 1'-0"
JOB NO.:	21641.00
DRAWN BY:	СВН
PROJECT DESI	GN PHASE

50% CONSTRUCTION DOCUMENTS

IF DRAWING IS REDUCED, USE GRAPHIC SCALE

DRAWING NAME **MECHANICAL ROOM PART**

PLAN - LOWER LEVEL - HVAC DRAWING NUMBER

M3.01

TS-SCHWR


REMOVABLE

SPOOL PIECE WITH

HOSE END DRAIN -

CHILLED WATER SYSTEM SCHEMATIC M4.01 NOT TO SCALE

□ <u>FS-HX-1</u>

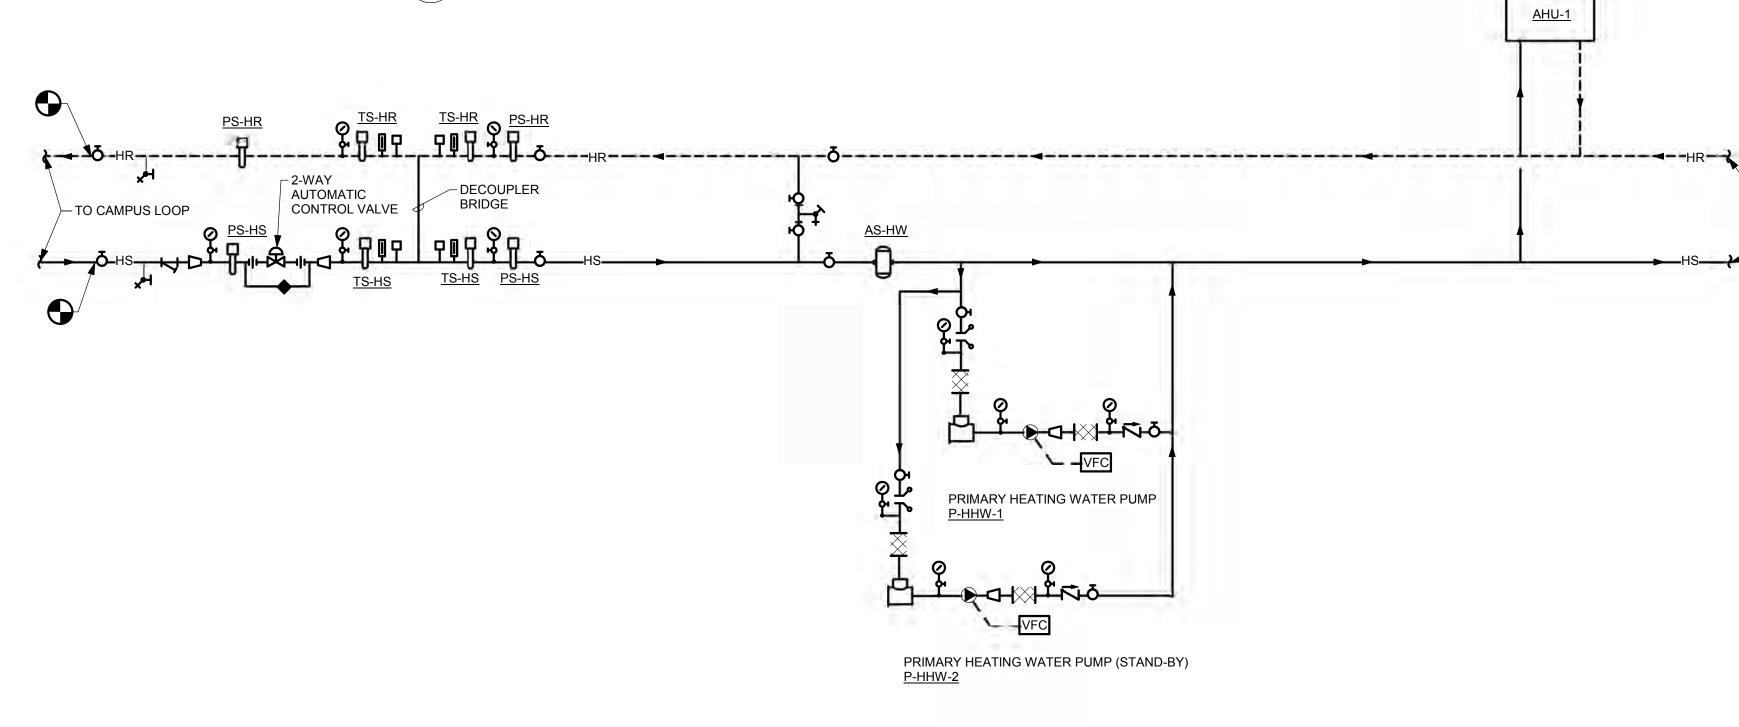

PRIMARY CHILLED WATER PUMP


P-CHW-1

PRIMARY CHILLED WATER PUMP (STAND-BY)


P-CHW-2

3 HEATING WATER SYSTEM SCHEMATIC

M4.01 NOT TO SCALE

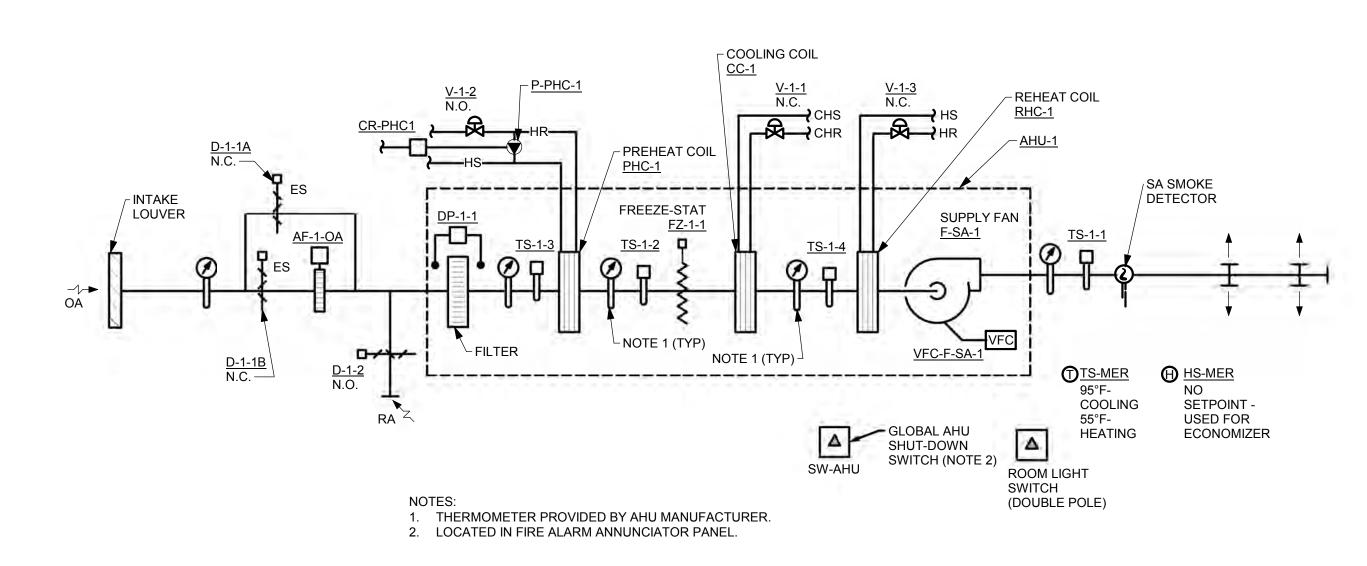

5 AHU-1 SCHEMATIC M4.01 NOT TO SCALE

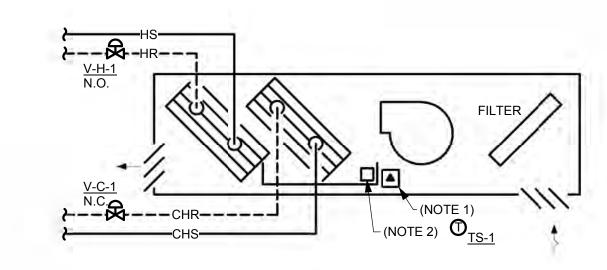


NOTES:

─ TO FCUs AND UHs

1. SPEED SWITCH FURNISHED BY UNIT MANUFACTURER.

2. CONDENSATE PAN OVERFLOW SWITCH OS-1 FURNISHED BY UNIT MANUFACTURER.


PAN COIL UNIT M4.01 NOT TO SCALE

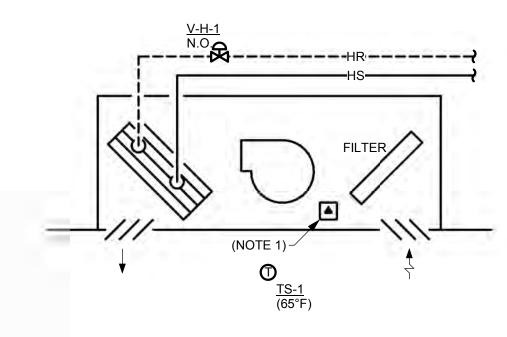

1. SPEED SWITCH FURNISHED BY UNIT MANUFACTURER.

4 HYDRONIC CABINET UNIT HEATER

M4.01 NOT TO SCALE

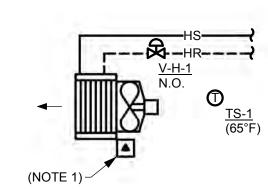

NOTES:

1. SPEED SWITCH FURNISHED BY UNIT MANUFACTURER.

6 HYDRONIC PROPELLER UNIT HEATER
M4.01 NOT TO SCALE

PROJECT INFORMATION

11

PROJECT TEAM

ARCHITECT AYERS SAINT GROSS 1040 HULL STREET, SUITE 100 BALTIMORE, MD 21230 410.347.8500 www.asg-architects.com

M/E/P & FIRE PROTECTION ENGINEER MUELLER ASSOCIATES 1306 CONCOURSE DRIVE, SUITE 100 LINTHICUM, MD 21090 410.646.4500 www.muellerassoc.com

STRUCTURAL ENGINEER MORABITO CONSULTANTS 952 RIDGEBROOK ROAD, SUITE 1700 SPARKS, MD 21152

410.467.2377 www.morabitoconsultants.com **CIVIL ENGINEER**

300 EAST JOPPA ROAD, SUITE 200 BALTIMORE, MD 21286 410.512.4500 www.wbcm.com

LANDSCAPE ARCHITECT AYERS SAINT GROSS 1040 HULL STREET, SUITE 100 BALTIMORE, MD 21230

410.347.8500 www.asg-architects.com IT / AV / SECURITY

SPEXSYS 7257 PARKWAY DRIVE, SUITE 260 HANOVER, MD 21076 410.712.0390 www.spexsys.com


KIBART 901 DULANEY VALLEY ROAD, SUITE 301 TOWSON, MD 21204

410.494.1111 www.kibart.com

COMMISSIONING

CODE CONSULTANT KOFFEL ASSOCIATES 8815 CENTRE PARK DRIVE, SUITE 200 COLUMBIA, MD 21045 410.750.2246 www.koffel.com

REVISIONS KEY PLAN

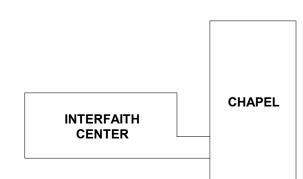



ARCHITECTS + PLANNERS

NOT FOR CONSTRUCTION


DRAWING INFORMATION		
ISSUE DATE:	04/28/17	
SCALE:	1/8" = 1'-0"	
JOB NO.:	21641.00	
DRAWN BY:	СВН	
PROJECT DES	IGN PHASE	

50% CONSTRUCTION DOCUMENTS

SCHEMATICS

DRAWING NAME


DRAWING NUMBER M4.01

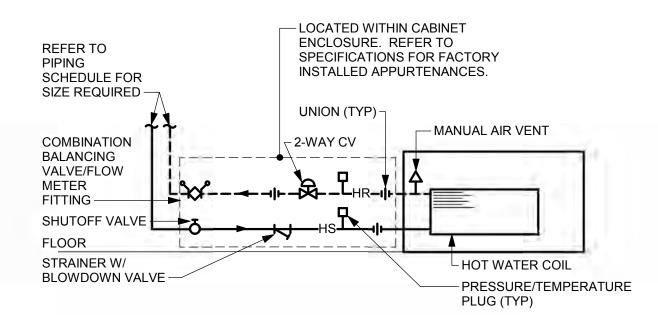

PIPE S	SCHEDULE
GPM	PIPE SIZE (IN
0-3.5	3/4"
3.6-7.0	1"
7.1-13.0	1 1/4"

CABINET UNIT HEATER

M5.01 NOT TO SCALE

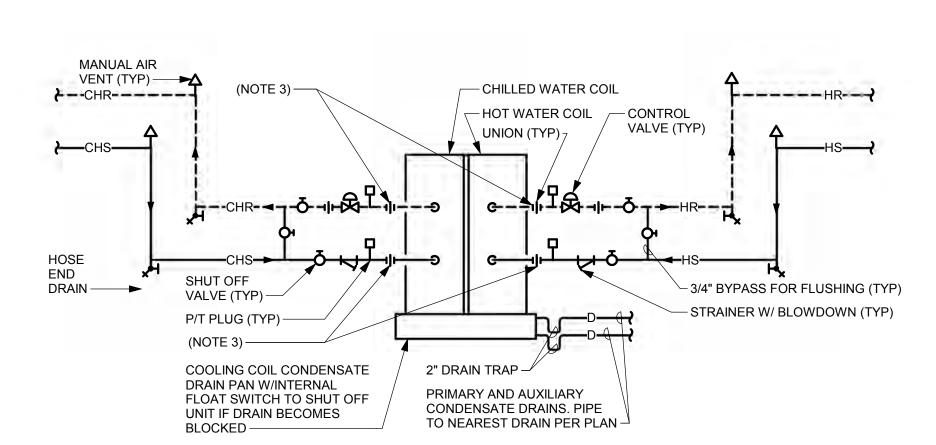

PIPE SCHEDULE GPM PIPE SIZE (IN) 0 - 3.5 3.6 - 7.0 7.1 - 13.0 1 1/4"

13.1 - 21.0

1. COOLING AND HEATING COILS SHOWN, DELETE HEATING PIPING FOR COOILING ONLY UNIT.

- 2. CONCEAL PIPING WITHIN WALLS AND CABINET ENCLOSURE
- 3. CONTRACTOR POINT OF CONNECTION

4 VERTICAL FAN COIL UNTS (TYPE VC) M5.01 NOT TO SCALE

1 1/2"

- 1 1/4", SLOPE TO TANK HIGH CAPACITY AUTOMATIC AIR VENT — AIR SEPARATOR. SUPPORT PRESSURE GAGE W/ COCK (TYP) FROM CEILING/STRUCTURE — FROM SYSTEM (REFER CONNECT TO SIDE OF PIPE TO FLOOR PLANS FOR (NOT TOP OR BOTTOM) TO PUMP SUCTION (REFER TO FLOOR PLANS FOR SIZE) SHUTOFF VALVE (TYP) -NON-POTABLE MAKE-- ANTI-THERMOSYPHON LOOP (TO UP WATER. REFER MIN OF 12" BELOW HORIZONTAL TO PLAN FOR SIZES -- RELIEF VALVE, PIPE FULL SIZE DISCHARGE TO FLOOR DRAIN CHARGING - PRESSURE REDUCING DISCHARGE TO FLOOR VALVE VALVE DRAIN - CHECK VALVE - THROTTLING VALVE PRESSURIZED DIAPHRAGM — 1" BYPASS TYPE EXPANSION TANK -4" HIGH CONCRETE HOUSEKEEPING PAD - SEE

1. REFER TO EXPANSION TANK SCHEDULE FOR CAPACITIES AND PRESSURE

REDUCING AND RELIEF VALVE SETTINGS. 2. DELETE HED IF TAP IN TANK IS NOT PROVIDED BY THE MANUFACTURER.


EXPANSION TANK & AIR SEPARATOR M5.01 NOT TO SCALE

UNLESS OTHERWISE NOTED SIZE OF PAD SHALL BE 6" LARGER IN ——— 1" CHAMFERED EDGES LENGTH & WIDTH THAN EQUIPMENT SERVED — CONC. FLOOR 1/2" SQUARE REVEAL FILLED WITH SEALANT ◆ 4" (NOTE 1) CANT — GALV. STEEL DOWELS CONCRETE PAD AT 18" O.C. IN 2" DEEP REINFORCED WITH 6" x 6" x DRILLED HOLES -10/10 WELDED WIRE MESH

5


1. FOR AIR HANDLING UNITS, INCREASE HOUSEKEEPING PAD HEIGHT TO ALLOW CONDENSATE TRAP INSTALLATION - REFER TO CONDENSATE DRAIN DETAIL. HOUSEKEEPING PAD HEIGHT SHALL NOT EXCEED 6" WITHOUT WRITTEN APPROVAL FROM THE ARCHITECT.

² CONCRETE HOUSEKEEPING PAD \M5.01/ NOT TO SCALE

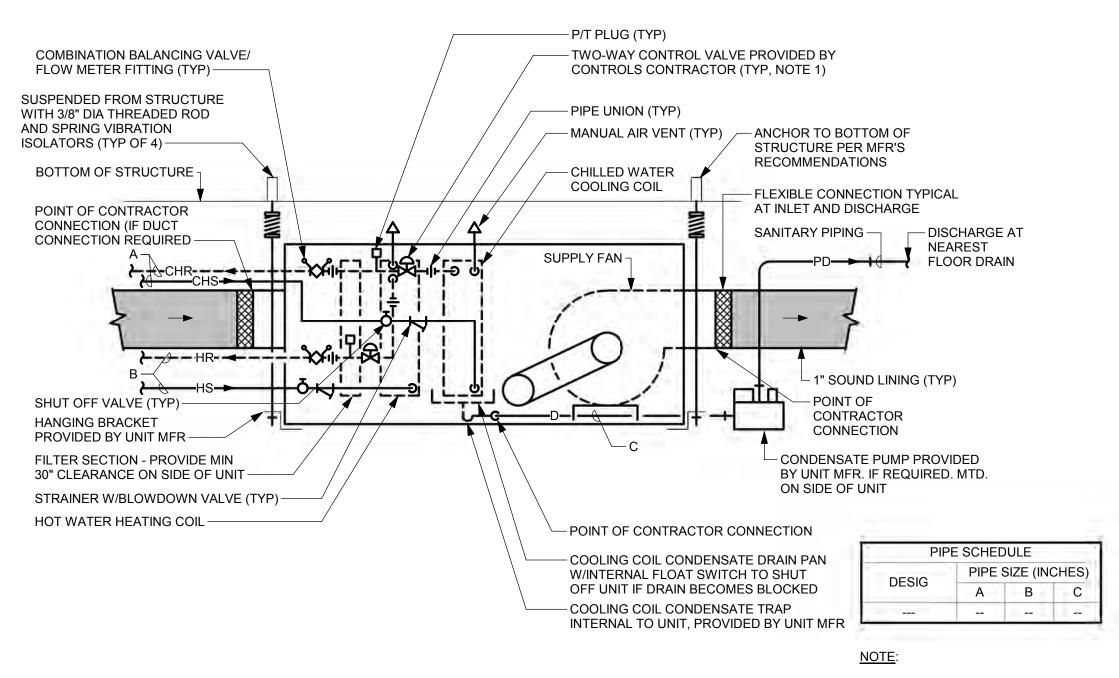

1. TWO WAY CONTROL VALVE SHOWN, REFER TO SCHEDULE FOR UNITS WITH THREE WAY CONTROL VALVE (WITH BALANCING VALVE IN COMMON PIPE).


5 SUSPENDED FAN COIL UNIT - COOLING AND HEATING M5.01 NOT TO SCALE

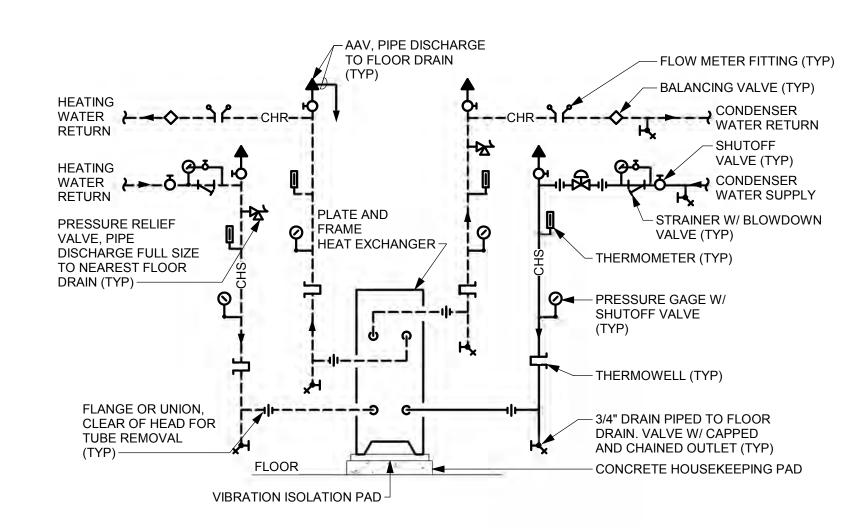

NOTES:


- 1. ALL PIPING SHALL BE ARRANGED TO ALLOW REMOVAL OF PLATE FIN SECTIONS FOR CLEANING OR ADDING ADDITIONAL PLATES WITHOUT DISTURBANCE TO PIPING.
- 2. HEAT EXCHANGERS TO BE PIPED IN A COUNTER FLOW ARRANGEMENT AS INDICATED IN MANUFACTURER'S INSTALLATION INSTRUCTIONS.

8 PLATE AND FRAME WATER-TO-WATER HEAT EXCHANGER M5.01 NOT TO SCALE

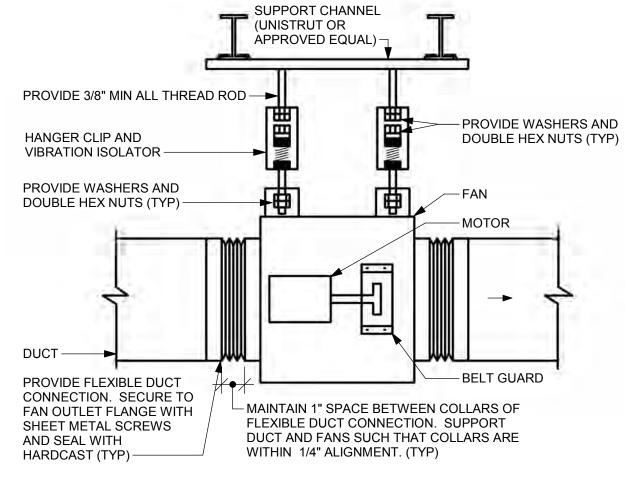


11

3 IN-LINE FAN M5.01 NOT TO SCALE

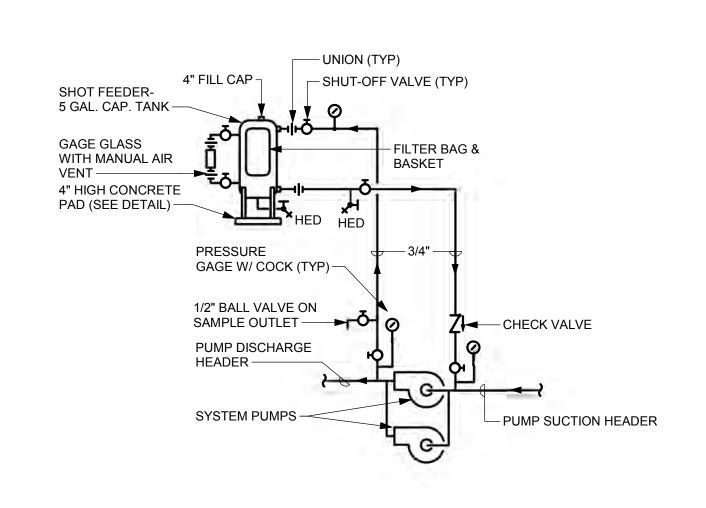

- 1. PROVIDE A CHEMICAL SHOT FEEDER FOR EACH CLOSED SYSTEM. 2. MECHANICAL CONTRACTOR SHALL COORDINATE PIPING AND TAP LOCATIONS WITH WATER TREATMENT CONTRACTOR.
- 6 CLOSED SYSTEM CHEMICAL SHOT FEEDER M5.01 NOT TO SCALE

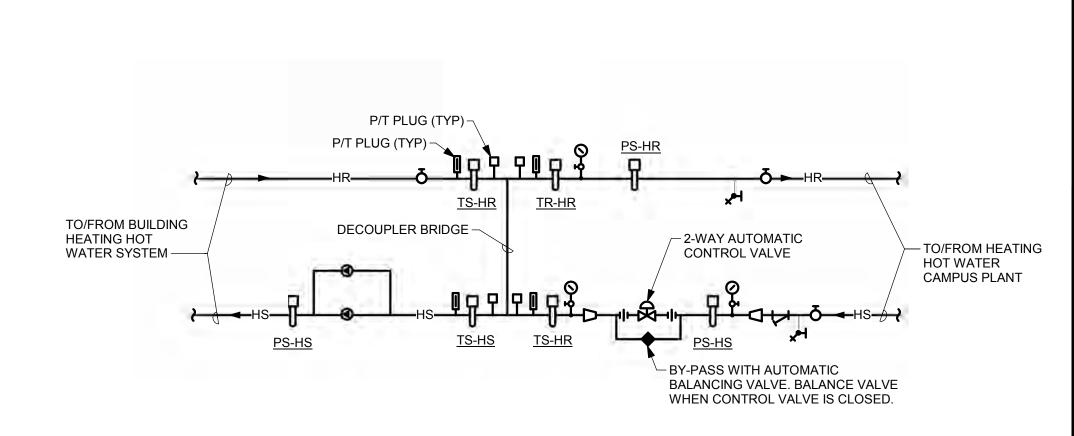

9 HEATING WATER DECOUPLER BRIDGE M5.01 NOT TO SCALE

PROJECT INFORMATION

PROJECT TEAM

ARCHITECT AYERS SAINT GROSS 1040 HULL STREET, SUITE 100 BALTIMORE, MD 21230 410.347.8500 www.asg-architects.com

M/E/P & FIRE PROTECTION ENGINEER MUELLER ASSOCIATES 1306 CONCOURSE DRIVE, SUITE 100 LINTHICUM, MD 21090 410.646.4500 www.muellerassoc.com

STRUCTURAL ENGINEER MORABITO CONSULTANTS 952 RIDGEBROOK ROAD, SUITE 1700 SPARKS, MD 21152 410.467.2377 www.morabitoconsultants.com

CIVIL ENGINEER

300 EAST JOPPA ROAD, SUITE 200 BALTIMORE, MD 21286 410.512.4500 www.wbcm.com

LANDSCAPE ARCHITECT AYERS SAINT GROSS 1040 HULL STREET, SUITE 100 BALTIMORE, MD 21230 410.347.8500

www.asg-architects.com IT / AV / SECURITY SPEXSYS 7257 PARKWAY DRIVE, SUITE 260

HANOVER, MD 21076 410.712.0390 www.spexsys.com COMMISSIONING KIBART

901 DULANEY VALLEY ROAD, SUITE 301

TOWSON, MD 21204


410.494.1111


COLUMBIA, MD 21045

www.kibart.com **CODE CONSULTANT** KOFFEL ASSOCIATES 8815 CENTRE PARK DRIVE, SUITE 200

410.750.2246 www.koffel.com **REVISIONS**

DESCRIPTION **KEY PLAN**

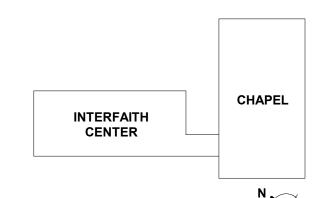

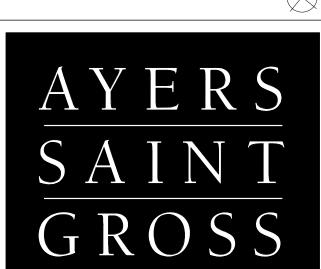

ARCHITECTS + PLANNERS

NOT FOR CONSTRUCTION

ISSUE DATE: SCALE:	04/28/17 1/8" = 1'-0"
SCALE:	1/8" = 1'-0"
JOB NO.:	21641.00
DRAWN BY:	СВН


PROJECT DESIGN PHASE **50% CONSTRUCTION DOCUMENTS**

DRAWING NAME

DRAWING NUMBER

DETAILS


M5.01

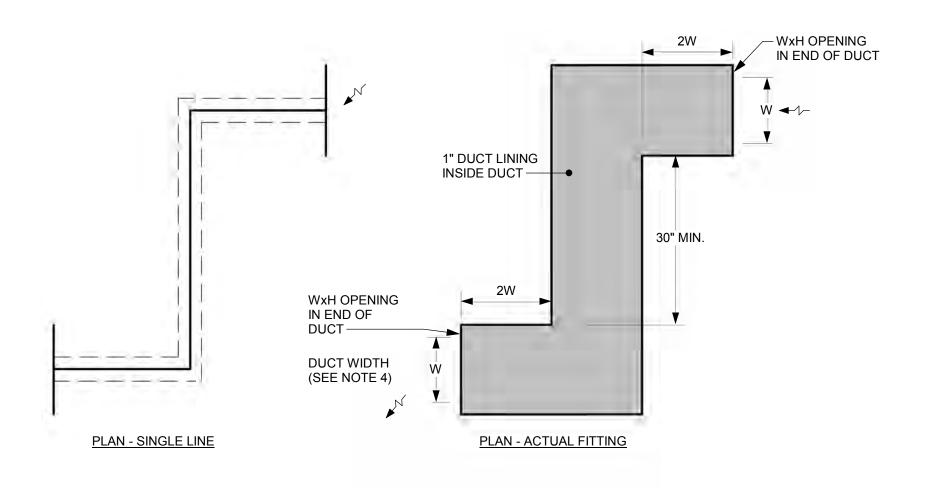

NOTES:

- 1. USE MINIMUM 22 GAUGE OR SMACNA GAUGE (WHICHEVER IS GREATER) SHEET METAL FOR CONSTRUCTION AND LINE WITH 1" THICK SOUND LINING.
- 2. SUSPEND RETURN AIR/TRANSFER DUCT ELBOWS FROM FLOOR SLAB STRUCTURE ABOVE
- 3. CONFIGURATION VARIES FROM ROOM TO ROOM. SEE FLOOR PLANS FOR LOCATIONS AND CONFIGURATION.
- 4. UNLESS SIZE IS INDICATED ON FLOOR PLANS, PROVIDE 8"x6" TRANSFER AIR DUCTS FOR SPACES WITH UP TO TO 150 CFM SUPPLY AIR. PROVIDE 12"x10" TRANSFER AIR DUCTS FOR SPACES WITH SUPPLY AIR QUANTITIES BETWEEN 150 CFM AND 435 CFM. PROVIDE 18"x10" TRANSFER AIR DUCTS FOR SPACES WITH SUPPLY AIR QUANTITIES BETWEEN 435 CFM AND 660 CFM. FOR SPACES WITH GREATER THAN 660 CFM SUPPLY AIR, PROVIDE MULTIPLE
- 5. REFER TO FLOOR PLANS FOR LOCATIONS OF SOUND ATTENUATORS IN TRANSFER DUCTS.


1 RETURN AIR/TRANSFER DUCT WITH ELBOWS M5.02 NOT TO SCALE

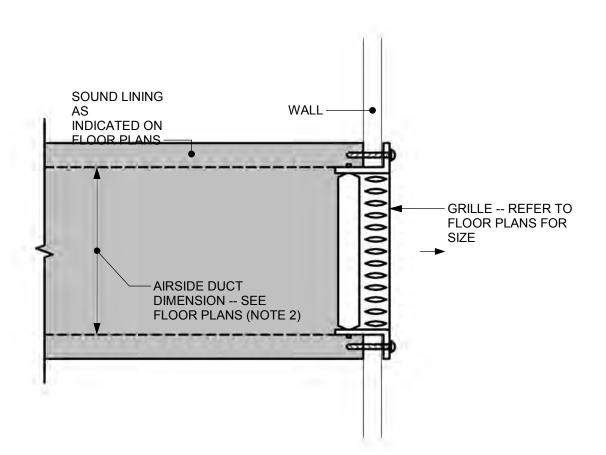

- 1. DOUBLE DEFLECTION SUPPLY GRILLE SHOWN, SINGLE DEFLECTION RETURN AND TRANSFER GRILLES (RGA, RRA, RGA-0) SIMILAR.
- 2. TRANSITION DUCT TO GRILLE AS NECESSARY.


AIR DEVICE TYPE (SGA, SRA) - SIDEWALL GRILLE MOUNTING IN SOUND LINED DUCT

M5.02 NOT TO SCALE

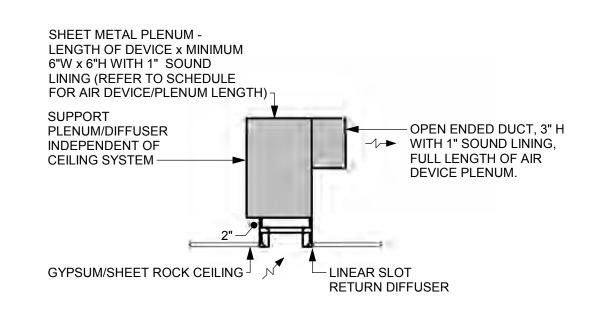

1. TYPE (FLD-R) SHOWN, TYPES (LBR) AND (LR) SIMILAR.


T LINEAR RETURN AIR DEVICE IN PLENUM CEILINGS (TYPE FLD-R)

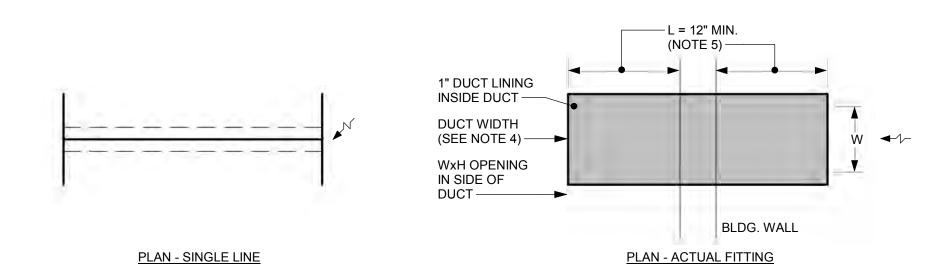


- 1. USE MINIMUM 22 GAUGE OR SMACNA GAUGE (WHICHEVER IS GREATER) SHEET METAL FOR CONSTRUCTION AND LINE WITH 1" THICK SOUND LINING.
- 2. SUSPEND RETURN AIR/TRANSFER DUCT FROM FLOOR SLAB STRUCTURE ABOVE FINISHED CEILING.
- 3. CONFIGURATION VARIES FROM ROOM TO ROOM. SEE FLOOR PLANS FOR LOCATIONS AND CONFIGURATION.
- 4. REFER TO FLOOR PLANS FOR SIZE OF DUCT.
- 5. FOR TRANSFER DUCTS WITH GRILLES AT WALLS, LENGTH OF OPEN ENDED DUCT FROM BUILDING (L) SHALL INCREASE TO 24". REFER TO FLOOR PLANS FOR LOCATION OF TRANSFERS WITH GRILLES.

RETURN AIR/TRANSFER DUCT WITHOUT ELBOWS

M5.02 NOT TO SCALE

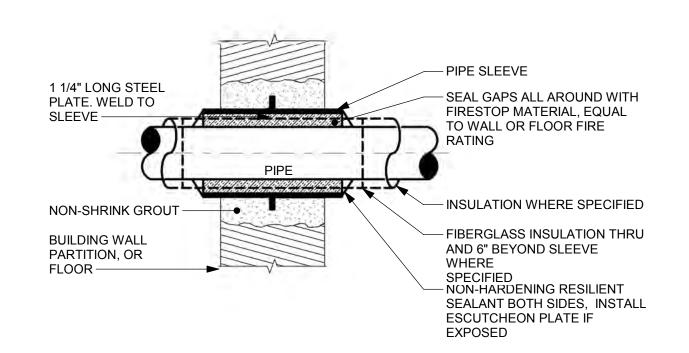


MASONRY WALL AND FLOOR PENETRATION M5.02 NOT TO SCALE

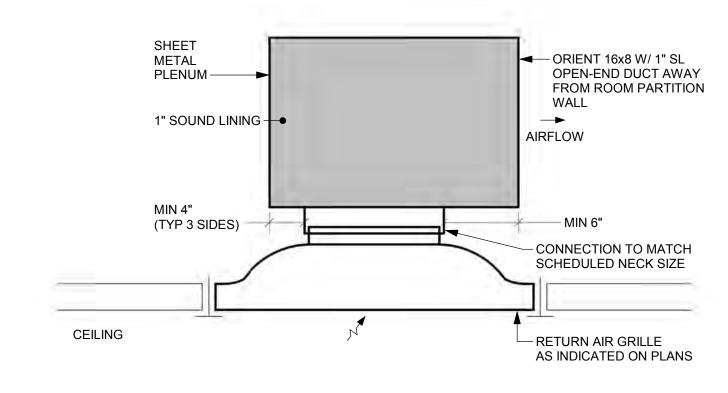

NOTE: 1. AIR DEVICE TYPE (CR) SHOWN, TYPE (RR) SIMILAR.

RETURN AIR DEVICE IN PLENUM CEILINGS (TYPE CR)

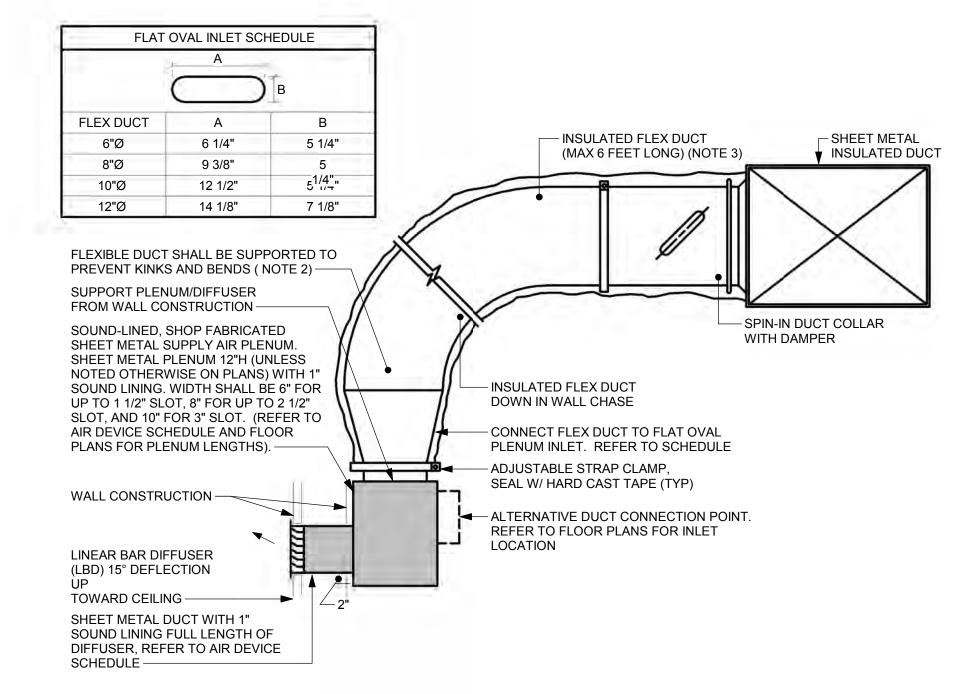


NOTES:

- 1. RECTANGULAR DUCT SHOWN: ROUND DUCT SIMILAR, WITH VOLUME DAMPER AFTER LOW TOSS TEE OFF SUPPLY MAIN.
- 2. WHERE INDICATED ON PLANS PROVIDE RECTANGULAR DUCT RUNOUTS OF SIZE INDICATED WITH VD.
- 3. SEE SCHEDULE THIS DRAWING FOR SIZE.

3 AIR DEVICE TYPE (LBD)

M5.02 NOT TO SCALE

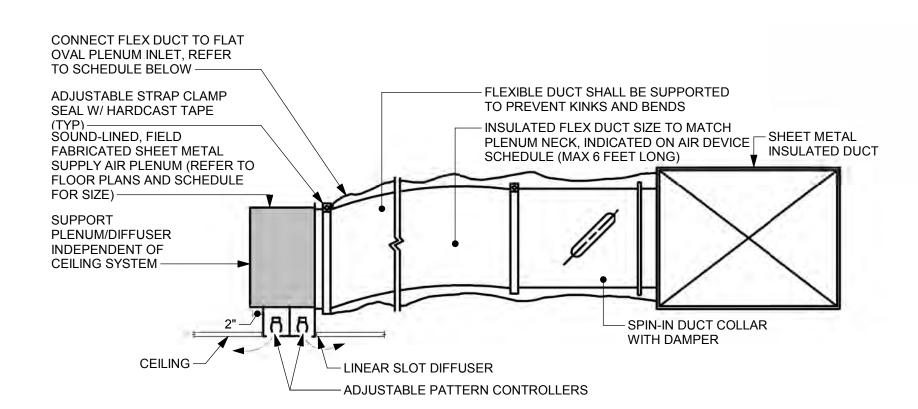


- 1. RECTANGULAR DUCT SHOWN; ROUND DUCT SIMILAR, WITH VOLUME DAMPER AFTER LOW LOSS TEE OFF SUPPLY MAIN.
- 2. AIR DEVICE TYPE (LS) SHOWN, (PSD) SIMILAR EXCEPT FACTORY FABRICATED PLENUM IS PROVIDED BY AIR DEVICE

MANUFACTURER AND DEVICE DESIGNED FOR LAY-IN CEILINGS.

FLAT (OVAL INLET SCH	EDULE B
FLEX DUCT	A	В
6"Ø	6 1/4"	5 1/4"
8"Ø	9 3/8"	5
10"Ø	12 1/2"	51/4",
12"Ø	14 1/8"	7 1/8"

6 LINEAR SLOT AIR DEVICE TYPE (LS)

M5.02 NOT TO SCALE

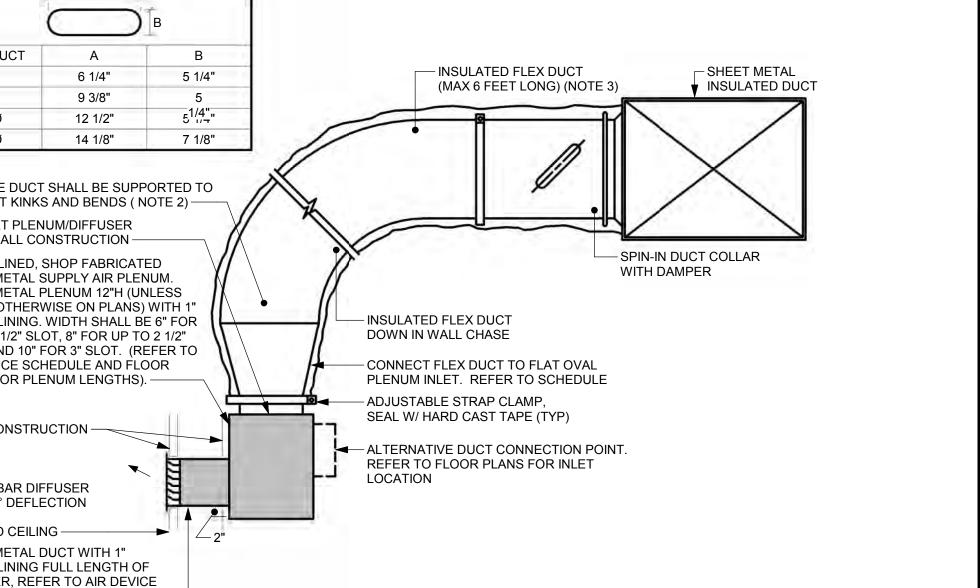

11

410.467.2377 www.morabitoconsultants.com **CIVIL ENGINEER**

300 EAST JOPPA ROAD, SUITE 200 BALTIMORE, MD 21286

PROJECT INFORMATION

PROJECT TEAM

ARCHITECT

AYERS SAINT GROSS

1040 HULL STREET, SUITE 100

BALTIMORE, MD 21230

410.347.8500

www.asg-architects.com

M/E/P & FIRE PROTECTION ENGINEER

MUELLER ASSOCIATES

1306 CONCOURSE DRIVE, SUITE 100

LINTHICUM, MD 21090

410.646.4500

www.muellerassoc.com

STRUCTURAL ENGINEER

MORABITO CONSULTANTS

952 RIDGEBROOK ROAD, SUITE 1700 SPARKS, MD 21152

410.512.4500 www.wbcm.com LANDSCAPE ARCHITECT

AYERS SAINT GROSS 1040 HULL STREET, SUITE 100 BALTIMORE, MD 21230 410.347.8500

www.asg-architects.com IT / AV / SECURITY

SPEXSYS


KIBART


7257 PARKWAY DRIVE, SUITE 260 HANOVER, MD 21076 410.712.0390 www.spexsys.com COMMISSIONING

901 DULANEY VALLEY ROAD, SUITE 301 TOWSON, MD 21204 410.494.1111 www.kibart.com

CODE CONSULTANT KOFFEL ASSOCIATES 8815 CENTRE PARK DRIVE, SUITE 200 COLUMBIA, MD 21045 410.750.2246 www.koffel.com

REVISIONS			
REV.#	DESCRIPTION	DATE	
	KEY PLAN		

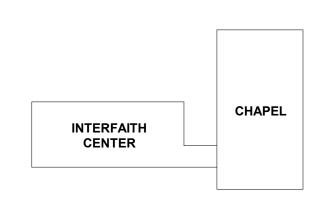

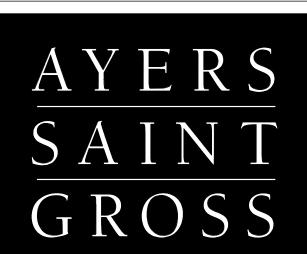

ARCHITECTS + PLANNERS

NOT FOR CONSTRUCTION

DRAWING INFO	ORMATION
ISSUE DATE:	04/28/17
SCALE:	1/8" = 1'-0"
JOB NO.:	21641.00
DRAWN BY:	СВН
PROJECT DESI	GN PHASE


50% CONSTRUCTION

DRAWING NAME

DETAILS


DOCUMENTS

DRAWING NUMBER M5.02

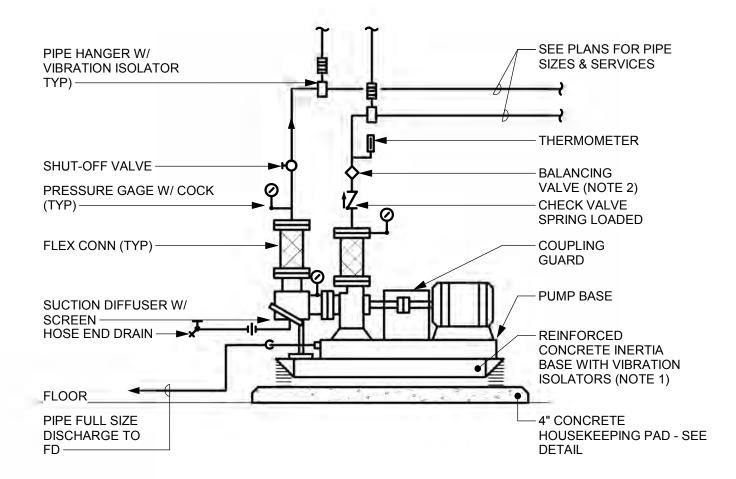

- 1. INERTIA BASE SHALL BE OF SUFFICIENT LENGTH TO SUPPORT PUMP & SUCTION DIFFUSER. DIFFUSER SUPPORTED FROM FLOOR OR HOUSEKEEPING PAD IS NOT ACCEPTABLE.
- 2. ON PUMPS WITH VARIABLE FREQUENCY CONTROLLERS, PROVIDE SHUT-OFF VALVE IN LIEU OF BALANCING VALVE.

BASE MOUNTED END SUCTION PUMP M5.03 NOT TO SCALE

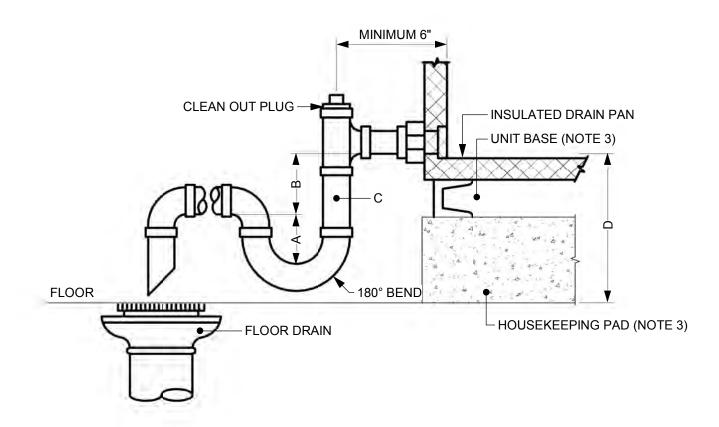


	PI	PE SCHEDU	LE	
ЛИТ #		PIPE SIZE	(INCHES)	
AHU#	Α	В	С	D


- 1. FOR DRAW THRU TRAPS: "B" = FAN INLET PRESSURE PLUS 1 INCH, "A" = B/2
- 2. FOR BLOW THRU TRAPS: "B" = 1 INCH, "A" = FAN OUTLET PRESSURE PLUS 1/2 INCH. 3. BOTTOM OF CONDENSATE DRAIN PAN CONNECTION SHALL BE MINIMUM "D" ABOVE FINISHED FLOOR - INCREASE UNIT BASE HEIGHT ACCORDINGLY. HOUSEKEEPING

PAD HEIGHT SHALL NOT EXCEED 6" WITHOUT WRITTEN APPROVAL FROM THE ARCHITECT.


INDOOR COOLING COIL CONDENSATE DRAIN

M5.03 NOT TO SCALE

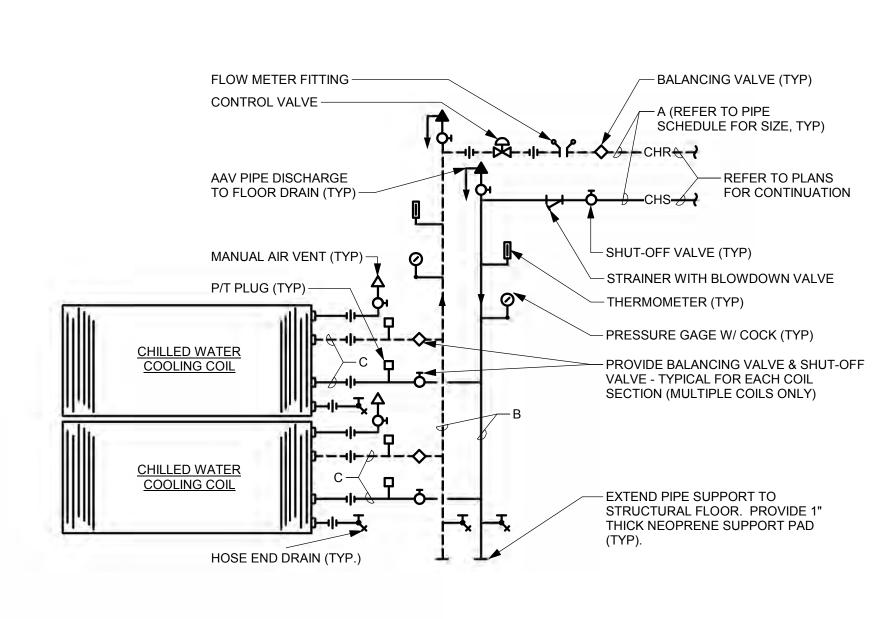

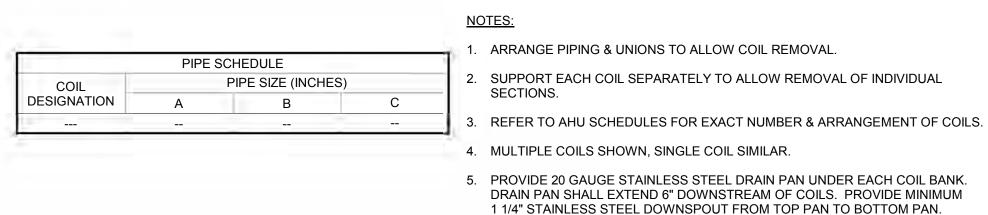



5 MULTIPLE CHILLED WATER COOLING COILS

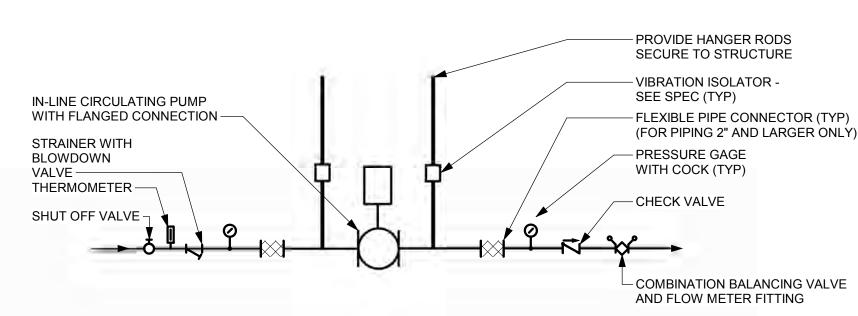

2 IN-LINE CIRCULATING PUMP M5.03 NOT TO SCALE

5

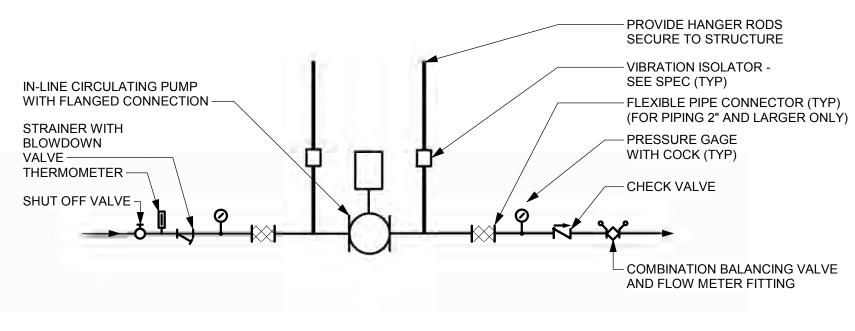

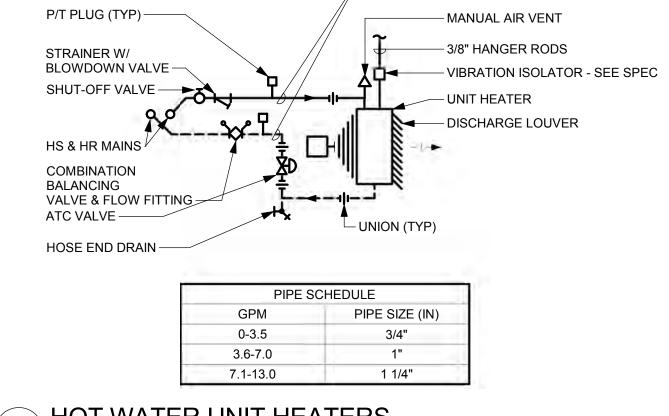


- REFER TO PIPE SCHEDULE

FOR PIPE SIZE

11

3 HOT WATER UNIT HEATERS

M5.03 NOT TO SCALE

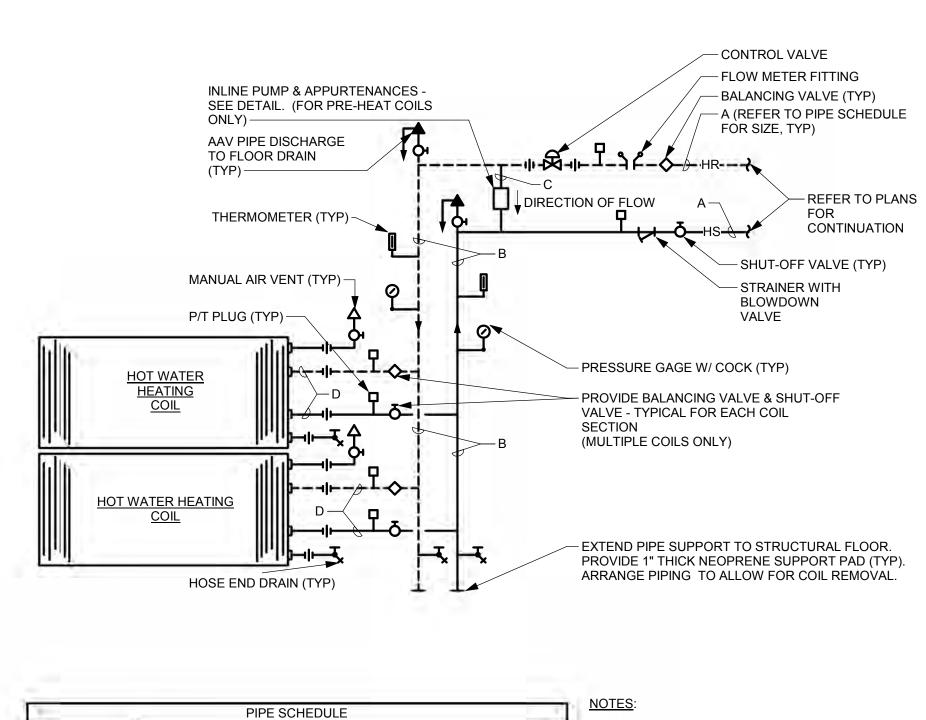

ARRANGE PIPING & UNIONS TO ALLOW COIL REMOVAL.

- SUPPORT EACH COIL SEPARATELY TO ALLOW REMOVAL OF INDIVIDUAL SECTIONS.
- 3. REFER TO AHU SCHEDULES FOR EXACT NUMBER & ARRANGEMENT OF COILS.

4. MULTIPLE COILS SHOWN, SINGLE COIL SIMILAR.

PIPE SIZE (INCHES)

6 MULTIPLE HEATING HOT WATER COILS M5.03 NOT TO SCALE

DESIGNATION

www.koffel.com REVISIONS DESCRIPTION

PROJECT INFORMATION

PROJECT TEAM

ARCHITECT

AYERS SAINT GROSS

1040 HULL STREET, SUITE 100

BALTIMORE, MD 21230

410.347.8500

www.asg-architects.com

M/E/P & FIRE PROTECTION ENGINEER

MUELLER ASSOCIATES

1306 CONCOURSE DRIVE, SUITE 100

LINTHICUM, MD 21090

410.646.4500

www.muellerassoc.com

STRUCTURAL ENGINEER

MORABITO CONSULTANTS

952 RIDGEBROOK ROAD, SUITE 1700 SPARKS, MD 21152

410.467.2377

CIVIL ENGINEER

300 EAST JOPPA ROAD, SUITE 200 BALTIMORE, MD 21286

> 410.512.4500 www.wbcm.com

LANDSCAPE ARCHITECT AYERS SAINT GROSS 1040 HULL STREET, SUITE 100 BALTIMORE, MD 21230 410.347.8500 www.asg-architects.com

IT / AV / SECURITY SPEXSYS 7257 PARKWAY DRIVE, SUITE 260 HANOVER, MD 21076 410.712.0390

www.spexsys.com


COMMISSIONING KIBART 901 DULANEY VALLEY ROAD, SUITE 301 TOWSON, MD 21204 410.494.1111 www.kibart.com


> CODE CONSULTANT KOFFEL ASSOCIATES

8815 CENTRE PARK DRIVE, SUITE 200 COLUMBIA, MD 21045

410.750.2246

www.morabitoconsultants.com

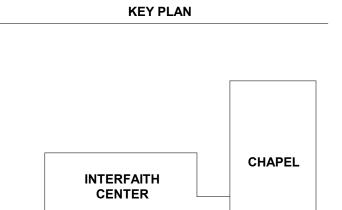

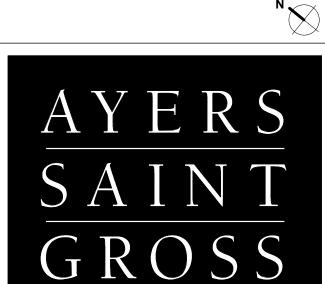

ARCHITECTS + PLANNERS

NOT FOR CONSTRUCTION

DRAWING INFO	ORMATION
ISSUE DATE:	04/25/17
SCALE:	1/8" = 1'-0"
JOB NO.:	21641.00
DRAWN BY:	СВН
PROJECT DES	IGN PHASE

50% CONSTRUCTION DOCUMENTS

DETAILS

DRAWING NAME

DRAWING NUMBER M5.03

AIR HANDLING UNITS COOLING COIL GENERAL FANS **HEATING COIL** FILTERS **QUANTITY & QUANTITY & TOTAL AIRFLOW** LAT MAX APD MIN ROWS/ EAT LAT APPROX SIZE WXH VELOCITY APD SENSIBLE/TOTAL MAX FACE WATER MAX FACE VELOCITY (FPM) (IN W.G.) EWT (°F) LWT (°F) WATER FLOWRATE (GPM) (FT HD) (SEE SCHEDULE) MIN ROWS/ EWT LWT FLOWRATE (°F) (°F) (GPM) (FT HD) **APPROX SIZE WxH** CAPACITY (°F) (°F) (CFM) LOCATION INTERNAL S.P. (IN WG) DESIG SERVICE DESIG DESIG AIRFLOW CAPACITY VELOCITY MAX FPI (°F) (°F) (IN) OR TOTAL AREA (SF) (SEE SPEC) SCHEDULE) MAX FPI (IN) OR TOTAL (MBH) (IN W.G.) (CFM) (FPM) AREA (SF) MAX MIN DB WB DB WB 0.17 180 160 12.4 5.5 PF-1 0 74.7 PHC-1 121 3.4 1500 5.37 F-SA-1 CC-1 22.0 AHU-1 MECHANICAL ROOM | BUILDING VENTILATION | 1500 67.9/131.8 3.4 1.0 RHC-1 0.10 180 160 4.4 0.4 FF-1 43.2 53.0 79.6 441

NOTES:

3. BALANCE PRE-HEAT COIL FOR GPM SCHEDULED WHILE ACHIEVING SCHEDULED GPM TO BE BETWEEN 3 FPS AND 5 FPS. NOTE PUMP FLOW RATE PLUS SYSTEM FLOW RATE EQUALS SYSTEM FLOW RATE EQUALS SYSTEM FLOW RATE THROUGH CONTROL VALVE AT FULL OPEN POSITION.

1. COIL CAPACITIES SHALL BE BASED ON AHU OPERATING AT SCHEDULED MAXIMUM TOTAL AIRFLOW WITH SCHEDULED MINIMUM OCCUPIED OUTSIDE AIR.

2. UNIT INTERNAL STATIC PRESSURE DROP INCLUDES ALLOWANCE FOR SYSTEM EFFECTS, UNIT DAMPER LOSSES, AND 0.5" FOR FILTER LOADING.

											FAN COII	L UNITS												
NOTES: 1. EXTERNAL S	TATIC PRESSURE	E IS FOR EXTERNAL COMPO	NENTS ONLY AN	ND DOES NOT INCLUDE	INTEGRAL UNI	T INLET GRILLE,	DISCHARGE G	GRILLE, AND FILT	ΓER.															
			NOMINAL AIR	EXTERNAL STATIC				COOLING	CAPACITY						HEATING	CAPACITY			MOT	TOR		ELECTRICAL		
DESIG	SPEC TYPE	LOCATION	NOMINAL AIR FLOWRATE (CFM)	EXTERNAL STATIC PRESSURE (IN-WG) (NOTE 1)	TOTAL (BTUH)	SENS. (BTUH)	ENTERIN DB	COOLING IG AIR (°F) WB	EWT (°F)	LWT (°F)	WATER FLOWRATE	MAX WPD (FT HD)	TOTAL (BTUH)	ENTERING AIR DB (°F)	HEATING EWT (°F)	CAPACITY LWT (°F)	WATER FLOWRATE	MAX WPD (FT HD)	MO ¹ BHP	TOR MHP	VOLTS	ELECTRICAL PH	HZ	REMARKS
DESIG FCU-4HC-C		LOCATION SEE MECHANICAL PLANS	FLOWRATE (CFM)	PRESSURE (IN-WG)				IG AIR (°F)		LWT (°F)								MAX WPD (FT HD)					HZ	REMARKS
	HC	LOCATION	FLOWRATE (CFM) 400	PRESSURE (IN-WG) (NOTE 1)	(BTUH)	(BTUH)		IG AIR (°F) WB		LWT (°F) 56 56		(FT HD)	(BTUH)		EWT (°F)		FLOWRATE	(FT HD)		МНР	VOLTS			REMARKS
FCU-4HC-C	HC HC	SEE MECHANICAL PLANS	FLOWRATE (CFM) 400 600	PRESSURE (IN-WG) (NOTE 1) 0.50	(BTUH) 9666	(BTUH) 4320		WB 63		LWT (°F) 56 56 56		(FT HD) 13.3	(BTUH) 14927		EWT (°F)	LWT (°F)	FLOWRATE 1.5	(FT HD) 1.4		MHP 1/12	VOLTS		-6 0	REMARKS
FCU-4HC-C FCU-6HC-C	HC HC HC	SEE MECHANICAL PLANS SEE MECHANICAL PLANS	FLOWRATE (CFM) 400 600	PRESSURE (IN-WG) (NOTE 1) 0.50 0.50	(BTUH) 9666 14646	(BTUH) 4320 8996	DB 75 75	NG AIR (°F) WB 63 63		LWT (°F) 56 56 56 56		(FT HD) 13.3 3.8	(BTUH) 14927 21996		EWT (°F) 180 180	LWT (°F) 160 160	1.5 2.2	(FT HD) 1.4 3.4		MHP 1/12 1/12	120 120		6 0	REMARKS

	EXPA	NSION TANKS	
DESIG	LOCATION	SERVICE	REMARKS
ET-CHW	MECHANICAL ROOM	CHILLED WATER SYSTEM	
ET-HW	MECHANICAL ROOM	HEATING HOT WATER SYSTEM	

						F	PUMPS								
	TYPE (SEE			WATER	HEAD (FT	APPROXIMATE	SUCTION X	MIN PUMP EFF.					ELECTRICAL		
DESIG	SPEC)	LOCATION	SERVICE	FLOWRATE (GPM)	HD)	IMPELLER DIAMETER (IN)	DISCHARGE (IN)	(%)	SPEED (RPM)	ВНР	MOTOR HP	VOLTS	PH	HZ	REMARKS
P-CHW-1		MECHANICAL ROOM	CHILLED WATER SYSTEM	70.0	70.0	0' - 8 1/8"	2.5 x 2	50	1750	2.14	5	208 V	3	60	
P-CHW-2		MECHANICAL ROOM	CHILLED WATER SYSTEM	70.0	70.0	0' - 8 1/8"	2.5 x 2	50	1750	2.14	5	208 V	3	60	
P-HHW-1		MECHANICAL ROOM	HEATING HOT WATER SYSTEM	40.0	50.0	0' - 6 3/4"	1.5 x 1.25	55	1750	0.82	1.5	208 V	3	60	
P-HHW-2		MECHANICAL ROOM	HEATING HOT WATER SYSTEM	40.0	50.0	0' - 6 3/4"	1.5 x 1.25	55	1750	0.82	1.5	208 V	3	60	
P-PHC-1		MECHANICAL ROOM	PHC-1	6.2	30.0	0' - 3 13/16"	1.5 x 1.5	36	3250			120 V	1	60	

						FANS							
DESIG	TYPE	SERVICE		LOW FM)	TOTAL STATIC PRESSURE (IN	WHEEL DIAMETER	SPEED	ВНР	MOTOR		ELECTRICAL		REMARKS
	(SEE SPEC)		MAX	MIN	WG)	(IN)	(RPM)		HP	VOLTS	PH	HZ	
EF-1		KITCHEN EXHAUST	150	150	1.0	6.75	1350			120	1	60	
EF-2		MECH RM EXHAUST	350	350	1.0	11.2	2500	0.45	1/2	120	1	60	
EF-3		TOILET RM 006 EXHAUST	105	150	0.8	7.9	1050			120	1	60	
EF-4		TOILET RM 007 EXHAUST	115	115	0.8	7.9	1050			120	1	60	
EF-5		TOILET RM 105 EXHAUST	95	95	0.8	7.9	1050			120	1	60	
EF-6		TOILET RM 106 EXHAUST	95	95	0.8	7.9	1050			120	1	60	
EF-7		JANITOR CLOSET 009	50	50	0.8	7.9	950			120	1	60	
EF-8	Т	OILET RM C103 EXHAUST	75	75	0.8	7.9	950			120	1	60	
EF-9	Т	OILET RM C105 EXHAUST	75	75	0.8	7.9	950			120	1	60	
F-SA-1	PL	AHU-1	1500	1500	5.4	9	4041	2.17	3	208	3	60	

					AIR CO	OLED C	ONDENS	SING UNI	TS			
			NOMINAL		EVAPORATOR	COND	ENSER			ELECTRICAL		
DESIG	TYPE (SEE SPEC)	LOCATION	COOLING CAPACITY (TONS)	MAX AMPS @ FULL LOAD	AMB TEMP DB/WB (°F)	AMB TEMP DB/WB (°F)	NUMBER OF CIRCUITS	R QUANTITY	VOLTS	PH	HZ	REMARKS
ACCU-1			1.5	12	75/63	95/78	1	1	208	1	60	B.O.D. MITSHUBISHI PUYA18NHA6

					FIL	TERS			
DESIG	TYPE (SEE SPEC)	LOCATION	SERVICE	MERV	MAX FACE VELOCITY (FPM)	DEPTH (IN)	INITIAL / FINAL APD (IN WG)	QUANTITY & APPROX SIZE LxW (IN) OR AREA (SF)	REMARKS
PF-1	PF	AHU-1	PRE-FILTER	8	455	2	.23/.27	3.3	
FF-1	FF	AHU-1	FINAL FILTER	13	455	12	.45/.55	3.3	

				AIR	CONDI	TIONERS	<u> </u>				
	TYPE (SEE			TOTAL	SENSIBLE	AIRFLOW		ELECTRICA	AL		
DESIG	SPEC)	LOCATION	SERVICE	COOLING (MBH)	COOLING (MBH)	RATE (CFM)	FLA	VOLTS	PH	HZ	REMARKS
ACU-1		TELECOM CLOSET	TELECOM CLOSET	18.0	14.0	400	1	208	1	60	B.O.D. MITSHUBISHI PKA-A18HA6

				PRIMAR	Y WATER	(CAMPU	S LOOP)	SECONDARY W	ATER (BI	JILDING)		
DESIG	SERVICE	LOCATION	CAPACITY (MBH)	FLOWRATE (GPM)	EWT (°F)	LWT (°F)	MAX WPD (PSI)	FLOWRATE (GPM)	EWT (°F)	LWT (°F)	MAX WPD (PSI)	BASIS OF DESIGN
HX-CHW-1	CHILLED WATER	MECHANICAL ROOM	421.8	70	42	54	10	70	56	44	10	B&G AP64

				AIF	R DEVICES			
DESIG	TYPE	SERVICE		W RANGE	NOMINAL SIZE (IN)	INLET/NECK		
D 20.0	(SEE SPEC)	OLIVIOL	MIN CFM	MAX CFM		SIZE (IN)	BASIS OF DESIGN	REMARKS
1	LBG	SUPPLY	0	95	6 x 4	6 x 4	TITUS 300RL SERIES	
2	LR	RETURN	120	300	(2) 3/4" SLOTS 48" LENGTH	6"	TITUS TBR SERIES	
3	CD	SUPPLY	0	100	24 x 24	6"ø	TITUS OMNI SERIES	
4	CR	RETURN	105	205	24 x 24	8"ø	TITUS OMNI SERIES	
5	LS	SUPPLY	0	50	(2) 3/4" slots	4" WIDTH	TITUS ML SERIES	AIRFLOW RANGE IS IN CFM/
6	LS	SUPPLY	0	50	(2) 3/4" slots	4" WIDTH	TITUS CT SERIES	AIRFLOW RANGE IS IN CFM/
7	CR	RETURN	0	200	24 x 24	8"ø	TITUS OMNI	
8	LS	SUPPLY	50	90	(2) 3/4" SLOTS 24" LENGTH	8"ø	TITUS TBD SERIES	
9	LS	SUPPLY	90	170	(2) 3/4" SLOTS 48" LENGTH	8"ø	TITUS TBD SERIES	

		HOT W	ATER PRO	PELLER A	ND CABI	NET UNI	Г НЕАТЕ	ERS		
	TVDE		MINI CADACITY	AIDEL OW	WATER	MAY MOD		ELECTRICAL		
DESIG	TYPE (SEE SPEC)	LOCATION	MIN CAPACITY (MBH)	AIRFLOW (CFM)	FLOWRATE (GPM)	MAX WPD (FT HD)	LOAD (VA)	VOLTS (V)	PH	REMARKS
CUH-1		MECHANICAL ROOM	30.0	800	5.0	0.0	300.0	120	1	
CUH-2		MECHANICAL ROOM	31.0	800	5.2	0.0	300.0	120	1	
UH-1		MECHANICAL ROOM	26.5	350	2.6	0.0	150.0	120	1	
UH-2		MECHANICAL ROOM	40.8	600	4.1	0.0	150.0	120	1	

		AIR SEPARA	TORS				
DESIG	LOCATION	SERVICE	SIZE (INLET X OUTLET) (IN)	FLOW RATE (GPM)	VOLUME (GAL)	NOTES	
AS-CHW	MECHANICAL ROOM	CHILLED WATER SYSTEM		70.0	7.0		7 1
AS-HW	MECHANICAL ROOM	HEATING HOT WATER SYSTEM		40.0	7.0		7

GOUCHER —college—

PROJECT INFORMATION

11

PROJECT TEAM

ARCHITECT
AYERS SAINT GROSS
1040 HULL STREET, SUITE 100
BALTIMORE, MD 21230
410.347.8500
www.asg-architects.com

M/E/P & FIRE PROTECTION ENGINEER

MUELLER ASSOCIATES

1306 CONCOURSE DRIVE, SUITE 100

LINTHICUM, MD 21090

410.646.4500

www.muellerassoc.com

STRUCTURAL ENGINEER

MORABITO CONSULTANTS

952 RIDGEBROOK ROAD, SUITE 1700

SPARKS, MD 21152

410.467.2377

410.467.2377 www.morabitoconsultants.com CIVIL ENGINEER

WBCM 300 EAST JOPPA ROAD, SUITE 200 BALTIMORE, MD 21286 410.512.4500 www.wbcm.com

AYERS SAINT GROSS
1040 HULL STREET, SUITE 100
BALTIMORE, MD 21230

BALTIMORE, MD 21230 410.347.8500 www.asg-architects.com

7257 PARKWAY DRIVE, SUITE 260 HANOVER, MD 21076 410.712.0390 www.spexsys.com

COMMISSIONING


SPEXSYS


KIBART 901 DULANEY VALLEY ROAD, SUITE 301 TOWSON, MD 21204 410.494.1111 www.kibart.com

CODE CONSULTANT

KOFFEL ASSOCIATES
8815 CENTRE PARK DRIVE, SUITE 200
COLUMBIA, MD 21045
410.750.2246
www.koffel.com

	REVISIONS	
REV.#	DESCRIPTION	DATE
	KEY PLAN	

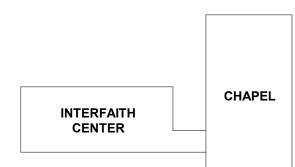

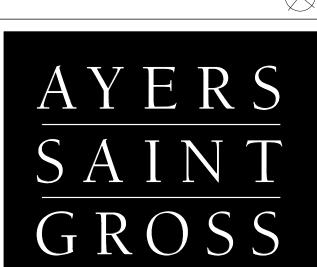

ARCHITECTS + PLANNERS

NOT FOR CONSTRUCTION

DRAWING INFORMATION	ON
ISSUE DATE:	04/28/17
SCALE:	12" = 1'-0"
JOB NO.:	21641.00
DRAWN BY:	СВН
PROJECT DESIGN PHA	SE

50% CONSTRUCTION DOCUMENTS

DRAWING NAME

SCHEDULES

DRAWING NUMBER

M6.01

DRAWING NOTES:

- A. REFER TO DRAWING M0.01 FOR LEGEND, ABBREVIATIONS AND DRAWING
- B. EXISTING CONDITIONS SHOWN ARE BASED ON LIMITED FIELD SURVEY AND EXISTING DOCUMENTATION. CONTRACTOR SHALL FIELD VERIFY ALL CONDITIONS, INDICATED OR OTHERWISE.

11

- C. UNLESS OTHERWISE NOTED, PIPING AND DUCTWORK SHOWN IS CONCEALED ABOVE CEILING.
- D. COORDINATE ALL DEMOLITION WORK WITH NEW WORK CONSTRUCTION.

SPECIAL NOTES:

- 1 COMBINATION WATER SERVICE UP THROUGH SLAB. LOCATE MINIMUM OF 48" BELOW FINISHED GRADE TO TOP OF PIPE. REFER TO DETAIL FOR CONTINUATION.
- 2 REFER TO CIVIL PLANS FOR CONTINUATION.
- 3 SAN FROM TO FLOOR/TRENCH DRAIN.
- 4 SAN THROUGH SLAB FROM FIXTURE(S) ON FLOOR ABOVE.
- 5 SAN THROUGH SLAB FROM FLOOR ABOVE.
- 6 SW FROM DOWNSPOUT BOOT.
- 7 SW FROM FLOOR DRAIN.
- 8 SWPD FROM ELEVATOR PIT SUMP PUMP WITH CHECK AND SHUT-OFF VALVES IN VERTICAL. PROVIDE PUMP IN 24" SQUARE BY 36" DEEP BASIN INTEGRAL WITH CONCRETE PIT. REFER TO DETAIL.
- 9 UP TO FLOOR CLEANOUT
- 10 VP UP THROUGH SLAB FROM SAN.

PROJECT INFORMATION

PROJECT TEAM

ARCHITECT AYERS SAINT GROSS 1040 HULL STREET, SUITE 100 BALTIMORE, MD 21230 410.347.8500

www.asg-architects.com M/E/P & FIRE PROTECTION ENGINEER MUELLER ASSOCIATES 1306 CONCOURSE DRIVE, SUITE 100 LINTHICUM, MD 21090 410.646.4500

STRUCTURAL ENGINEER MORABITO CONSULTANTS 952 RIDGEBROOK ROAD, SUITE 1700 SPARKS, MD 21152

www.muellerassoc.com

410.467.2377 www.morabitoconsultants.com

CIVIL ENGINEER

300 EAST JOPPA ROAD, SUITE 200 BALTIMORE, MD 21286 410.512.4500 www.wbcm.com

LANDSCAPE ARCHITECT AYERS SAINT GROSS 1040 HULL STREET, SUITE 100 BALTIMORE, MD 21230 410.347.8500

> www.asg-architects.com IT / AV / SECURITY SPEXSYS

7257 PARKWAY DRIVE, SUITE 260 HANOVER, MD 21076 410.712.0390 www.spexsys.com

> COMMISSIONING KIBART

901 DULANEY VALLEY ROAD, SUITE 301 TOWSON, MD 21204 410.494.1111 www.kibart.com

CODE CONSULTANT KOFFEL ASSOCIATES 8815 CENTRE PARK DRIVE, SUITE 200 COLUMBIA, MD 21045 410.750.2246 www.koffel.com

KEY PLAN

INTERFAITH CENTER

ARCHITECTS + PLANNERS

GROSS

NOT FOR CONSTRUCTION

ISSUE DATE: 1/8" = 1'-0" JOB NO.: DRAWN BY:

PROJECT DESIGN PHASE **50% CONSTRUCTION**

DOCUMENTS DRAWING NAME


FLOOR PLAN - FOUNDATION PLUMBING

DRAWING NUMBER

IF DRAWING IS REDUCED,
USE GRAPHIC SCALE
8' 0' 4'

1/8" = 1'-0"

P2.00

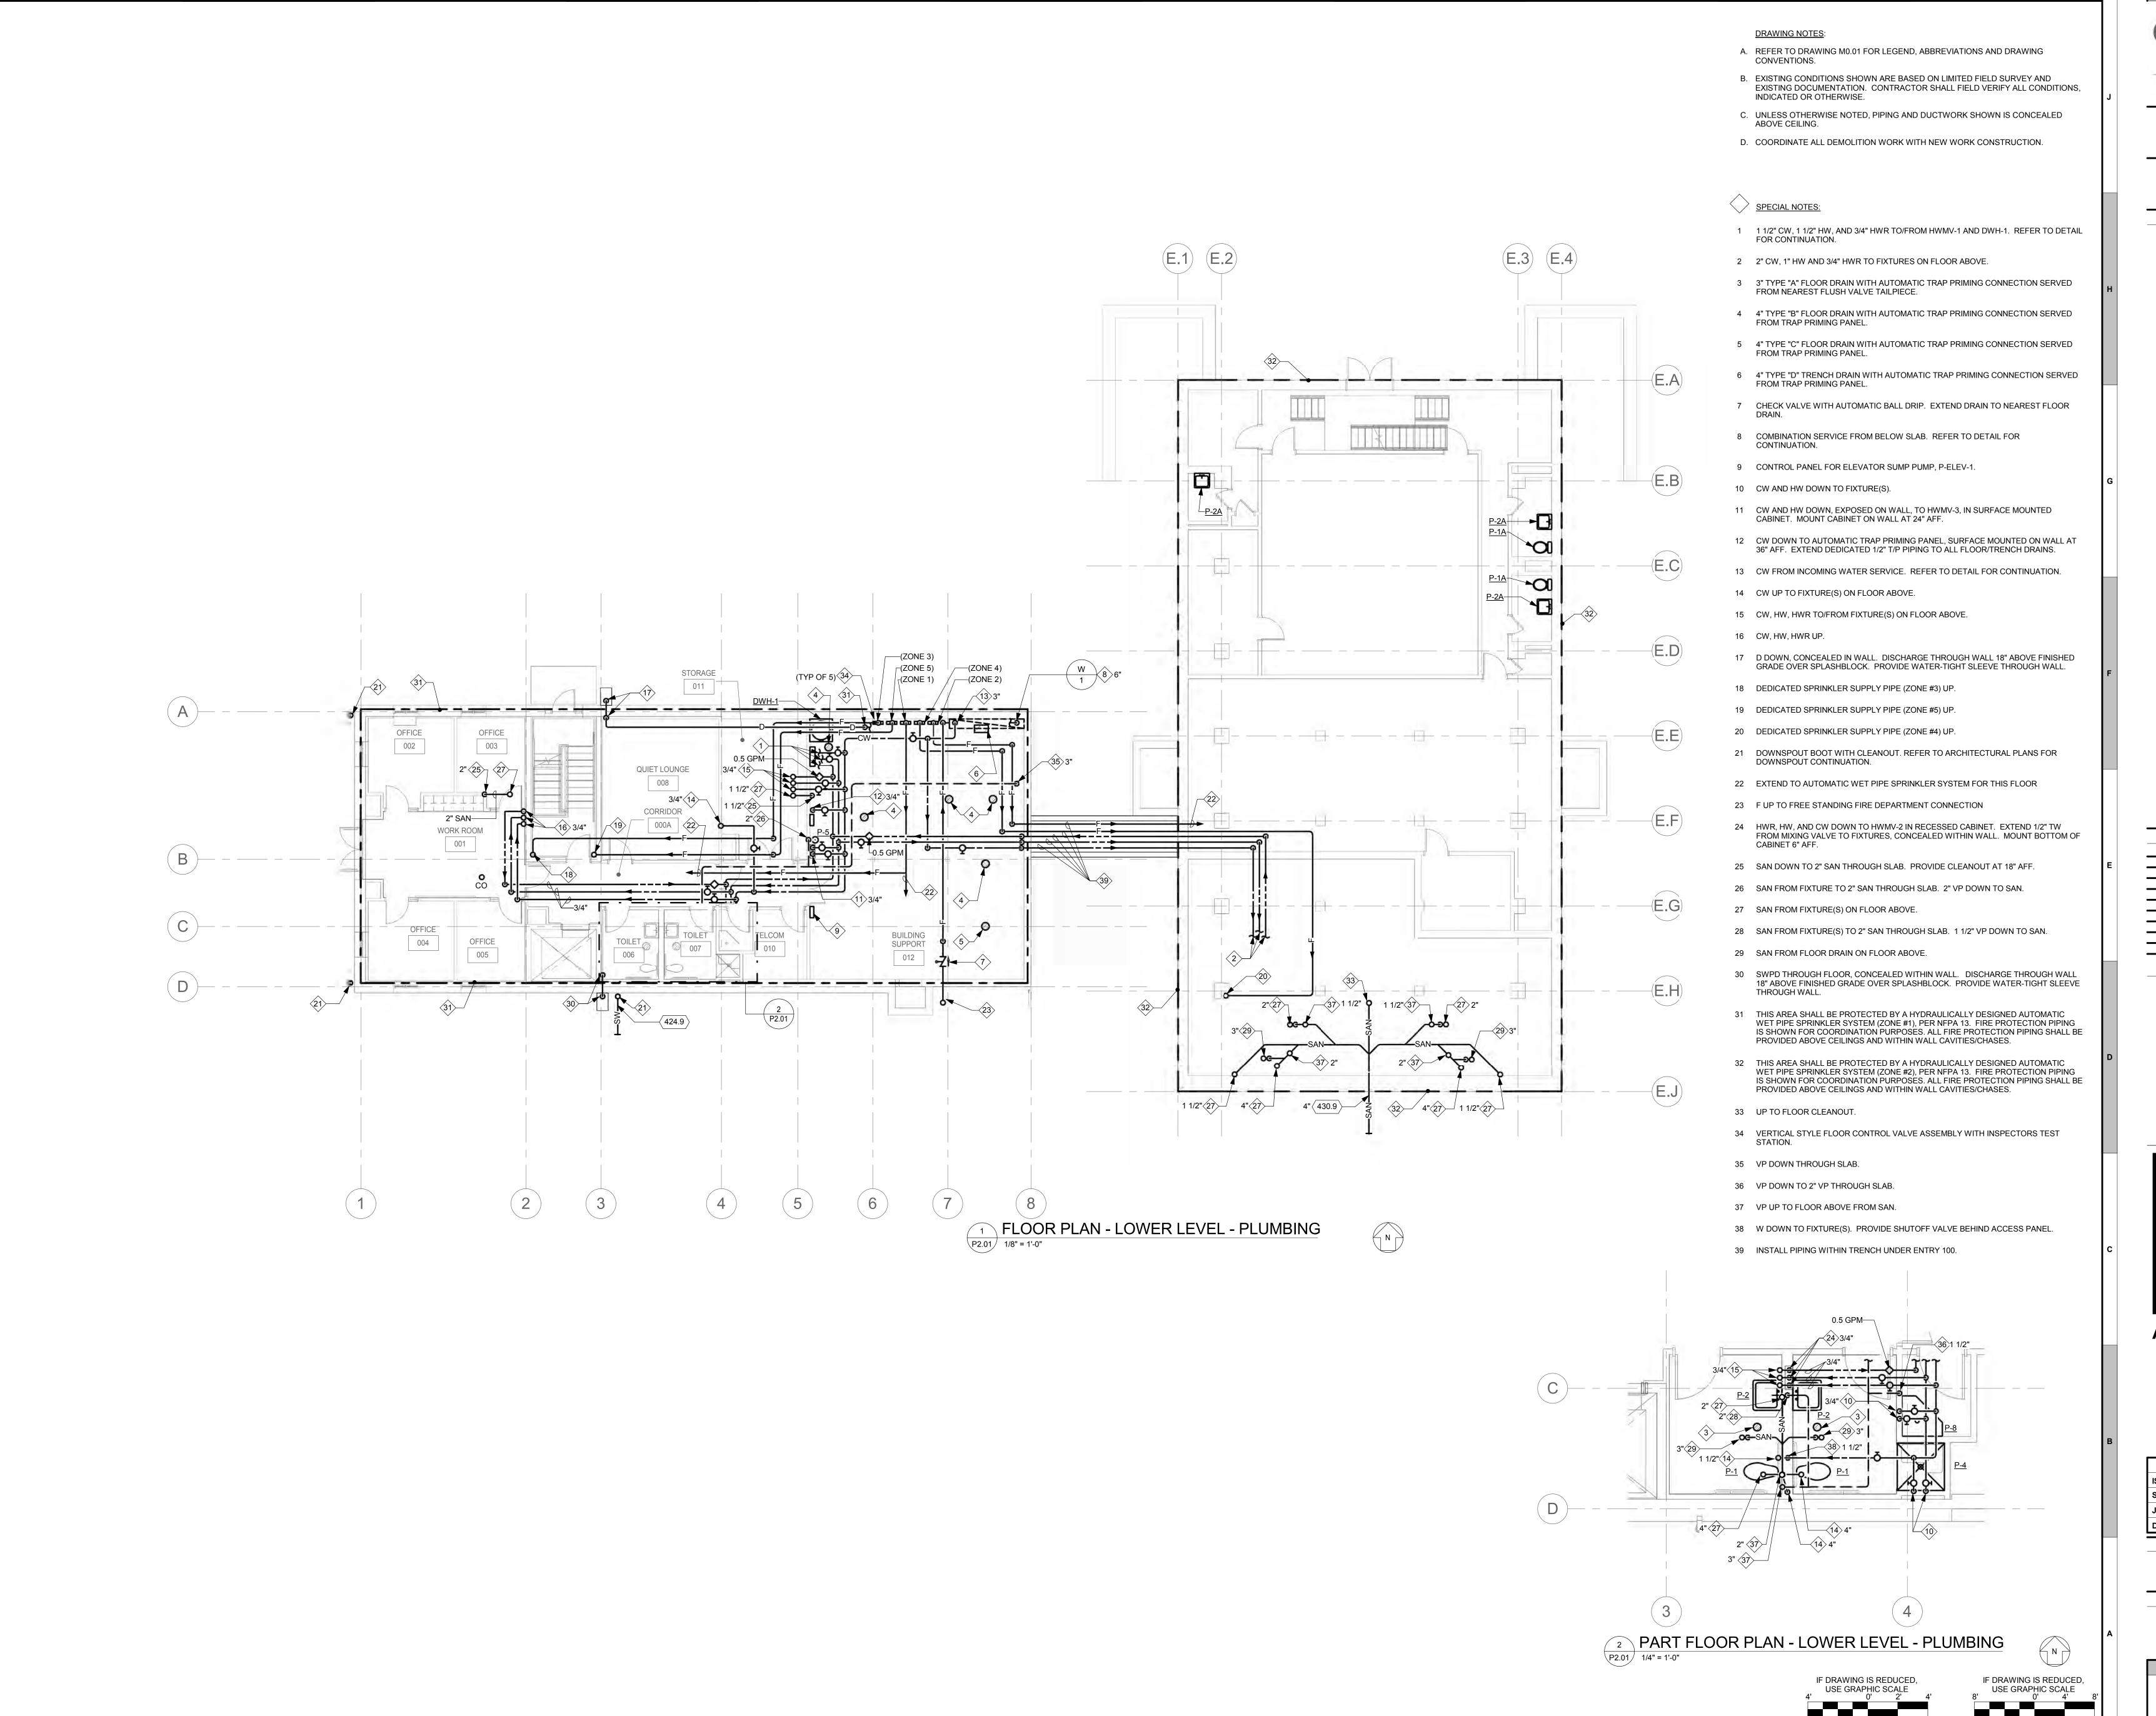

PROJECT INFORMATION

11

PROJECT TEAM

ARCHITECT AYERS SAINT GROSS 1040 HULL STREET, SUITE 100 BALTIMORE, MD 21230 410.347.8500

www.asg-architects.com M/E/P & FIRE PROTECTION ENGINEER MUELLER ASSOCIATES 1306 CONCOURSE DRIVE, SUITE 100 LINTHICUM, MD 21090

www.muellerassoc.com STRUCTURAL ENGINEER MORABITO CONSULTANTS 952 RIDGEBROOK ROAD, SUITE 1700

410.646.4500

SPARKS, MD 21152 410.467.2377 www.morabitoconsultants.com

CIVIL ENGINEER

300 EAST JOPPA ROAD, SUITE 200 BALTIMORE, MD 21286 410.512.4500

www.wbcm.com LANDSCAPE ARCHITECT AYERS SAINT GROSS

1040 HULL STREET, SUITE 100 BALTIMORE, MD 21230 410.347.8500 www.asg-architects.com

IT / AV / SECURITY

7257 PARKWAY DRIVE, SUITE 260 HANOVER, MD 21076 410.712.0390 www.spexsys.com

COMMISSIONING

901 DULANEY VALLEY ROAD, SUITE 301 TOWSON, MD 21204 410.494.1111 www.kibart.com

CODE CONSULTANT KOFFEL ASSOCIATES 8815 CENTRE PARK DRIVE, SUITE 200 COLUMBIA, MD 21045 410.750.2246

www.koffel.com

REVISIONS DESCRIPTION

KEY PLAN

INTERFAITH CENTER

AYERS

GROSS

ARCHITECTS + PLANNERS

NOT FOR CONSTRUCTION


ISSUE DATE: JOB NO.: DRAWN BY: PROJECT DESIGN PHASE

50% CONSTRUCTION DOCUMENTS

DRAWING NAME

FLOOR PLAN - LOWER LEVEL **PLUMBING** DRAWING NUMBER

P2.01

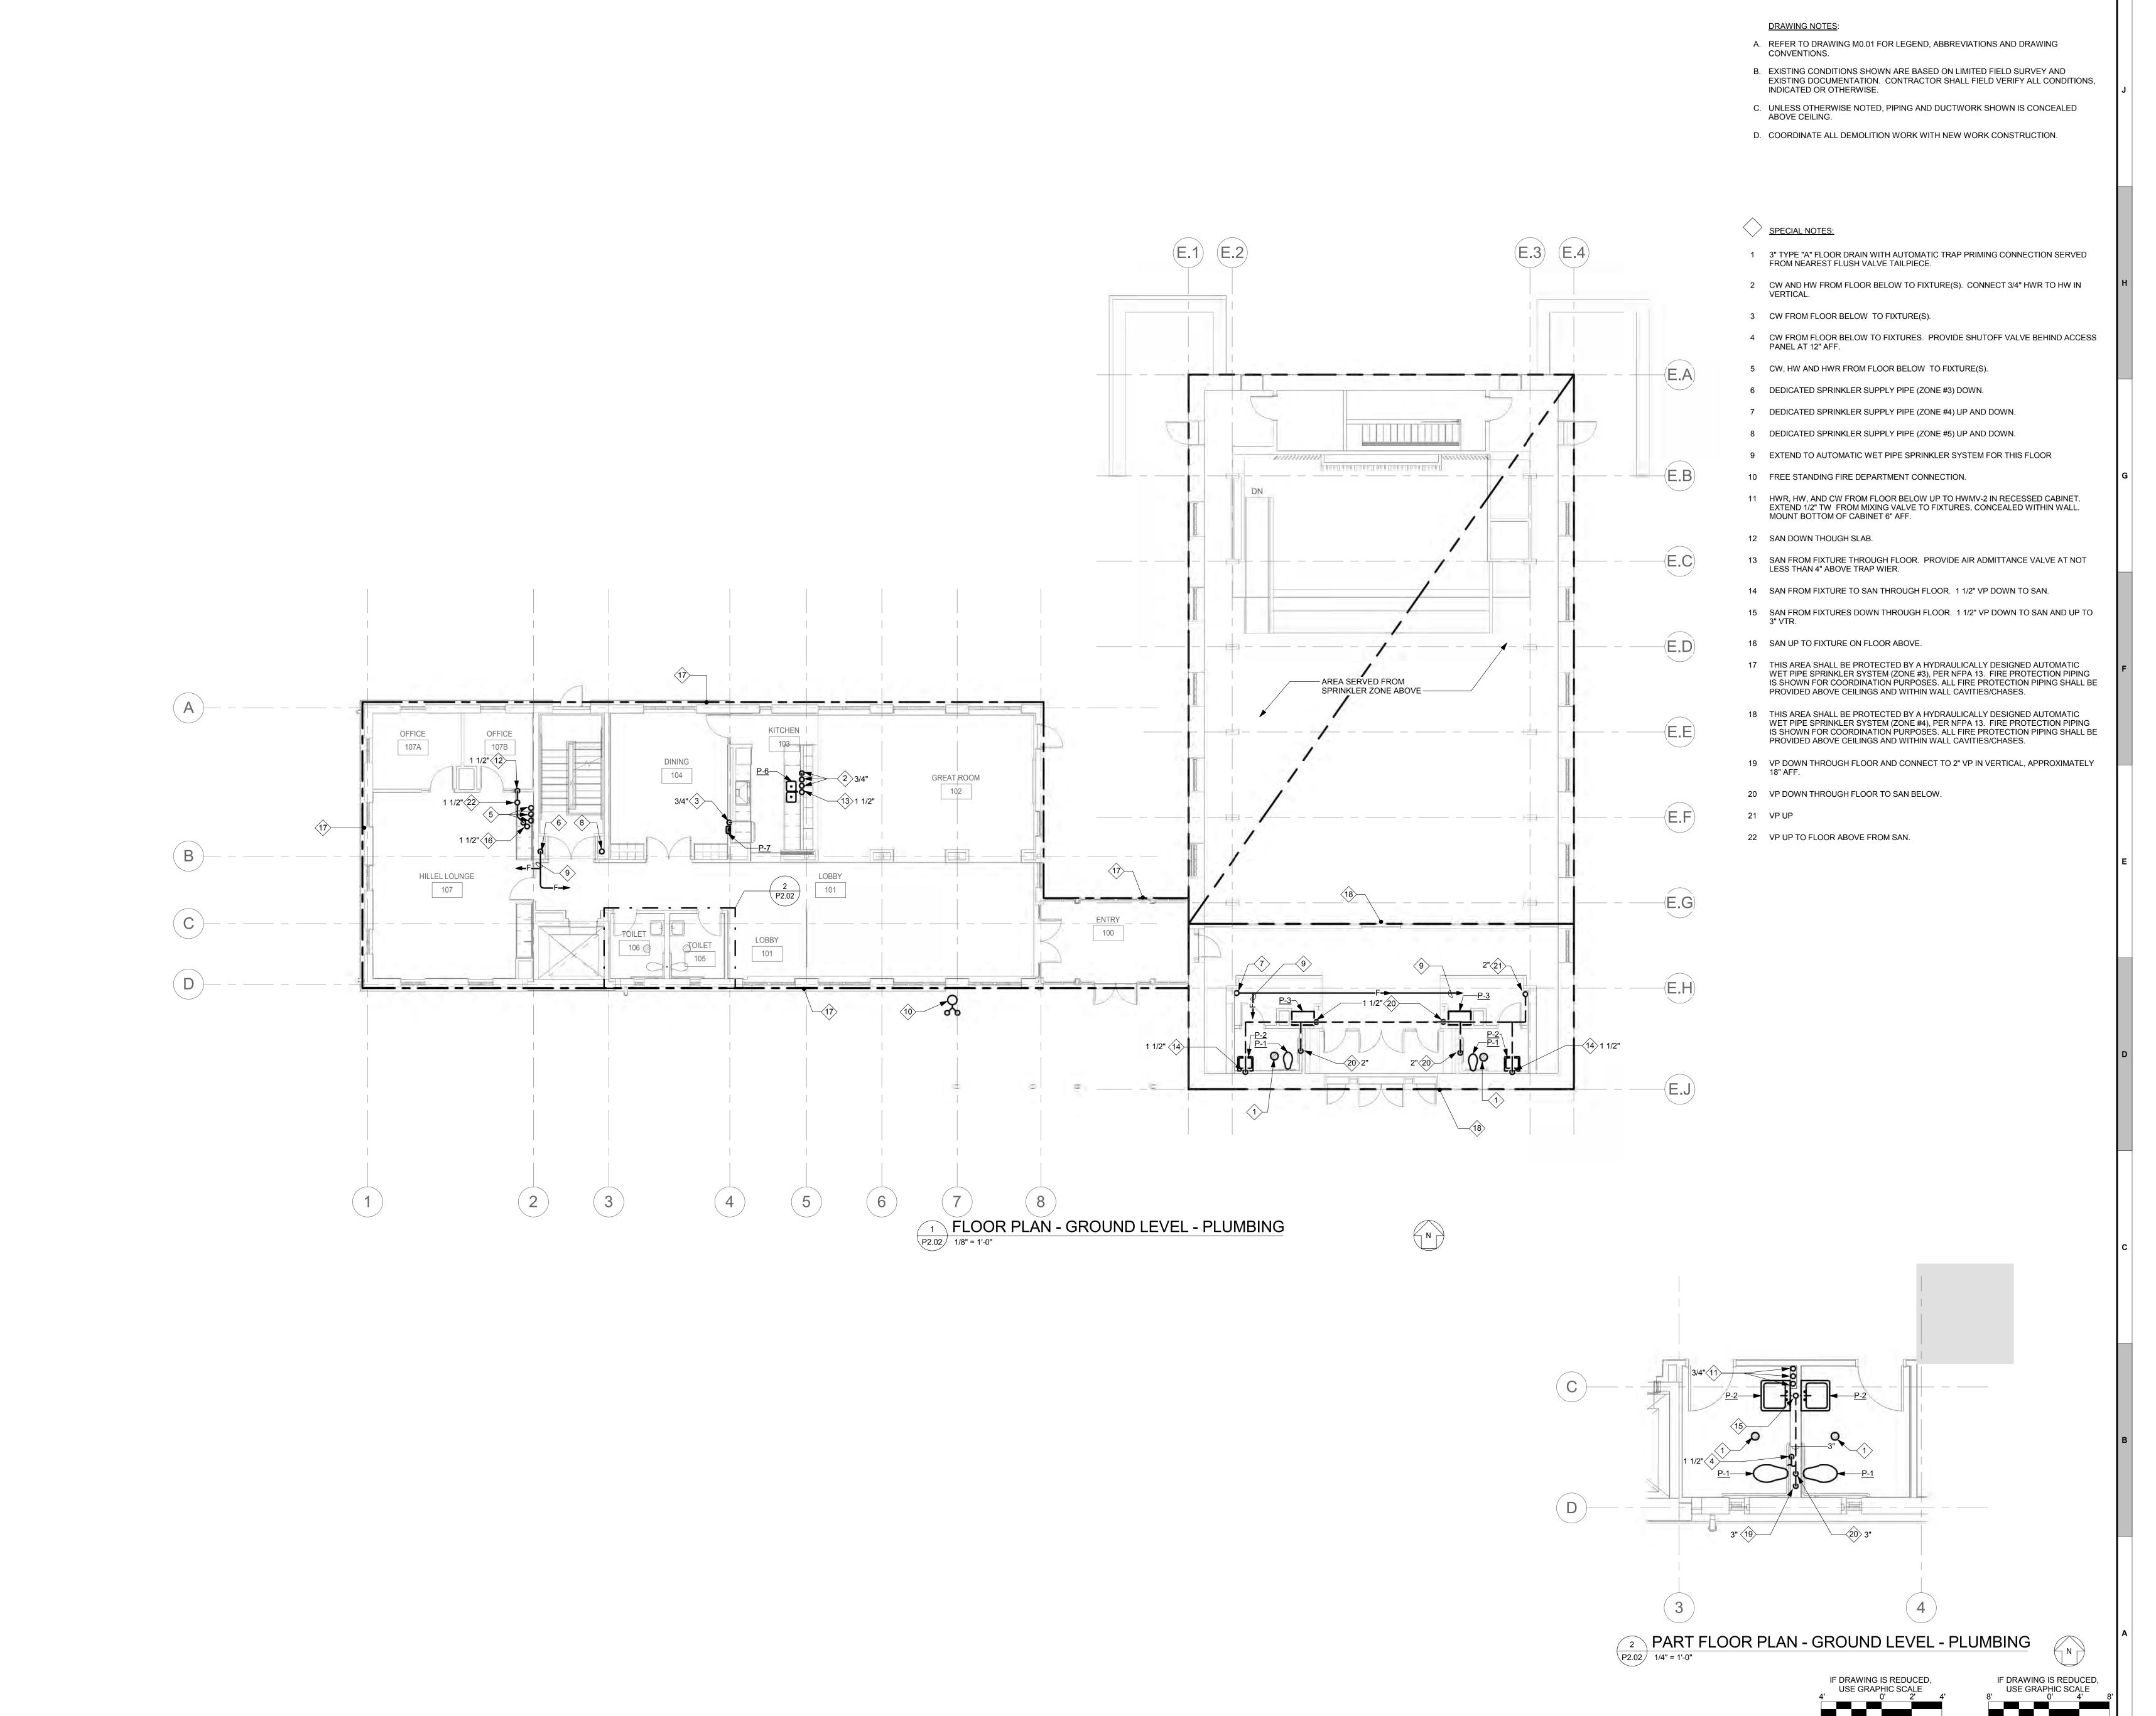

PROJECT INFORMATION

PROJECT TEAM

ARCHITECT AYERS SAINT GROSS 1040 HULL STREET, SUITE 100 BALTIMORE, MD 21230 410.347.8500

M/E/P & FIRE PROTECTION ENGINEER MUELLER ASSOCIATES 1306 CONCOURSE DRIVE, SUITE 100 LINTHICUM, MD 21090 410.646.4500 www.muellerassoc.com

www.asg-architects.com

STRUCTURAL ENGINEER MORABITO CONSULTANTS 952 RIDGEBROOK ROAD, SUITE 1700 SPARKS, MD 21152

410.467.2377 www.morabitoconsultants.com

CIVIL ENGINEER 300 EAST JOPPA ROAD, SUITE 200 BALTIMORE, MD 21286

www.wbcm.com LANDSCAPE ARCHITECT AYERS SAINT GROSS

410.512.4500

1040 HULL STREET, SUITE 100 BALTIMORE, MD 21230 410.347.8500 www.asg-architects.com

IT / AV / SECURITY SPEXSYS 7257 PARKWAY DRIVE, SUITE 260 HANOVER, MD 21076 410.712.0390

www.spexsys.com COMMISSIONING

KIBART 901 DULANEY VALLEY ROAD, SUITE 301 TOWSON, MD 21204 410.494.1111 www.kibart.com

CODE CONSULTANT KOFFEL ASSOCIATES 8815 CENTRE PARK DRIVE, SUITE 200 COLUMBIA, MD 21045 410.750.2246 www.koffel.com

REVISIONS

KEY PLAN

INTERFAITH CENTER

AYERS SAINT GROSS

ARCHITECTS + PLANNERS

NOT FOR CONSTRUCTION

ISSUE DATE: JOB NO.: DRAWN BY: PROJECT DESIGN PHASE

50% CONSTRUCTION DOCUMENTS

FLOOR PLANS - GROUND **LEVEL - PLUMBING**

DRAWING NAME

DRAWING NUMBER P2.02

DRAWING NOTES:

- A. REFER TO DRAWING M0.01 FOR LEGEND, ABBREVIATIONS AND DRAWING
- B. EXISTING CONDITIONS SHOWN ARE BASED ON LIMITED FIELD SURVEY AND EXISTING DOCUMENTATION. CONTRACTOR SHALL FIELD VERIFY ALL CONDITIONS, INDICATED OR OTHERWISE.

11

- UNLESS OTHERWISE NOTED, PIPING AND DUCTWORK SHOWN IS CONCEALED ABOVE CEILING.
- D. COORDINATE ALL DEMOLITION WORK WITH NEW WORK CONSTRUCTION.

SPECIAL NOTES:

- 2 CW, HW AND HWR FROM FLOOR BELOW TO FIXTURE(S).
- 3 DEDICATED SPRINKLER SUPPLY PIPE (ZONE #4) DOWN.
- 4 DEDICATED SPRINKLER SUPPLY PIPE (ZONE #5) DOWN.
- 5 EXTEND TO AUTOMATIC WET PIPE SPRINKLER SYSTEM FOR THIS FLOOR
- 6 THIS AREA SHALL BE PROTECTED BY A HYDRAULICALLY DESIGNED AUTOMATIC WET PIPE SPRINKLER SYSTEM (ZONE #5), PER NFPA 13. FIRE PROTECTION PIPING IS SHOWN FOR COORDINATION PURPOSES. ALL FIRE PROTECTION PIPING SHALL BE PROVIDED ABOVE CEILINGS AND WITHIN WALL CAVITIES/CHASES.
- 7 THIS AREA SHALL BE PROTECTED BY A HYDRAULICALLY DESIGNED AUTOMATIC WET PIPE SPRINKLER SYSTEM (ZONE #3), PER NFPA 13. FIRE PROTECTION PIPING IS SHOWN FOR COORDINATION PURPOSES. ALL FIRE PROTECTION PIPING SHALL BE PROVIDED ABOVE CEILINGS AND WITHIN WALL CAVITIES/CHASES.
- 8 THIS AREA SHALL BE PROTECTED BY A HYDRAULICALLY DESIGNED AUTOMATIC WET PIPE SPRINKLER SYSTEM (ZONE #4), PER NFPA 13. FIRE PROTECTION PIPING IS SHOWN FOR COORDINATION PURPOSES. ALL FIRE PROTECTION PIPING SHALL BE PROVIDED ABOVE CEILINGS AND WITHIN WALL CAVITIES/CHASES.
- 9 VP DOWN THROUGH FLOOR AND UP TO 3" VTR.

PROJECT INFORMATION

PROJECT TEAM

ARCHITECT AYERS SAINT GROSS 1040 HULL STREET, SUITE 100 BALTIMORE, MD 21230 410.347.8500

M/E/P & FIRE PROTECTION ENGINEER MUELLER ASSOCIATES 1306 CONCOURSE DRIVE, SUITE 100 LINTHICUM, MD 21090 410.646.4500

www.asg-architects.com

www.muellerassoc.com STRUCTURAL ENGINEER MORABITO CONSULTANTS 952 RIDGEBROOK ROAD, SUITE 1700

SPARKS, MD 21152 410.467.2377 www.morabitoconsultants.com

CIVIL ENGINEER 300 EAST JOPPA ROAD, SUITE 200

www.wbcm.com LANDSCAPE ARCHITECT AYERS SAINT GROSS 1040 HULL STREET, SUITE 100

BALTIMORE, MD 21286

410.512.4500

BALTIMORE, MD 21230 410.347.8500 www.asg-architects.com


IT / AV / SECURITY SPEXSYS 7257 PARKWAY DRIVE, SUITE 260 HANOVER, MD 21076 410.712.0390 www.spexsys.com


> COMMISSIONING KIBART

901 DULANEY VALLEY ROAD, SUITE 301 TOWSON, MD 21204 410.494.1111 www.kibart.com

CODE CONSULTANT KOFFEL ASSOCIATES 8815 CENTRE PARK DRIVE, SUITE 200 COLUMBIA, MD 21045 410.750.2246 www.koffel.com

REVISIONS **KEY PLAN**

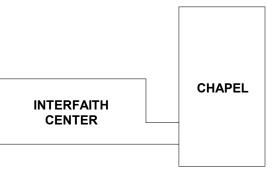

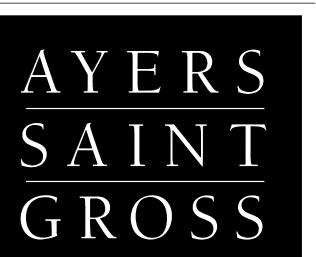

ARCHITECTS + PLANNERS

NOT FOR CONSTRUCTION

	DRAWING INFORMATION	
ISSUE DATE:		04/28/17
SCALE:		1/8" = 1'-0"
JOB NO.:		21641.00
DRAWN BY:		Author
	PROJECT DESIGN PHASE	

50% CONSTRUCTION

DOCUMENTS DRAWING NAME

IF DRAWING IS REDUCED,
USE GRAPHIC SCALE
8' 0' 4'

1/8" = 1'-0"

FLOOR PLANS - LEVEL 2 -**PLUMBING**

> DRAWING NUMBER P2.03


——— CONTROL AND ANNUNCIATOR PANEL WITH REMOTE ALARM CONTACT (NOTE 1) (NON-GFI) CORD AND PLUG MULTI-PIN CONNECTOR AND AND CORD IN MINIMUM 2 1/2" DIAMETER NOTE 3 — EMT CONDUIT. (NOTE 2) SLEEVE AND SEAL (TYPICAL) FINISH GRADE FINISH FLOOR — <u>ELEVATOR PIT</u> —— NEMA 4X JUNCTION BOX (POINT OF DISCONNECT) — CONTROL WIRING SHUT-OFF VALVE — /— 1/2" OPEN GRATE CHECK VALVE -RUBBER GROMMET (TYPICAL) ANGLE IRON SUPPORT -HIGH LIQUID ALARM CONCRETE BASIN (2'x2'x2'). PUMP ON COORDINATE WITH STRUCTURAL DRAWINGS. -STAINLESS STEEL PUMP OFF OIL SENSING PROBE -FLOAT SWITCH (TYP) -

NOTES

OIL-MINDER SUMP PUMP -

- 1. LOCATION OF THE CONTROL PANEL, CORD AND OUTLET SHALL BE AS ACCEPTABLE BY THE ELEVATOR INSPECTOR.
- 2. CONTRACTOR SHALL COORDINATE REQUIRED LENGTH OF CORD, WIRING, CONDUIT, ETC. FOR PROJECT CONDITIONS.
- 3. FOR EXACT ROUTING OF SWPD PUMPED DISCHARGE PIPING REFER TO FLOOR PLANS.


1 ELEVATOR PIT "OIL MINDER" SUMP PUMP P5.01 NOT TO SCALE

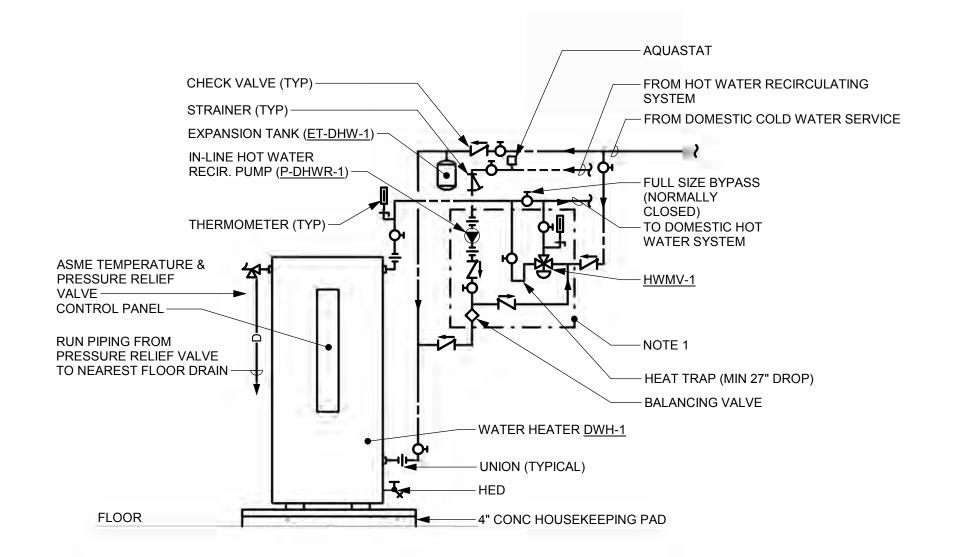

NOTES:

- 1. MIXING VALVE AND RECIRCULATING PUMP SHALL BE MOUNTED ON SAME FACTORY ASSEMBLED/PROVIDED MOUNTING SUPPORT STRUT AS PROVIDED BY MIXING VALVE MANUFACTURER.
- 2. HOT WATER TEMPERATURES SHALL BE NOT LESS THAN 140° F FOR STORAGE, 130° F FOR DISTRIBUTION TEMPERATURE, AND 125° FOR RECIRCLUATION RETURN.

2 ELECTRIC STORAGE WATER HEATER
P5.01 NOT TO SCALE

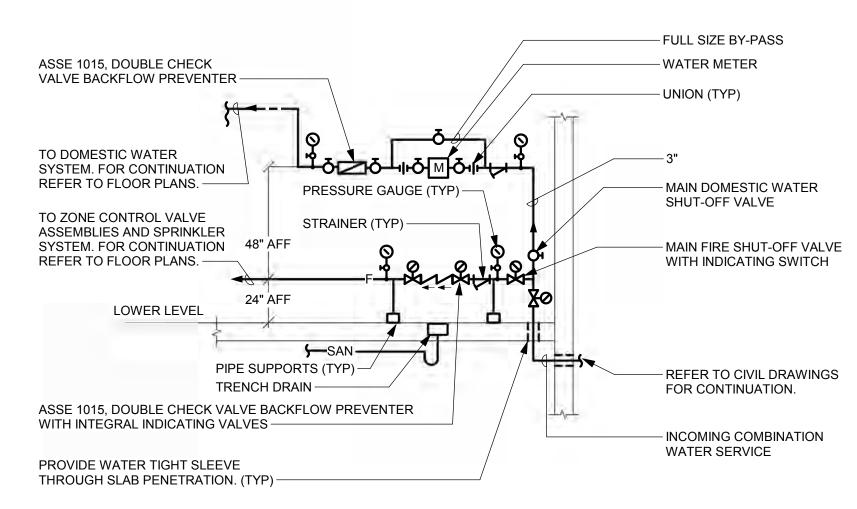

3 INCOMING DOMESTIC WATER SCHEMATIC
P5.01 NOT TO SCALE

GOUCHER

PROJECT INFORMATION

11

PROJECT TEAM

ARCHITECT
AYERS SAINT GROSS
1040 HULL STREET, SUITE 100
BALTIMORE, MD 21230
410.347.8500
www.asg-architects.com

M/E/P & FIRE PROTECTION ENGINEER

MUELLER ASSOCIATES

1306 CONCOURSE DRIVE, SUITE 100

LINTHICUM, MD 21090

410.646.4500

www.muellerassoc.com

STRUCTURAL ENGINEER

MORABITO CONSULTANTS

952 RIDGEBROOK ROAD, SUITE 1700

SPARKS, MD 21152

410.467.2377

www.morabitoconsultants.com

CIVIL ENGINEER

WRCM

300 EAST JOPPA ROAD, SUITE 200 BALTIMORE, MD 21286

410.512.4500

www.wbcm.com

LANDSCAPE ARCHITECT

AYERS SAINT GROSS

1040 HULL STREET, SUITE 100 BALTIMORE, MD 21230 410.347.8500 www.asg-architects.com

IT / AV / SECURITY

SPEXSYS
7257 PARKWAY DRIVE, SUITE 260

HANOVER, MD 21076 410.712.0390

901 DULANEY VALLEY ROAD, SUITE 301 TOWSON, MD 21204

www.spexsys.com

COMMISSIONING


KIBART

410.494.1111
www.kibart.com

CODE CONSULTANT
KOEEEL ASSOCIATES

KOFFEL ASSOCIATES 8815 CENTRE PARK DRIVE, SUITE 200 COLUMBIA, MD 21045 410.750.2246 www.koffel.com

REV. # DESCRIPTION DATE

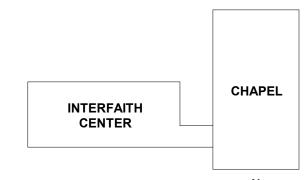



ARCHITECTS + PLANNERS

NOT FOR CONSTRUCTION

DRAWING INFORMA	ATION
ISSUE DATE:	04/28/17
SCALE:	1/8" = 1'-0"
JOB NO.:	21641.00
DRAWN BY:	Author
PROJECT DESIGN P	PHASE

50% CONSTRUCTION DOCUMENTS

DETAILS

DRAWING NAME

DRAWING NUMBER

© COPYRIGHT AYERS SAINT GROSS, 2017

P5.01

					PL	JMPS	- Pl	_UM	IBING
DESIG	LOCATION	SERVICE	WATER FLOWRATE (GPM)	HEAD (FT HD)	MOTOR HP	VOLTS	ECTRIC PH	AL	NOTES
P-DWHR-1	012 BUILDING SUPPORT	DOMESTIC HOT WATER	· , ,	15.0	0.5	120	1	60	
P-ELEV-1	ELEVATOR	ELEVATOR SUMP	50.0	25.0	0.5	120	1	60	PUMP CONTROLLER LOCATED IN 012 BUILDING SUPPORT.

				FLOOR DRAINS
		CONNE	CTION	
DESIG	DESCRIPTION	SYSTEM	SIZE (IN)	REMARKS
FD-A	TOILET ROOM FLOOR DRAIN	SAN	3"	
FD-B	MECHANICAL ROOM FLOOR DRAIN	SAN	4"	
FD-C	CONDENSATE FLOOR DRAIN	SW	4"	PROVIDE WITH RAISED COLLAR AND FUNNEL
FD-D	TRENCH DRAIN	SAN	4"	

		DC	MES	TIC HOT	WATER	MIXIN	NG VALVES
DESIG	LOCATION	SERVICE	GPM	HOT WATER TEMP. (°F)	MAX. PRESSURE DROP (PSI)	HEAT TRAP	REMARKS
HWMV-1	BUILDING SUPPORT 012	DOMESTIC HOT WATER DWH-1	20	130	10	27"	ASSE 1017.
HWMV-2	TOILET	LAVATORIES	0.5	110	10		ASSE 1070.
HWMV-3	BUILDING SUPPORT 012	P-5 EMERGENCY FIXTURES	5	85	10		ASSE 1071.

1		T							
DESIG	LOCATION	SERVICE	TANK VOLUME (GALLONS)	ACCEPTANCE VOLUME (GALLONS)	FILL PRESSURE (PSIG)	RELIEF VALVE SETTING (PSIG)	EQUALIZER PIPE SIZE (IN)	NOTES	
T-DHW-1	MER	DOMESTIC HOT WATER	16	8	80	125	3/4	B.O.D. AMTROL SERIES ST	

				E	ELECTRIC STORAGE WATER HEATER
DESIG	STORAGE (GAL.)	RECOVERY @ 100°F RISE (GPH)	KW TOTAL (MAX)	VOLTS/PHASE/HZ	NOTES
DWH-1	65	37	9	208/3/60	

11

PROJECT TEAM

ARCHITECT
AYERS SAINT GROSS
1040 HULL STREET, SUITE 100
BALTIMORE, MD 21230
410.347.8500
www.asg-architects.com

M/E/P & FIRE PROTECTION ENGINEER

MUELLER ASSOCIATES

1306 CONCOURSE DRIVE, SUITE 100

LINTHICUM, MD 21090

410.646.4500

STRUCTURAL ENGINEER

MORABITO CONSULTANTS

952 RIDGEBROOK ROAD, SUITE 1700

SPARKS, MD 21152

410.467.2377

www.morabitoconsultants.com

CIVIL ENGINEER

www.muellerassoc.com

WBCM 300 EAST JOPPA ROAD, SUITE 200 BALTIMORE, MD 21286 410.512.4500

www.wbcm.com

LANDSCAPE ARCHITECT
AYERS SAINT GROSS
1040 HULL STREET, SUITE 100
BALTIMORE, MD 21230

BALTIMORE, MD 21230 410.347.8500 www.asg-architects.com

SPEXSYS
7257 PARKWAY DRIVE, SUITE 260
HANOVER, MD 21076
410.712.0390
www.spexsys.com

COMMISSIONING

KIBART

ANEY VALLEY ROAD, SUITI

901 DULANEY VALLEY ROAD, SUITE 301 TOWSON, MD 21204 410.494.1111 www.kibart.com


CODE CONSULTANT

KOFFEL ASSOCIATES
8815 CENTRE PARK DRIVE, SUITE 200
COLUMBIA, MD 21045
410.750.2246
www.koffel.com

	REVISIONS	
REV.#	DESCRIPTION	DATE

KEY PLAN

INTERFAITH CENTER

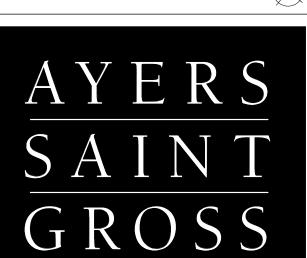

ARCHITECTS + PLANNERS

NOT FOR CONSTRUCTION

DRAWING INF	FORMATION
ISSUE DATE:	04/28/17
SCALE:	As indicated
JOB NO.:	21641.00
DRAWN BY:	Author

PROJECT DESIGN PHASE
50% CONSTRUCTION

DOCUMENTS

DRAWING NAME

SCHEDULES

P6.01

PROJECT INFORMATION

11

PROJECT TEAM

ARCHITECT **AYERS SAINT GROSS** 1040 HULL STREET, SUITE 100 BALTIMORE, MD 21230 410.347.8500 www.asg-architects.com

M/E/P & FIRE PROTECTION ENGINEER

MUELLER ASSOCIATES 1306 CONCOURSE DRIVE, SUITE 100 LINTHICUM, MD 21090 410.646.4500 www.muellerassoc.com

STRUCTURAL ENGINEER MORABITO CONSULTANTS 952 RIDGEBROOK ROAD, SUITE 1700 SPARKS, MD 21152 410.467.2377 www.morabitoconsultants.com

CIVIL ENGINEER

300 EAST JOPPA ROAD, SUITE 200 BALTIMORE, MD 21286 410.512.4500 www.wbcm.com

LANDSCAPE ARCHITECT AYERS SAINT GROSS 1040 HULL STREET, SUITE 100 BALTIMORE, MD 21230 410.347.8500

www.asg-architects.com IT / AV / SECURITY

SPEXSYS

7257 PARKWAY DRIVE, SUITE 260

HANOVER, MD 21076 410.712.0390 www.spexsys.com COMMISSIONING KIBART

901 DULANEY VALLEY ROAD, SUITE 301


TOWSON, MD 21204


410.494.1111 www.kibart.com CODE CONSULTANT KOFFEL ASSOCIATES

8815 CENTRE PARK DRIVE, SUITE 200

COLUMBIA, MD 21045 410.750.2246 www.koffel.com

REVISIONS DESCRIPTION **KEY PLAN**

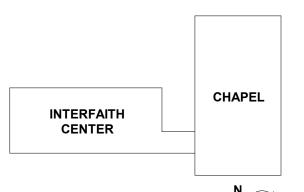

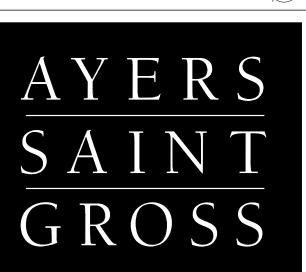

ARCHITECTS + PLANNERS

NOT FOR CONSTRUCTION


ISSUE DATE: DRAWN BY: **PROJECT DESIGN PHASE**

> **50% CONSTRUCTION DOCUMENTS**

DRAWING NAME

ELECTRICAL LEGEND

DRAWING NUMBER

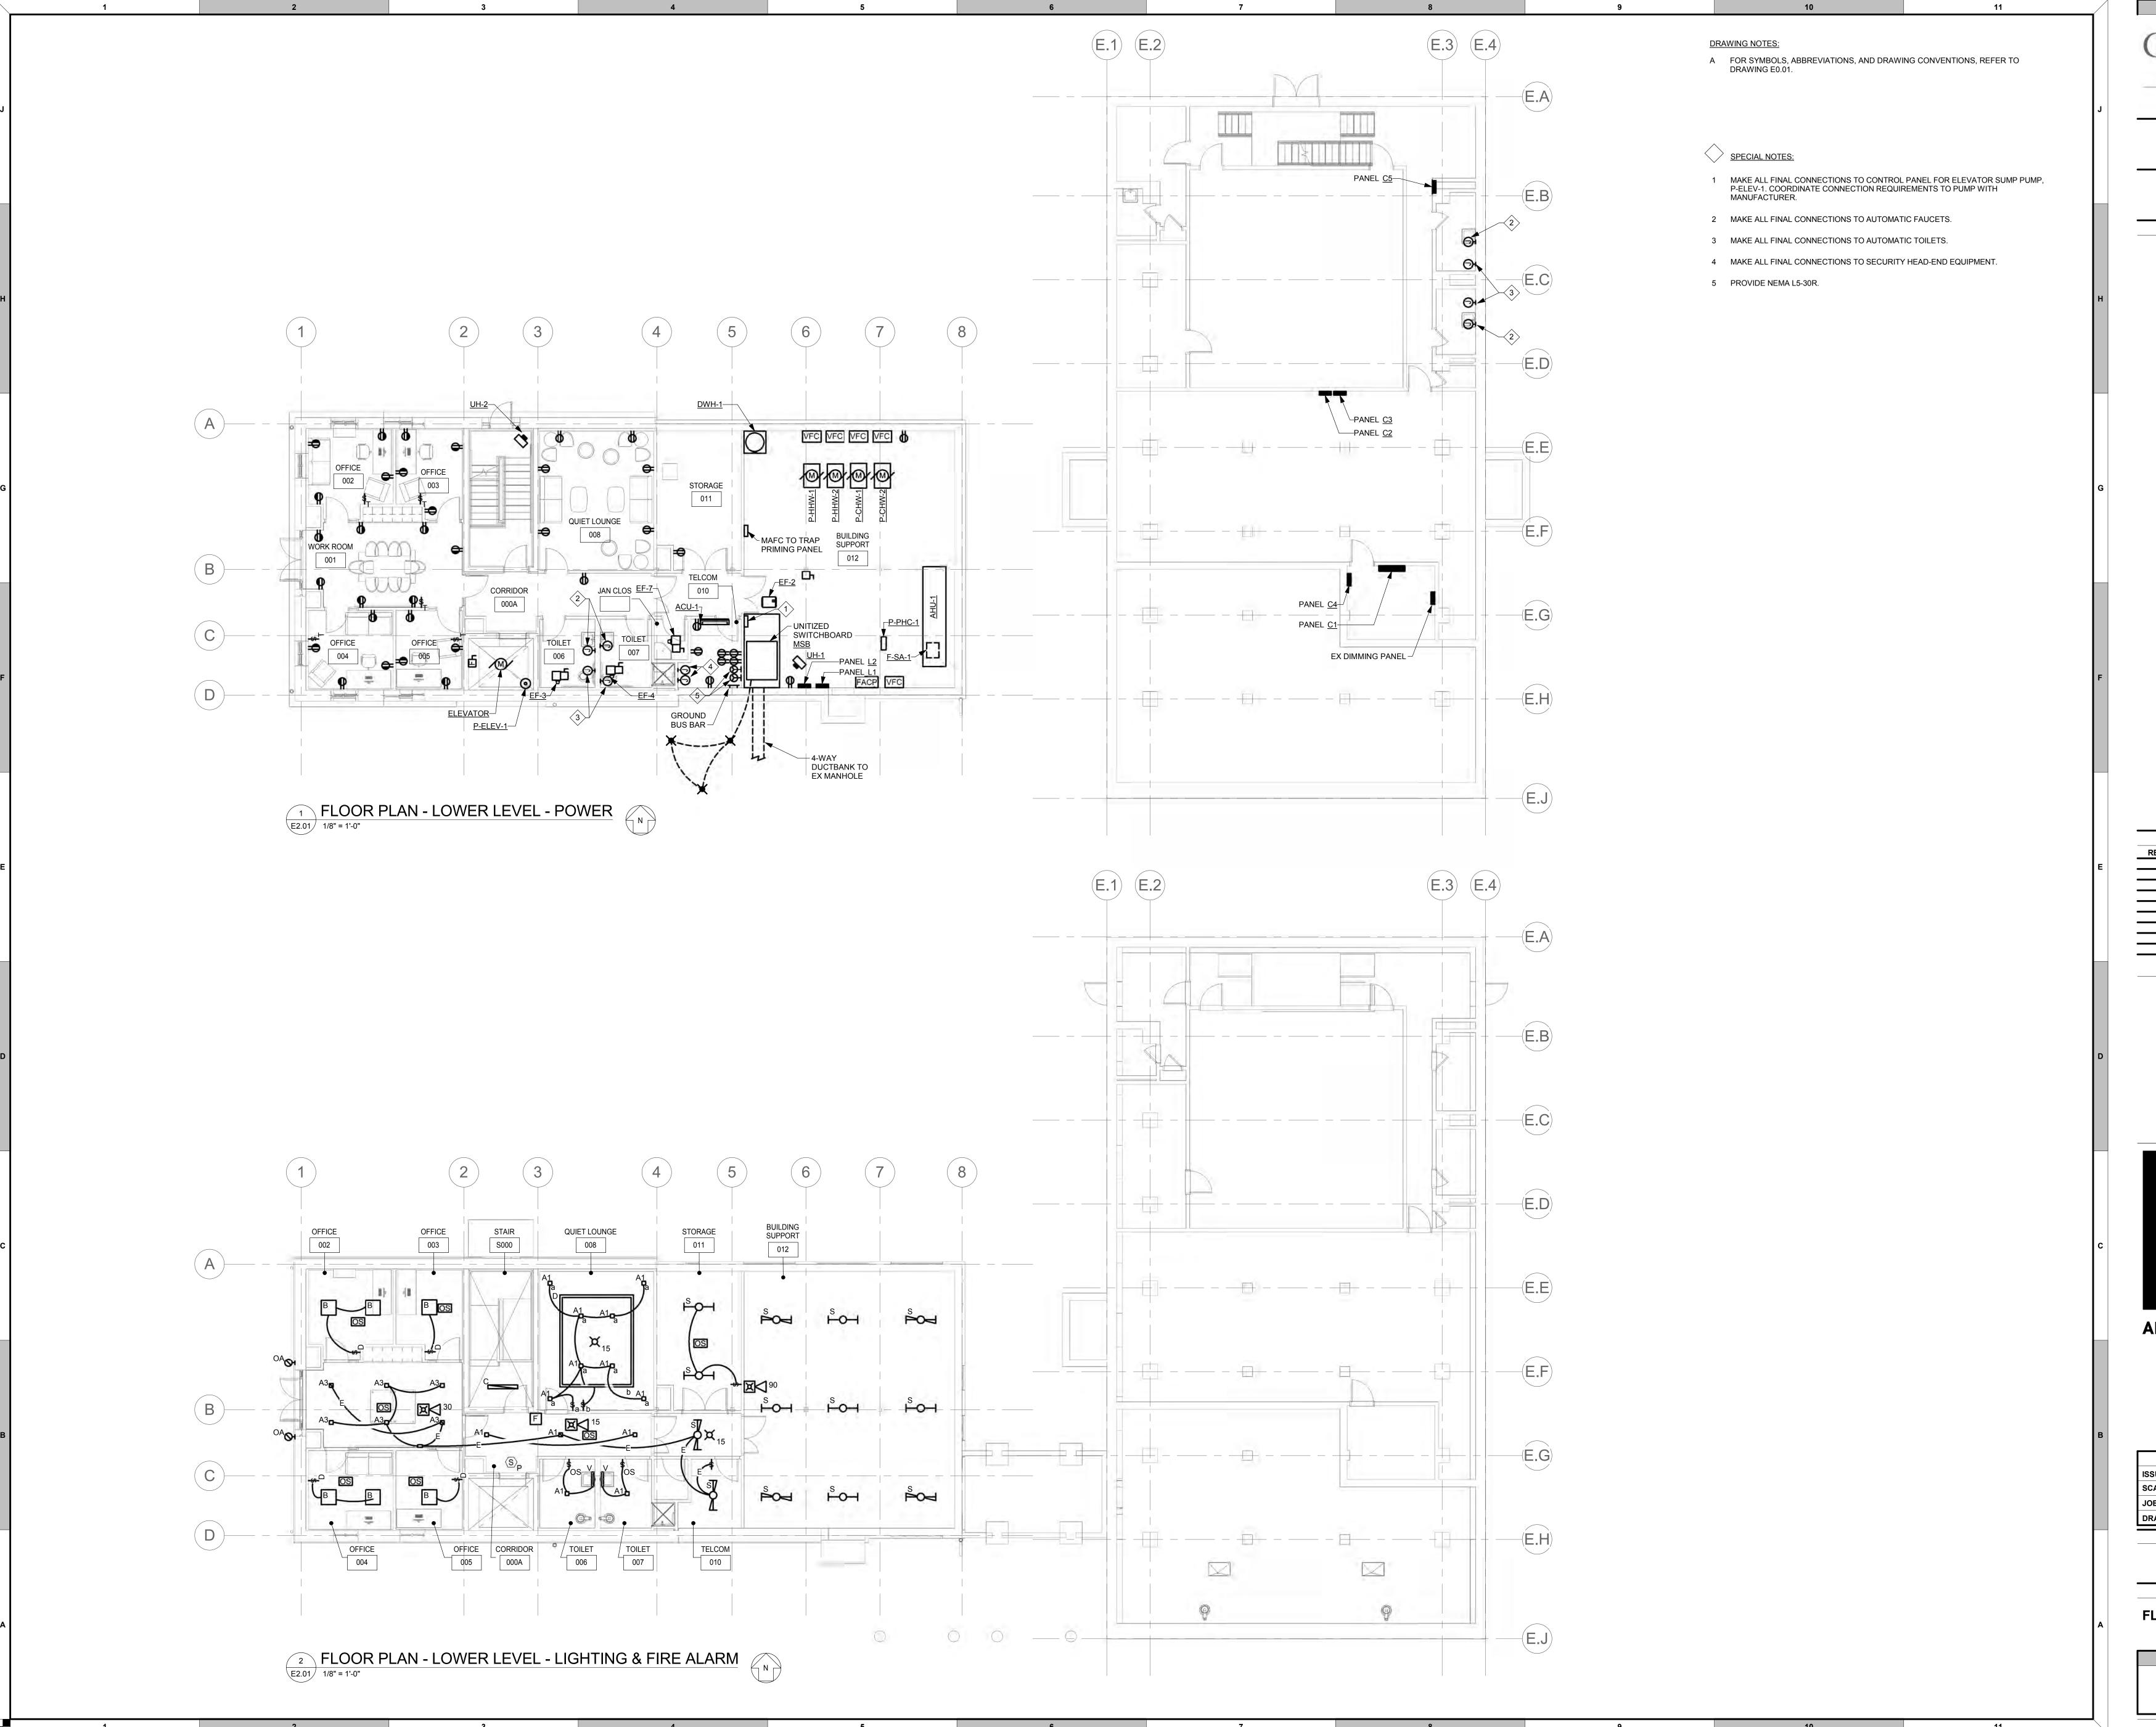

GOUCHER

--college-

PROJECT TEAM

ARCHITECT
AYERS SAINT GROSS
1040 HULL STREET, SUITE 100
BALTIMORE, MD 21230
410.347.8500
www.asg-architects.com

M/E/P & FIRE PROTECTION ENGINEER

MUELLER ASSOCIATES

1306 CONCOURSE DRIVE, SUITE 100

LINTHICUM, MD 21090

410.646.4500

www.muellerassoc.com

STRUCTURAL ENGINEER

MORABITO CONSULTANTS

952 RIDGEBROOK ROAD, SUITE 1700

SPARKS, MD 21152

410.467.2377

www.morabitoconsultants.com

CIVIL ENGINEER

WBCM

FAST JOPPA ROAD, SUITE

300 EAST JOPPA ROAD, SUITE 200 BALTIMORE, MD 21286 410.512.4500 www.wbcm.com

AYERS SAINT GROSS 1040 HULL STREET, SUITE 100 BALTIMORE, MD 21230 410.347.8500

www.asg-architects.com

IT / AV / SECURITY

SPEXSYS

7257 PARKWAY DRIVE, SUITE 260 HANOVER, MD 21076 410.712.0390 www.spexsys.com

COMMISSIONING

KIBART

NEV VALLEY BOAD, SUI


901 DULANEY VALLEY ROAD, SUITE 301 TOWSON, MD 21204 410.494.1111 www.kibart.com


CODE CONSULTANT

KOFFEL ASSOCIATES
8815 CENTRE PARK DRIVE, SUITE 200
COLUMBIA, MD 21045
410.750.2246
www.koffel.com

REVISIONS

REV. # DESCRIPTION DATE

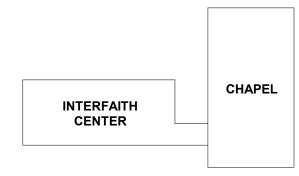

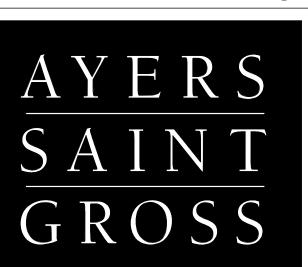

ARCHITECTS + PLANNERS

NOT FOR CONSTRUCTION

DRAWING INFO	RMATION
ISSUE DATE:	04/26/17
SCALE:	1/8" = 1'-0"
JOB NO.:	21641.00
DRAWN BY:	Author
PROJECT DESI	GN PHASE


50% CONSTRUCTION DOCUMENTS

DRAWING NAME

FLOOR PLANS - LOWER LEVEL - ELECTRICAL

E2.01

DRAWING NUMBER

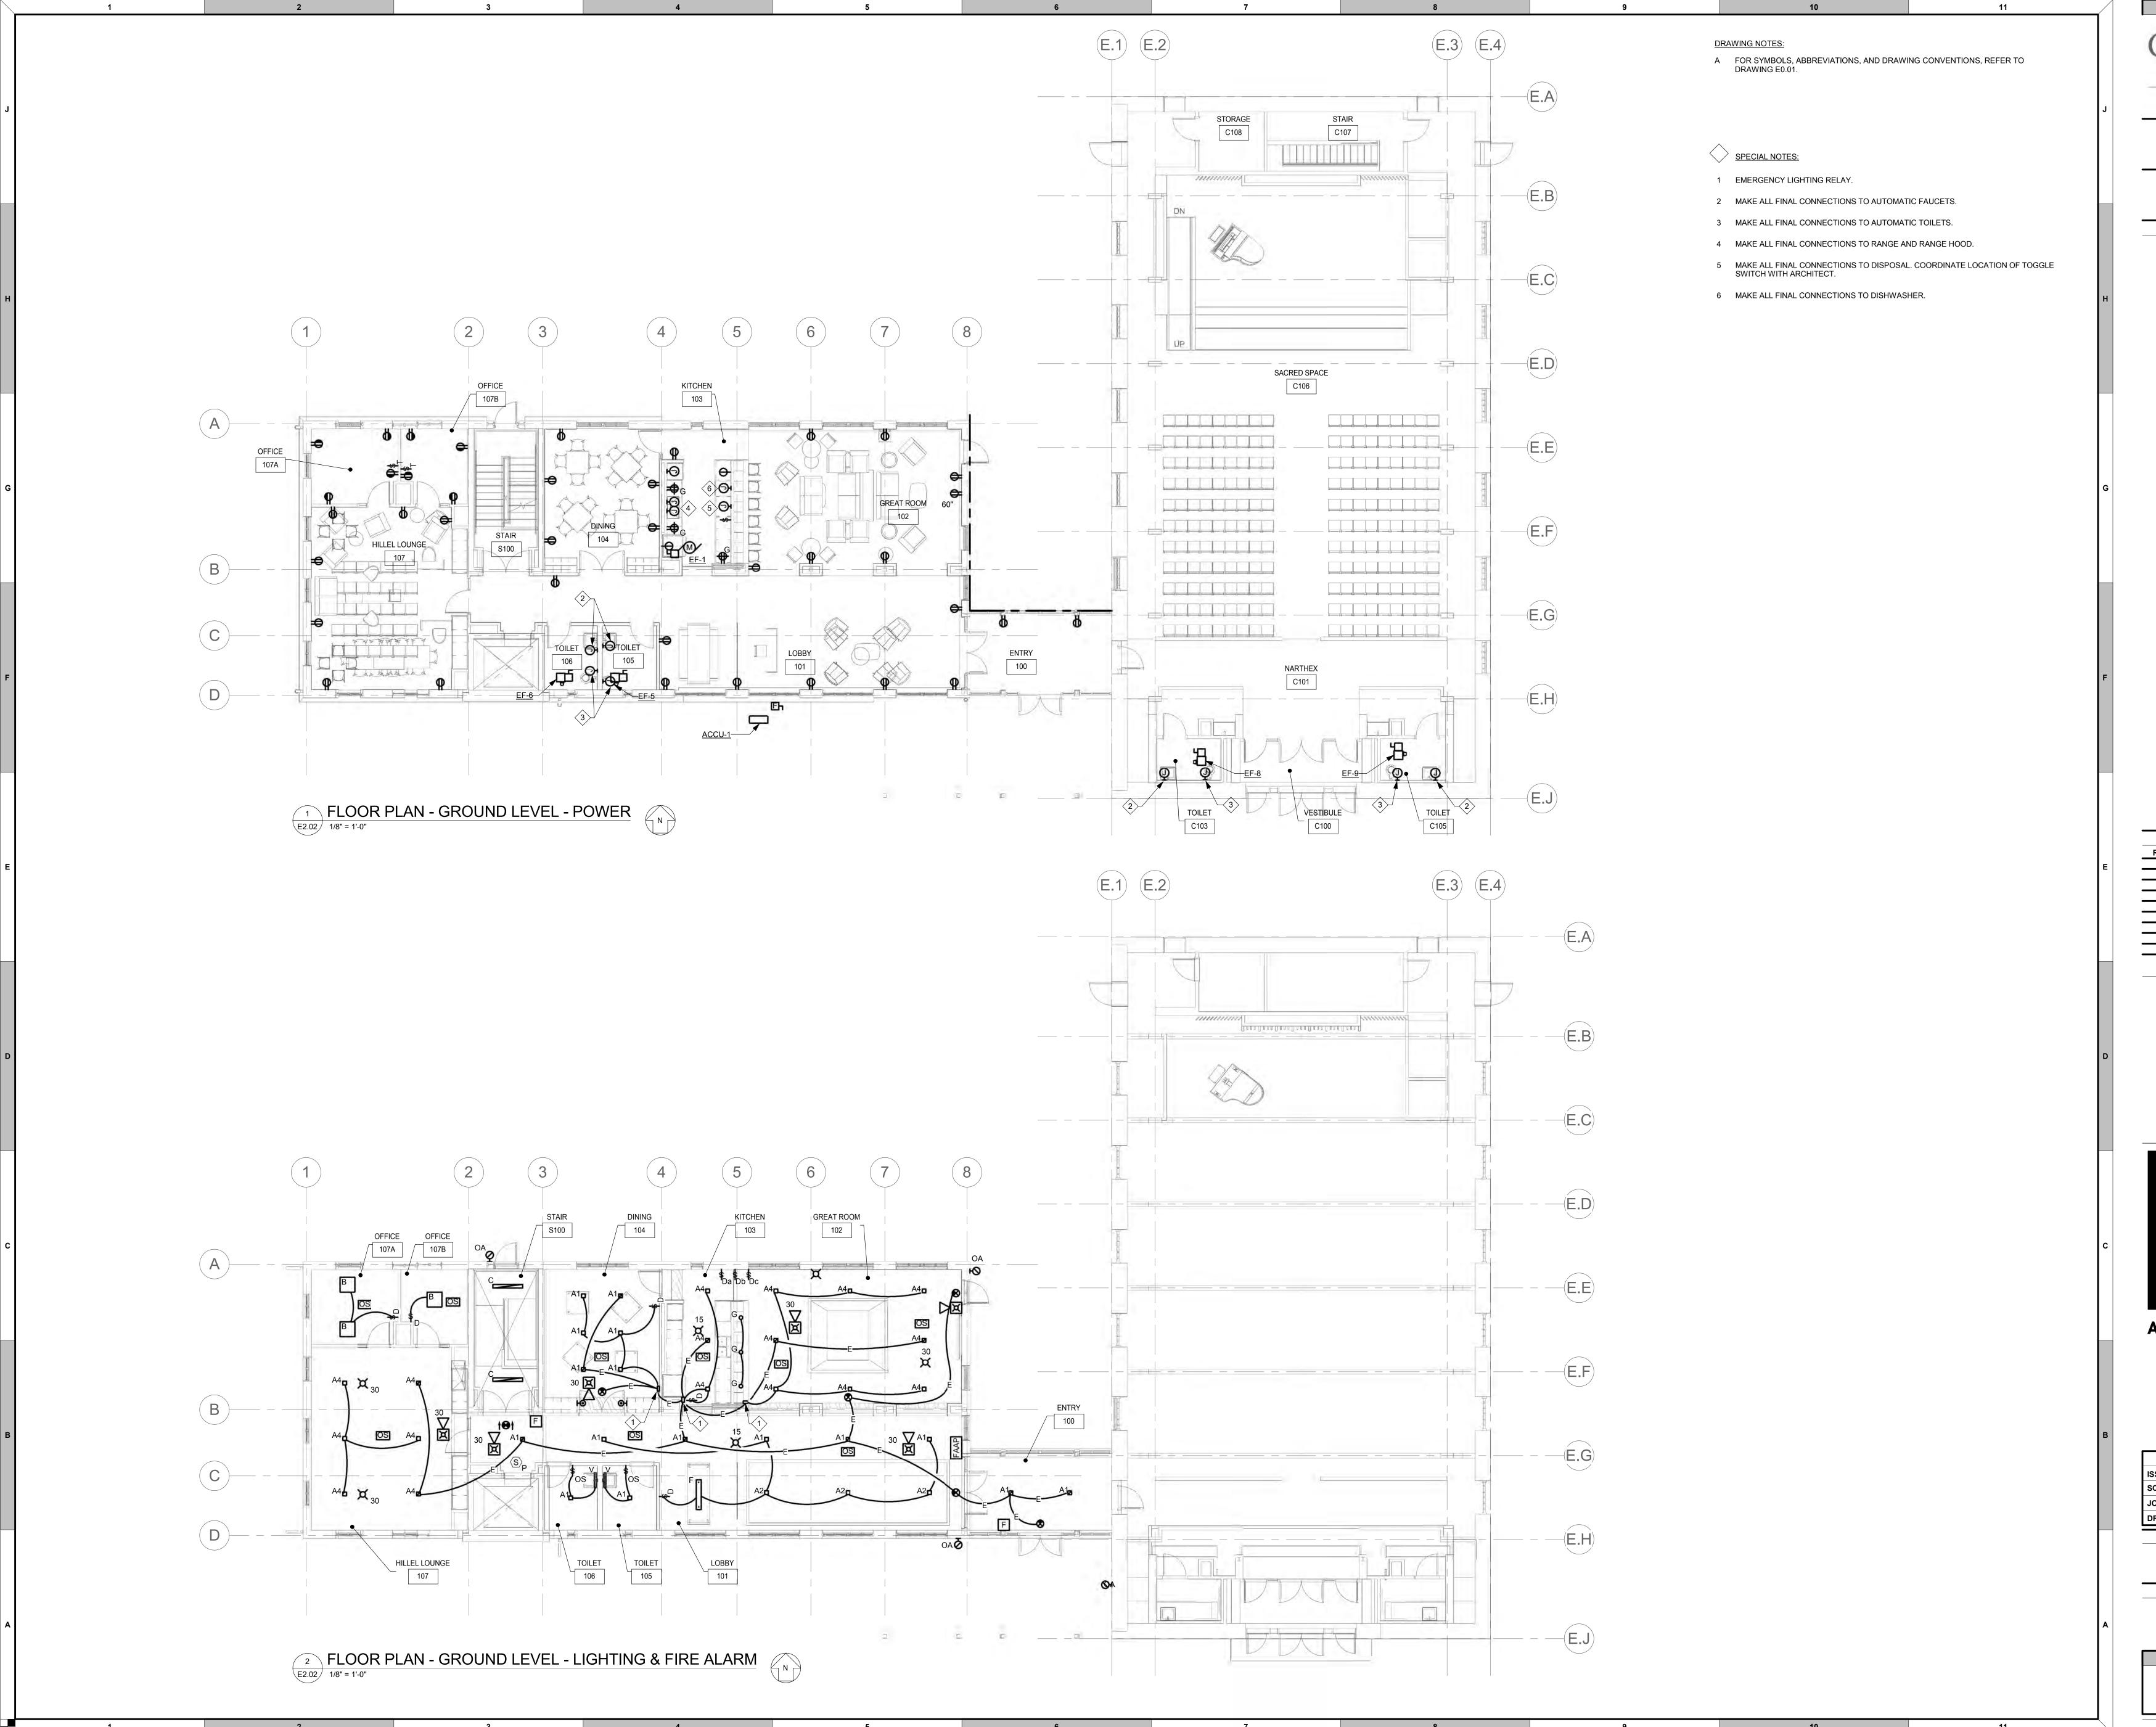

PROJECT INFORMATION

PROJECT TEAM

ARCHITECT AYERS SAINT GROSS 1040 HULL STREET, SUITE 100 BALTIMORE, MD 21230 410.347.8500 www.asg-architects.com

M/E/P & FIRE PROTECTION ENGINEER MUELLER ASSOCIATES 1306 CONCOURSE DRIVE, SUITE 100 LINTHICUM, MD 21090 410.646.4500 www.muellerassoc.com

STRUCTURAL ENGINEER MORABITO CONSULTANTS 952 RIDGEBROOK ROAD, SUITE 1700 SPARKS, MD 21152 410.467.2377 www.morabitoconsultants.com

CIVIL ENGINEER

BALTIMORE, MD 21286 410.512.4500 www.wbcm.com

300 EAST JOPPA ROAD, SUITE 200

LANDSCAPE ARCHITECT AYERS SAINT GROSS 1040 HULL STREET, SUITE 100 BALTIMORE, MD 21230 410.347.8500 www.asg-architects.com

IT / AV / SECURITY SPEXSYS 7257 PARKWAY DRIVE, SUITE 260 HANOVER, MD 21076

COMMISSIONING KIBART 901 DULANEY VALLEY ROAD, SUITE 301

TOWSON, MD 21204 410.494.1111 www.kibart.com


410.712.0390

www.spexsys.com

CODE CONSULTANT KOFFEL ASSOCIATES 8815 CENTRE PARK DRIVE, SUITE 200 COLUMBIA, MD 21045 410.750.2246 www.koffel.com

KEY PLAN

INTERFAITH CENTER

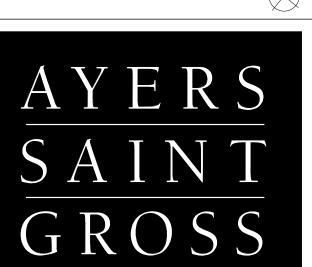

ARCHITECTS + PLANNERS

NOT FOR CONSTRUCTION


DRAWING INFORMATION	ı
ISSUE DATE:	04/26/17
SCALE:	1/8" = 1'-0"
JOB NO.:	21641.00
DRAWN BY:	Author

50% CONSTRUCTION DOCUMENTS

DRAWING NAME

FLOOR PLANS - GROUND **LEVEL - ELECTRICAL**

> DRAWING NUMBER **E2.02**

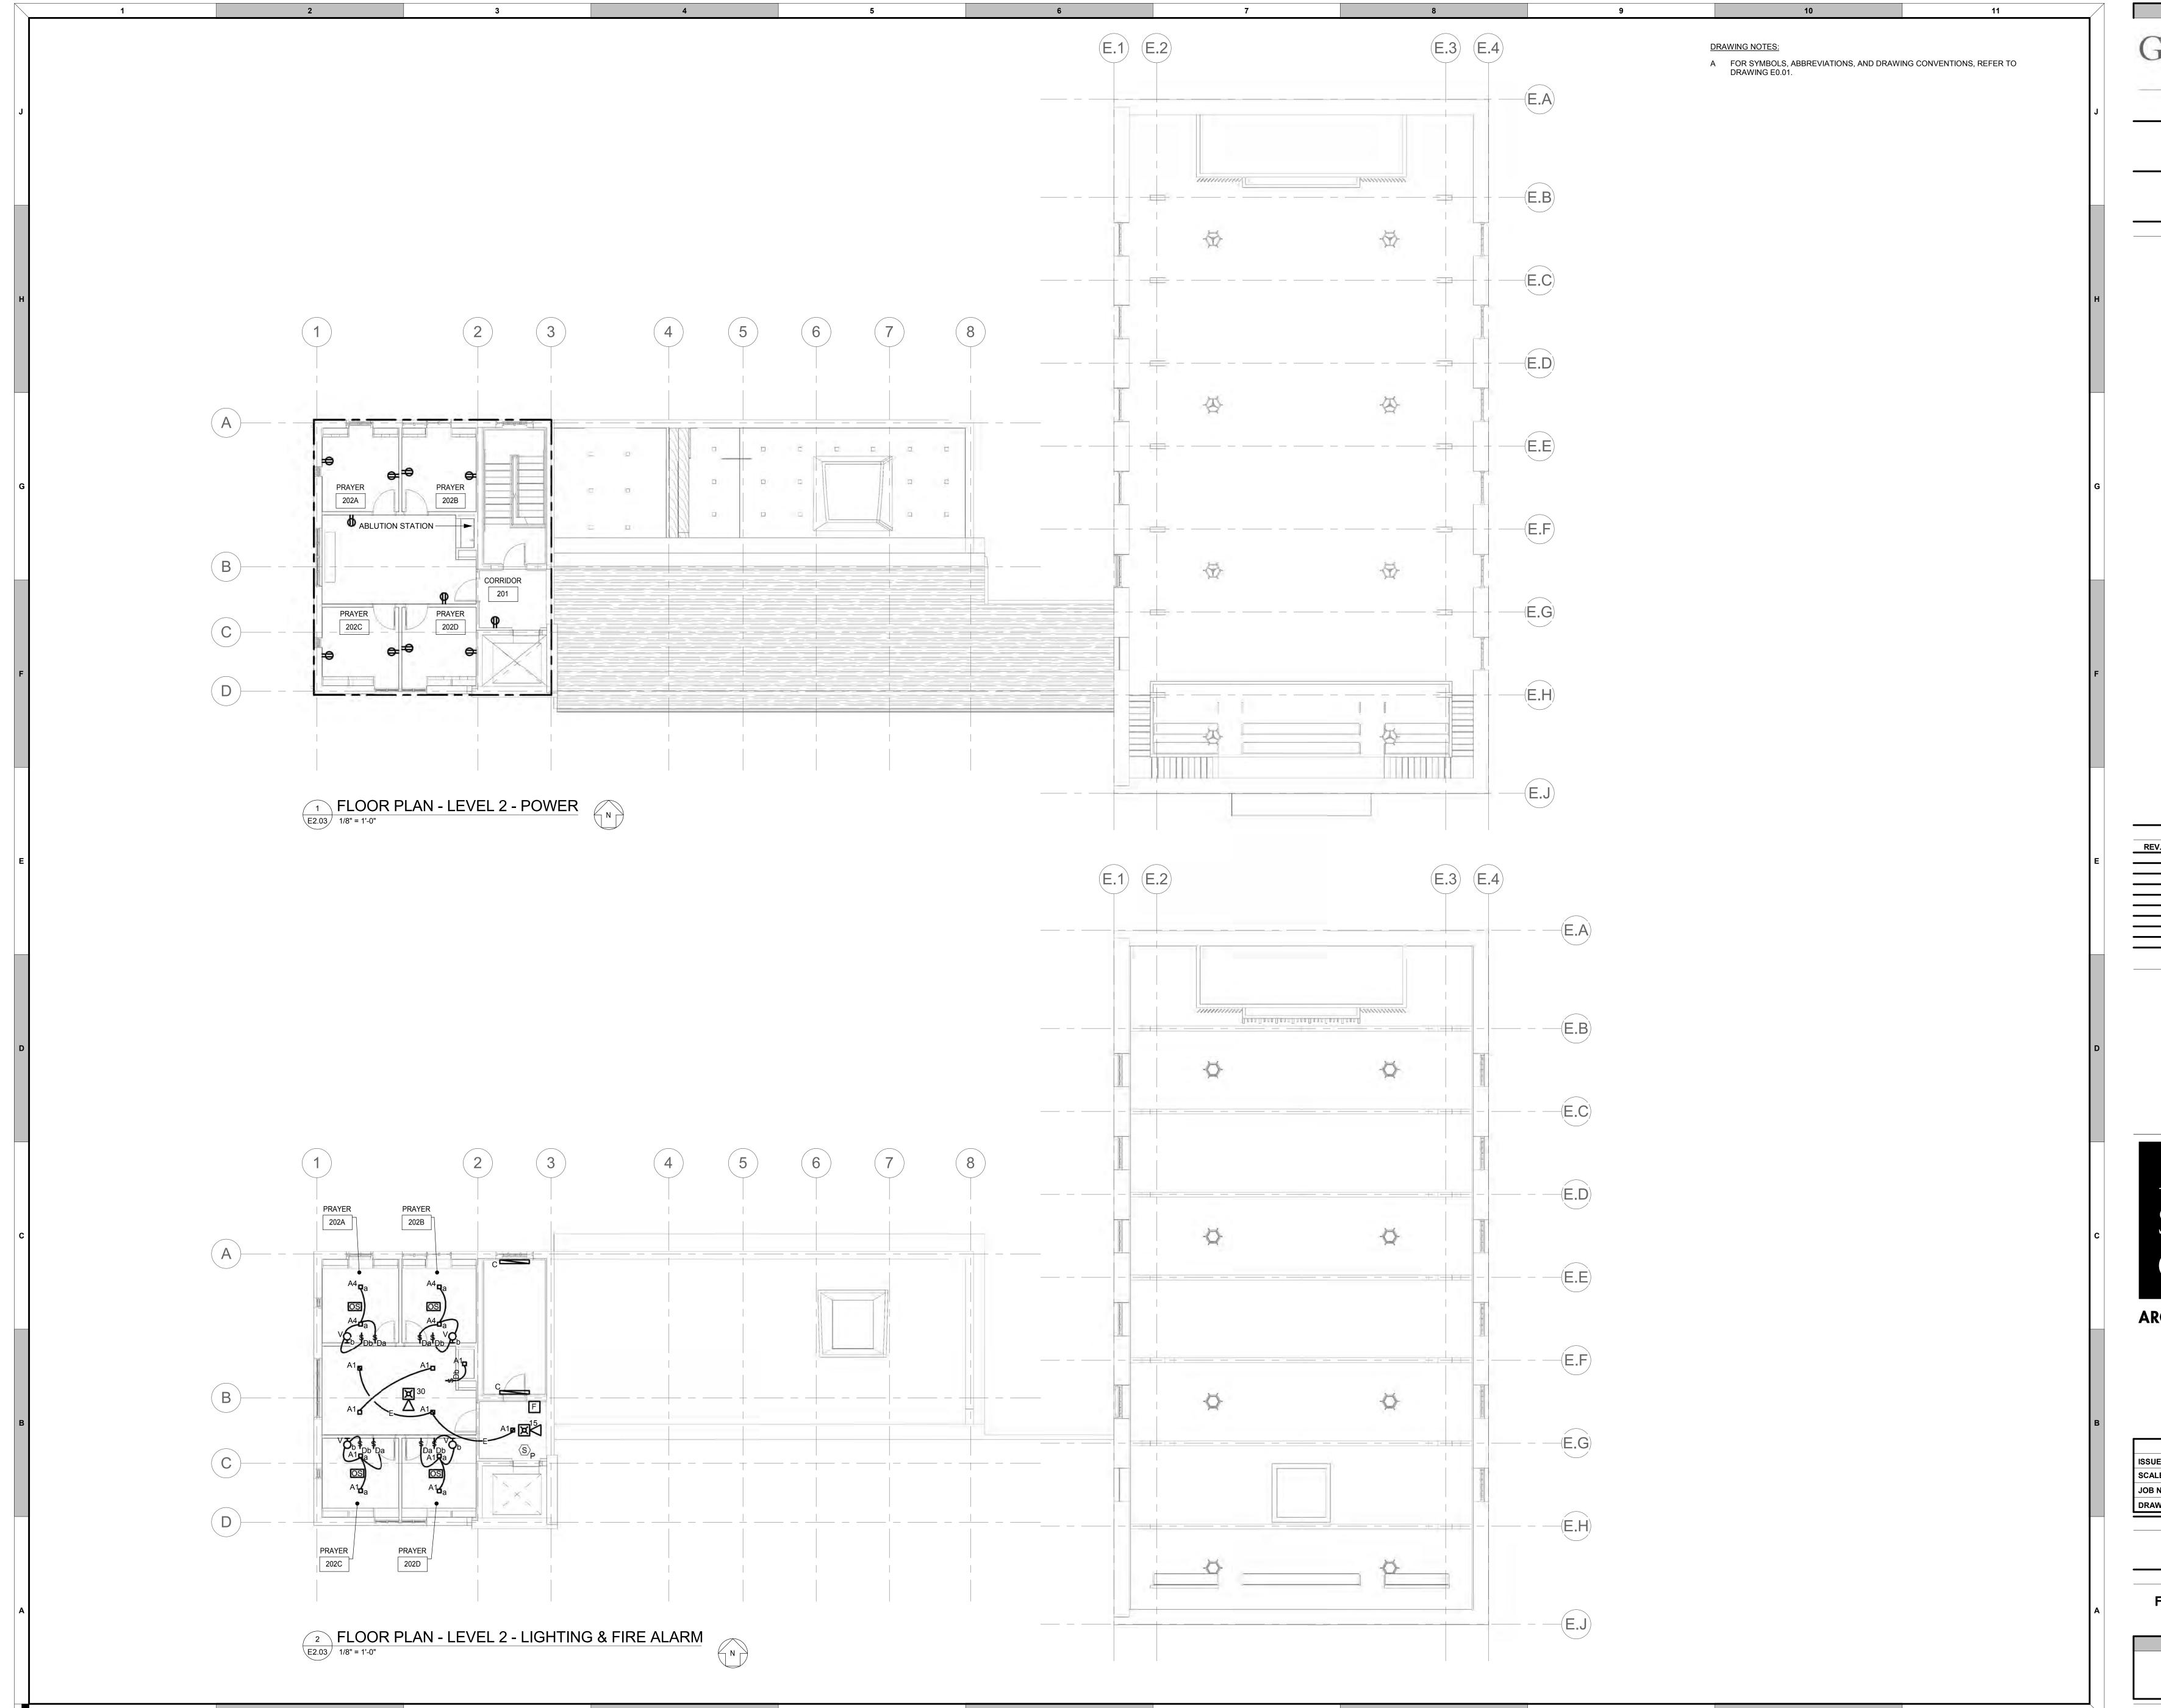

GOUCHER

-college-

PROJECT TEAM

ARCHITECT
AYERS SAINT GROSS
1040 HULL STREET, SUITE 100
BALTIMORE, MD 21230
410.347.8500
www.asg-architects.com

M/E/P & FIRE PROTECTION ENGINEER

MUELLER ASSOCIATES

1306 CONCOURSE DRIVE, SUITE 100
LINTHICUM, MD 21090
410.646.4500
www.muellerassoc.com

STRUCTURAL ENGINEER

MORABITO CONSULTANTS
952 RIDGEBROOK ROAD, SUITE 1700
SPARKS, MD 21152
410.467.2377
www.morabitoconsultants.com

CIVIL ENGINEER

WBCM

300 EAST JOPPA ROAD, SUITE 200 BALTIMORE, MD 21286 410.512.4500 www.wbcm.com

LANDSCAPE ARCHITECT
AYERS SAINT GROSS
1040 HULL STREET, SUITE 100
BALTIMORE, MD 21230
410.347.8500

www.asg-architects.com

IT / AV / SECURITY

SPEXSYS
7257 PARKWAY DRIVE, SUITE 260

HANOVER, MD 21076 410.712.0390 www.spexsys.com

KIBART 901 DULANEY VALLEY ROAD, SUITE 301 TOWSON, MD 21204 410.494.1111

WWW.kibart.com

CODE CONSULTANT

KOFFEL ASSOCIATES
8815 CENTRE PARK DRIVE, SUITE 200
COLUMBIA, MD 21045
410.750.2246
www.koffel.com

REV.# DESCRIPTION DATE

KEY PLAN

INTERFAITH CENTER

AYERS
SAINT
GROSS

ARCHITECTS + PLANNERS

NOT FOR CONSTRUCTION

DIAWING IN CIMIATION	
ISSUE DATE:	04/26/17
SCALE:	1/8" = 1'-0"
JOB NO.:	21641.00
DRAWN BY:	Author

50% CONSTRUCTION DOCUMENTS


DOCUMENTS

DRAWING NAME

FLOOR PLANS - LEVEL 2 -ELECTRICAL


DRAWING NUMBER

E2.03

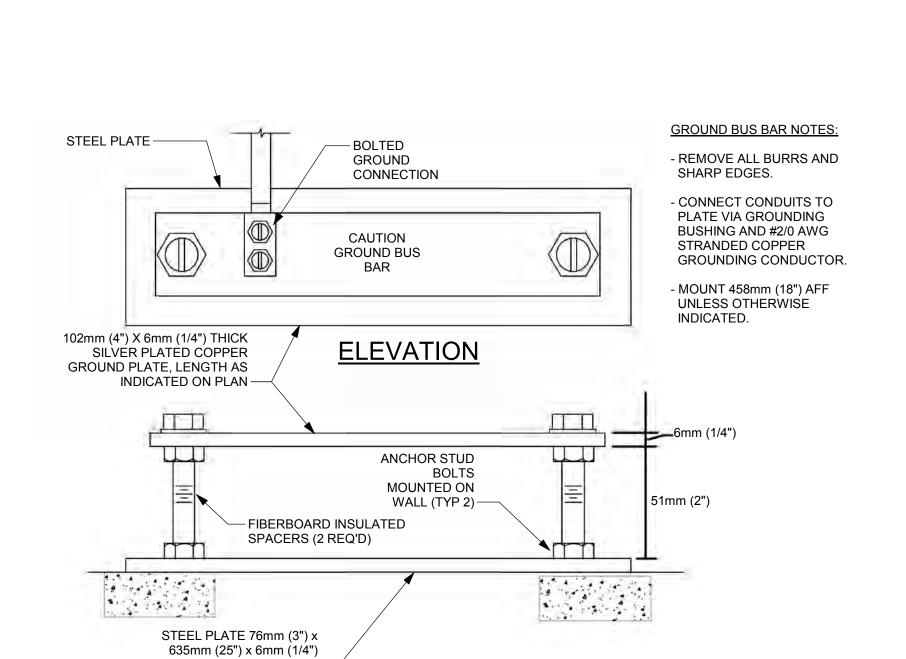


3 DETAIL - GROUND BUS BAR
E5.01 3/16" = 1'-0"

THICK—

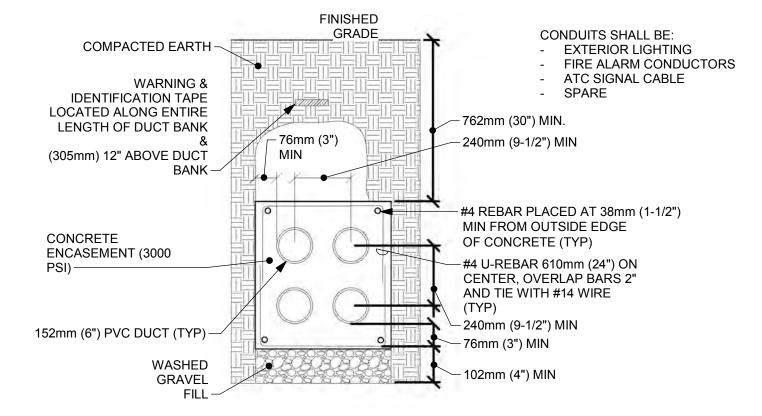

2 DETAIL - 4-WAY DUCT BANK E5.01 1/8" = 1'-0"

5

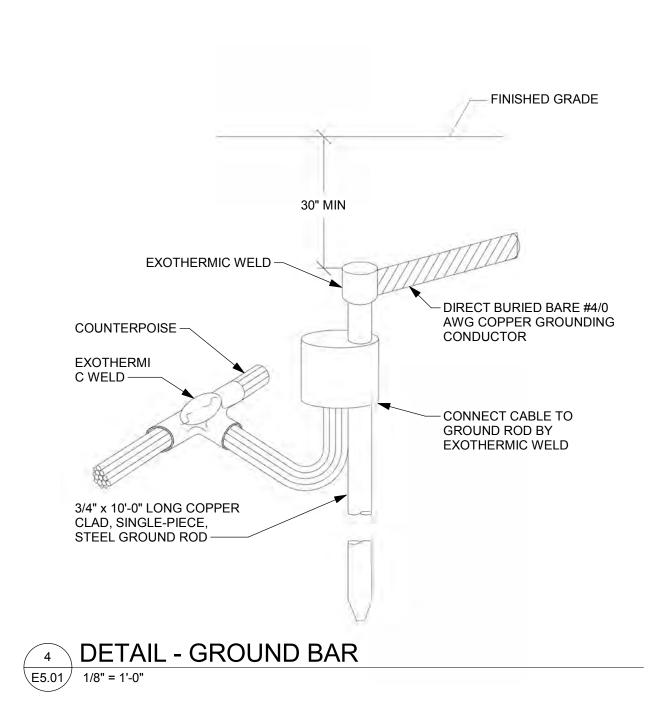

GOUCHER -college-

PROJECT INFORMATION

11

PROJECT TEAM

ARCHITECT
AYERS SAINT GROSS
1040 HULL STREET, SUITE 100
BALTIMORE, MD 21230
410.347.8500
www.asg-architects.com

M/E/P & FIRE PROTECTION ENGINEER

MUELLER ASSOCIATES

1306 CONCOURSE DRIVE, SUITE 100
LINTHICUM, MD 21090
410.646.4500
www.muellerassoc.com

STRUCTURAL ENGINEER

MORABITO CONSULTANTS

952 RIDGEBROOK ROAD, SUITE 1700

SPARKS, MD 21152

410.467.2377

410.467.2377
www.morabitoconsultants.com

CIVIL ENGINEER

300 EAST JOPPA ROAD, SUITE 200 BALTIMORE, MD 21286 410.512.4500 www.wbcm.com

AYERS SAINT GROSS 1040 HULL STREET, SUITE 100 BALTIMORE, MD 21230 410.347.8500

www.asg-architects.com

IT / AV / SECURITY

SPEXSYS
7257 PARKWAY DRIVE, SUITE 260
HANOVER, MD 21076

410.712.0390
www.spexsys.com

COMMISSIONING
KIBART

901 DULANEY VALLEY ROAD, SUITE 301 TOWSON, MD 21204 410.494.1111 www.kibart.com

CODE CONSULTANT


KOFFEL ASSOCIATES
8815 CENTRE PARK DRIVE, SUITE 200
COLUMBIA, MD 21045
410.750.2246
www.koffel.com

REVISIONS

REV. # DESCRIPTION DATE

KEY PLAN

INTERFAITH CENTER

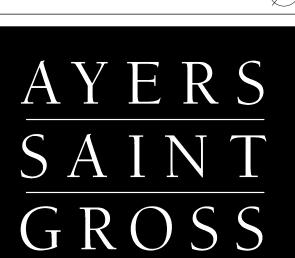

ARCHITECTS + PLANNERS

NOT FOR CONSTRUCTION

DRAWING INFORMATION

ISSUE DATE: 04/26/17

SCALE: As indicated

JOB NO.: 21641.00

DRAWN BY: Author

50% CONSTRUCTION DOCUMENTS

DRAWING NAME

DETAILS

DRAWING NUMBER

E5.01

1000A

— 3#10, #

10GND,

IN 3/4"C

SPD

— 3 SETS (4 600KCMIL,

400A

— 2 SETS

#3GND

IN 2"C)

#2/0GND

IN 4"C)

) 150A

TO ELEVATOR

+-----

TO <u>DWH-1</u>

A FOR SYMBOLS, ABBREVIATIONS, AND DRAWING CONVENTIONS, REFER TO

DRAWING E0.01.

— 3 350KCMIL, 5KV MV-105 CABLE WITH 133% INSULATION IN 4"C ___________ 4160V 500KVA 208Y/ = 120V UNITIZED SWITCHBOARD MSB 208Y/120V/1600A 1600A) 225A 225A #4GND #4GND IN 2-1/2"C IN 2-1/2"C) 225A) 225A PANEL 400A 100A 100A — 2 SETS — 4#4, #8GND — 4#3, #8GND — 4#3, #8GND IN 1-1/4"C IN 1-1/4"C IN 1-1/4"C #3GND IN 2"C)) 400A 400A DIMMING PANEL PANEL | | <u>C2</u> | |

LIGHTING FIXTURE SCHEDULE								
FIXTURE TYPE	MOUNTING	MANUFACTUR ER(S)	CATALOG OR MODEL NUMBER	LAMPS (NOTE 1)	VOLTS	REMARKS		
A1	CEILING RECESSED	PORTFOLIO	LDSQ6B10D010TR DRIVER: EU6B10209030 TRIM: 6LBSQ0LI	LED 1000 LUMEN 3000 DEG	120	6" SQUARE LED DOWNLIGHT WITH WHITE TRIM, SPECULAR CLEAR REFLECTOR, AND 0-10VDC DIMMING DRIVER.		
A2	CEILING RECESSED	PORTFOLIO	LDSQ6B15D010TR DRIVER: EU6B10209030 TRIM: 6LBSQ0LI	LED 1500 LUMEN 3000 DEG	120	6" SQUARE LED DOWNLIGHT WITH WHITE TRIM, SPECULAR CLEAR REFLECTOR, ANI 0-10VDC DIMMING DRIVER.		
A3	CEILING RECESSED	PORTFOLIO	LDSQ6B20D010TR DRIVER: EU6B10209030 TRIM: 6LBSQ0LI	LED 2000 LUMEN 3000 DEG	120	6" SQUARE LED DOWNLIGHT WITH WHITE TRIM, SPECULAR CLEAR REFLECTOR, ANI 0-10VDC DIMMING DRIVER.		
A4	CEILING RECESSED	PORTFOLIO	LDSQ6B30D010TR DRIVER: EU6B30509030 TRIM: 6LBSQ0LI	LED 3000 LUMEN 3000 DEG	120	6" SQUARE LED DOWNLIGHT WITH WHITE TRIM, SPECULAR CLEAR REFLECTOR, AN 0-10VDC DIMMING DRIVER.		
В	CEILING RECESSED	PHILLIPS DAY-BRITE	2CAG38L830-2-DS-UNV-DIM	LED 3800 LUMEN 3000 DEG	120	2' x 2' RECESSED LED TROFFER WITH 0-10VDC DIMMING DRIVER.		
С	CEILING/WALL SURFACE	PHILLIPS DAY-BRITE	SF4C29A35UDZT-US	LED 2900 LUMEN 3000 DEG	120	SURFACE LED STAIRWELL FIXTURE WITH WHITE HOUSING, ACRYLIC LENS, AND INTEGRAL ULTRASONIC OCCUPANCY SENSOR. CEILING OR WALL MOUNT AS INDICATED. WHERE WALL MOUNTED, MOUNT 96"AFF. SET FIXTURE TO REDUCE LIGHTING TO 20% OUTPUT WHEN AREA IS UNOCCUPIED.		
D	CEILING PENDANT	VERGE	VG-2WDC-XX-30 DRIVER: PSC-100W-ELV-24VDC	LED 2.5W/LF 3000 DEG	120	LED COVE STRIP WITH 0-10VDC DIMMING DRIVER. REFER TO ARCHITECTURAL PLANS FOR MOUNTING DETAILS. VERIFY DIMMER TYPE WITH MANUFACTURER.		
F	CEILING PENDANT	CORELIGHT	I2-WS-1L30-1D-UNV-AC48-ST-4-ST D-SV-W-EB	LED 3000 LUMEN 3000 DEG 3000 DEG	120	4' LED PENDANT WITH 0-10VDC DIMMING DRIVER.		
G	CEILING PENDANT	FEISS	P1391ORB	LED 950 LUMEN 2700 DEG	120	12" LED GLOBE PENDANT.		
OA	WALL SURFACE	BEGA	2383 LED BRZ K4	LED 4000 DEG	120	EXTERIOR WALL SCONCE WITH INTEGRAL PHOTOCELL.		
S	CEILING SURFACE	METALUX	4SNLED-LD4-41SL-LN-UNV-L830- CD1-U	LED 4200 LUMEN 3000 DEG	120	4' LED INDUSTRIAL STRIP.		
V	WALL SURFACE	RICH BRILLIANT WILLING	BRE-SM-3-30	LED 2160 LUMEN 3000 DEG	120	2' WALL SCONCE WITH GOLD FINISH AND 0-10VDC DIMMING DRIVER. MOUNT HORIZONTALLY OVER MIRRORS IN TOILETS. MOUNT VERTICALLY IN PRAYER ROOMS 60"AFF.		

1 SINGLE LINE DIAGRAM E6.01 NOT TO SCALE

		LOAD		1		LOCAL DIS	SCONNECT		CONTR	ROLLER		CIRCUIT			
SERVES			Ì	VOLTS	PH	DEVICE	SIZE	DISCO	NNECT	TYPE	NEMA	14#DE	1		REMARKS
	HP	kVA	AMPS			DEVICE	SIZE	DEVICE	SIZE	ITPE	SIZE	WIRE	GND	C"	
ACCU-1		2.5	12.0	208	1	FS	30	-	-	-	-	2#12	#12	3/4	
ACU-1		0.2	1.0	208	1	-	-	-	-	-	-	2#12	#12	3/4	
AHU-1		0.0	0.0	120	1	-	-	-	-	-	-				HIDE
CUH-1		0.3	2.5	120	1	-	-	-	-	-	-	2#12	#12	3/4	
CUH-2		0.3	2.5	120	1	-	-	-	-	-	-	2#12	#12	3/4	
DWH-1		9.0	25.0	208	3	-	-	-	-	-	-	3#8	#10	3/4	
EF-1		0.1	1.2	120	1	NFS	30A	-	-	-	-	2#12	#12	3/4	
EF-2	1/2	0.0	0.0	120	1	NFS	30A	-	-	-	-	2#12	#12	3/4	
EF-3		0.1	1.1	120	1	NFS	30A	-	-	-	-	2#12	#12	3/4	
EF-4		0.1	1.1	120	1	NFS	30A	-	-	-	-	2#12	#12	3/4	
EF-5		0.1	1.1	120	1	NFS	30A	-	-	-	-	2#12	#12	3/4	
EF-6		0.1	1.1	120	1	NFS	30A	-	-	-	-	2#12	#12	3/4	
EF-7		0.1	0.7	120	1	NFS	30A	-	-	-	-	2#12	#12	3/4	
EF-8		0.1	0.7	120	1	NFS	30A	-	-	-	-	2#12	#12	3/4	
EF-9		0.1	0.7	120	1	NFS	30A	-	-	-	-	2#12	#12	3/4	
ELEVATOR	30	33.1	91.9	208	3	FS	200	-	-	-	-	3#2	#6	1-1/2	
F-SA-1	3	4.0	11.0	208	3	-	-	MCP	15	VFC	-	3#12	#12	3/4	
FCU-4HC-C	1/12	0.2	1.3	120	1	-	-	-	-	-	-	2#12	#12	3/4	
FCU-4HC-C	1/12	0.2	1.3	120	1	-	-	-	-	-	-	2#12	#12	3/4	
FCU-4HC-C	1/12	0.2	1.3	120	1	-	-	-	-	-	-	2#12	#12	3/4	
FCU-4HC-C	1/12	0.2	1.3	120	1	-	-	-	-	-	-	2#12	#12	3/4	
FCU-6HC-C	1/12	0.2	1.3	120	1	-	-	-	-	-	-	2#12	#12	3/4	
FCU-6HC-C	1/12	0.2	1.3	120	1	-	-	-	-	-	-	2#12	#12	3/4	
FCU-6HC-C	1/12	0.2	1.3	120	1	-	-	-	-	-	-	2#12	#12	3/4	
FCU-6HC-C	1/12	0.2	1.3	120	1	-	-	-	-	-	-	2#12	#12	3/4	
FCU-6HC-C	1/12	0.2	1.3	120	1	-	-	-	-	-	-	2#12	#12	3/4	
FCU-6HC-C	1/12	0.2	1.3	120	1	-	-	-	-	-	-	2#12	#12	3/4	
FCU-6VC	1/5	0.1	0.6	208	1	-	-	-	-	-	-	2#12	#12	3/4	
FCU-6VC	1/5	0.1	0.6	208	1	-	-	-	-	-	-	2#12	#12	3/4	
FCU-6VC	1/5	0.1	0.6	208	1	-	-	-	-	-	-	2#12	#12	3/4	
FCU-8HC-C	1/6	0.3	2.3	120	1	-	-	-	-	-	-	2#12	#12	3/4	
FCU-8VC	1/5	0.3	1.4	208	1	-	-	-	-	-	-	2#12	#12	3/4	
FCU-8VC	1/5	0.3	1.4	208	1	-	-	-	-	-	-	2#12	#12	3/4	
FCU-8VC	1/5	0.3	1.4	208	1	-	-	-	-	-	-	2#12	#12	3/4	
FCU-8VC	1/5	0.3	1.4	208	1	-	-	-	-	-	-	2#12	#12	3/4	
P-CHW-1	5	6.3	17.6	208	3	-	-	MCP	30	VFC	-	3#10	#10	3/4	
P-CHW-2	5	6.3	17.6	208	3	-	-	MCP	30	VFC	-	3#10	#10	3/4	
P-ELEV-1	0.5	1.1	9.4	120	1	-	-	-	-	-	-	2#12	#12	3/4	PROVIDED WITH CONTROL PANEL
P-HHW-1	1-1/2	2.2	6.0	208	3	-	-	MCP	15	VFC	-	3#12	#12	3/4	
P-HHW-2	1-1/2	2.2	6.0	208	3	-	-	MCP	15	VFC	-	3#12	#12	3/4	
P-PHC-1		0.6	4.8	120	1	NFS	30	-	-	-	-	2#12	#12	3/4	
UH-1		0.2	1.3	120	1	-	-	-	-	-	-	2#12	#12	3/4	
UH-2		0.2	1.3	120	1	_	-	_	_	_	-	2#12	#12	3/4	

PROJECT INFORMATION

11

PROJECT TEAM

ARCHITECT AYERS SAINT GROSS 1040 HULL STREET, SUITE 100 BALTIMORE, MD 21230 410.347.8500 www.asg-architects.com

M/E/P & FIRE PROTECTION ENGINEER MUELLER ASSOCIATES 1306 CONCOURSE DRIVE, SUITE 100 LINTHICUM, MD 21090 410.646.4500 www.muellerassoc.com

STRUCTURAL ENGINEER MORABITO CONSULTANTS 952 RIDGEBROOK ROAD, SUITE 1700 SPARKS, MD 21152 410.467.2377

www.morabitoconsultants.com **CIVIL ENGINEER**

300 EAST JOPPA ROAD, SUITE 200 BALTIMORE, MD 21286 410.512.4500 www.wbcm.com

LANDSCAPE ARCHITECT AYERS SAINT GROSS 1040 HULL STREET, SUITE 100 BALTIMORE, MD 21230 410.347.8500

www.asg-architects.com IT / AV / SECURITY SPEXSYS 7257 PARKWAY DRIVE, SUITE 260

410.712.0390 www.spexsys.com COMMISSIONING


HANOVER, MD 21076


KIBART 901 DULANEY VALLEY ROAD, SUITE 301 TOWSON, MD 21204 410.494.1111 www.kibart.com

KOFFEL ASSOCIATES 8815 CENTRE PARK DRIVE, SUITE 200 COLUMBIA, MD 21045 410.750.2246 www.koffel.com

CODE CONSULTANT

	REVISIONS	
REV.#	DESCRIPTION	DATE
		· ——
		·
	KEY PLAN	

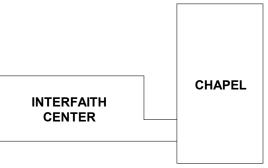

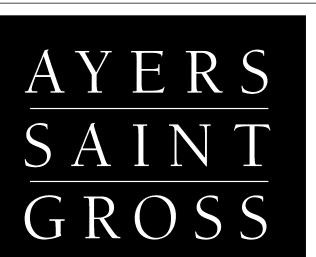

ARCHITECTS + PLANNERS

NOT FOR CONSTRUCTION

DRAWING INFOR	RMATION
ISSUE DATE:	04/26/17
SCALE:	1/8" = 1'-0"
JOB NO.:	21641.00
DRAWN BY:	Author
PROJECT DESIG	N PHASE

50% CONSTRUCTION DOCUMENTS

DRAWING NAME

ONE LINE DIAGRAM &

SCHEDULES DRAWING NUMBER

E6.01

CABLING:

INSTALL (#) CATEGORY 6 CABLES FOR DATA AND TERMINATE WITH CATEGORY 6 JACKS, WHERE # REPRESENTS THE QUANTITY OF CABLES. AT THE DEVICE LOCATION, INSTALL IN A SINGLE-GANG FACEPLATE MOUNTED AT 18" AFF (UON). IN THE TR, TERMINATE CABLES ON RACK-MOUNTED CATEGORY 6 PATCH PANELS.

LEGEND

11

- INSTALL TWO (2) CATEGORY 6A CABLES AND TERMINATE WITH CATEGORY 6A JACKS FOR A WIRELESS ACCESS POINT. INSTALL JACKS IN A BISCUIT-TYPE BOX WITH 20' OF CABLE COILED. IN THE TR, TERMINATE CABLES ON RACK-MOUNTED CATEGORY 6A PATCH PANELS.
- INSTALL ONE (1) CATEGORY 6 CABLE AND TERMINATE WITH A CATEGORY 6 JACK FOR A SECURITY CAMERA. INSTALL JACK IN A BISCUIT-TYPE BOX. IN THE TR, TERMINATE CABLE ON RACK-MOUNTED CATEGORY 6 PATCH PANELS.
- INSTALL ONE (1) CATEGORY 6 CABLE AND TERMINATE WITH A CATEGORY 6 JACK FOR A FLAT SCREEN DISPLAY. INSTALL JACK IN A SINGLE-GANG FACEPLATE ASSOCIATED WITH THE LOCATION OF THE DISPLAY (SEE AV DRAWINGS FOR DETAILS). IN THE TR, TERMINATE CABLE ON A RACK-MOUNTED CATEGORY 6 PATCH PANEL
- INSTALL ONE (1) CATEGORY 6 CABLE FOR AN ELEVATOR PHONE AND LEAVE 20' OF UNTERMINATED CABLE COILED IN ELEVATOR MACHINE ROOM. IN TR. TERMINATE CABLE ON RACK-MOUNTED CATEGORY 6 PATCH PANELS.
- INSTALL ONE (1) CATEGORY 6 CABLE AND TERMINATE WITH A CATEGORY 6 JACK FOR AN EMERGENCY TELEPHONE. INSTALL JACK IN A BISCUIT-TYPE BOX COILED IN A TELEPHONE FLUSH MOUNTING SLEEVE MOUNTED AT 42" AFF (UON). IN THE TR, TERMINATE THE CABLE ON A RACK-MOUNTED CATEGORY 6 PATCH PANEL
- INDICATES CABLES SHALL BE INSTALLED IN A FLOORBOX.
- INDICATES CABLES SHALL BE INSTALLED IN THE CEILING.

AUDIO VISUAL:

- DIGITAL TRANSMITTER INTERFACE POINT FOR HDMI, COMPUTER AUDIO AND COMPUTER
- PASSIVE CABLE CONNECTION INTERFACE POINT FOR HDMI. COMPUTER AUDIO AND COMPUTER VIDEO
- WALL-MOUNTED AV CONTROL PANEL
- DISPLAY, WHERE ## IS THE DIAGONAL SCREEN SIZE IN INCHES.

ASSISTED LISTENING TRANSMITTER

- AV SPKR1 COLUMN-ARRAY LOUDSPEAKER
- CEILING SPEAKER

SECURITY:

DETAIL DESIGNATION NUMBER DENOTES DETAIL IDENTIFICATION

INDICATES DRAWING NUMBER WHERE DETAIL IS DRAWN

T4.00

WALL-MOUNTED PROXIMITY CARD READER

DOOR POSITION SWITCH

GOUCHER

PROJECT INFORMATION

GOLDSMITH INTERFAITH **CENTER**

GOUCHER COLLEGE 1021 DULANEY VALLEY RD

BALTIMORE MD 21204

PROJECT TEAM

ARCHITECT **AYERS SAINT GROSS** 1040 HULL STREET, SUITE 100 BALTIMORE, MD 21230

410.347.8500 www.asg-architects.com

LINTHICUM, MD 21090

M/E/P & FIRE PROTECTION ENGINEE MUELLER ASSOCIATES 1306 CONCOURSE DRIVE, SUITE 100 410.646.4500

www.muellerassoc.com STRUCTURAL ENGINEER

MORABITO CONSULTANTS 952 RIDGEBROOK ROAD, SUITE 1700 SPARKS, MD 21152 410.467.2377

www.morabitoconsultants.con CIVIL ENGINEER

300 EAST JOPPA ROAD, SUITE 200 BALTIMORE, MD 21286 410.512.4500 www.wbcm.com


LANDSCAPE ARCHITECT **AYERS SAINT GROSS** 1040 HULL STREET, SUITE 100 BALTIMORE, MD 21230 410.347.8500 www.asg-architects.com

IT / AV / SECURITY SPEXSYS 7257 PARKWAY DRIVE, SUITE 260 HANOVER, MD 21076

410.712.0390

REVISIONS DESCRIPTION

KEY PLAN

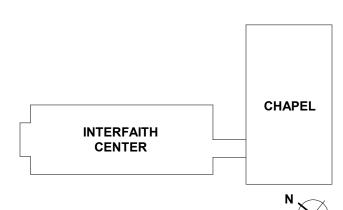

AYERS SAINT GROSS

ARCHITECTS + PLANNERS

NOT FOR CONSTRUCTION

ISSUE DATE: 1/4" = 1'-0 JOB NO.: DRAWN BY:

PROJECT DESIGN PHASE 50% CONSTRUCTION

TECHNOLOGY SYSTEMS

DOCUMENTS DRAWING NAME

NOTES, SYMBOLS, AND **ABBREVIAIONS** DRAWING NUMBER

T0.10

5

1 -03 LOWER LEVEL 1/8" = 1'-0"

(E.3) (E.4) -(E.A)-(E.B)(**E.C**) (**E.D**) A E.E) STORAGE QUIET LOUNGE -(E.F)BUILDING SUPPORT B EXISTING TELECOM ROOM JANITOR 009 (**E.G**) <u>C</u> D (E.H) 004 005 EV1 E.J

PROJECT INFORMATION

11

GOLDSMITH INTERFAITH **CENTER**

GOUCHER COLLEGE 1021 DULANEY VALLEY RD

BALTIMORE MD 21204

PROJECT TEAM **ARCHITECT** AYERS SAINT GROSS

1040 HULL STREET, SUITE 100 BALTIMORE, MD 21230 410.347.8500 www.asg-architects.com

M/E/P & FIRE PROTECTION ENGINEER MUELLER ASSOCIATES 1306 CONCOURSE DRIVE, SUITE 100 LINTHICUM, MD 21090 410.646.4500

www.muellerassoc.com STRUCTURAL ENGINEER MORABITO CONSULTANTS 952 RIDGEBROOK ROAD, SUITE 1700

SPARKS, MD 21152 410.467.2377 www.morabitoconsultants.com


CIVIL ENGINEER 300 EAST JOPPA ROAD, SUITE 200 BALTIMORE, MD 21286 410.512.4500 www.wbcm.com

LANDSCAPE ARCHITECT AYERS SAINT GROSS 1040 HULL STREET, SUITE 100 BALTIMORE, MD 21230 410.347.8500 www.asg-architects.com

IT / AV / SECURITY SPEXSYS 7257 PARKWAY DRIVE, SUITE 260 HANOVER, MD 21076 410.712.0390

REV. # DESCRIPTION

INTERFAITH CENTER

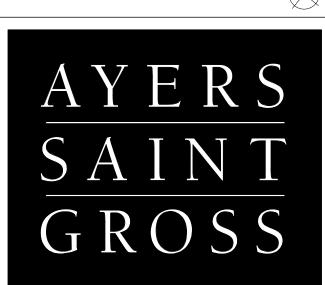

ARCHITECTS + PLANNERS

NOT FOR CONSTRUCTION

ISSUE DATE: 1/8" = 1'-0" JOB NO.: DRAWN BY: PROJECT DESIGN PHASE

50% CONSTRUCTION DOCUMENTS

DRAWING NAME **TECHNOLOGY SYSTEMS**

> DRAWING NUMBER **T2.00**

FLOOR PLAN - LOWER LEVEL


GENERAL NOTES:

1. ALL CABLING ON THIS SHEET SHALL BE TERMINATED IN THE LOWER LEVEL TELECOM ROOM.

3

5

- SEE T4.00 FOR ADDITIONAL AUDIO VISUAL SYSTEM REQUIREMENTS.
- PROVIDE TWO (2) SHURE QLXD14/SM35 WIRELESS MICROPHONE SYSTEMS FOR INTEGRATION BY CONTRACTOR WITH EXISTING CHAPEL AUDIO SYSTEM.

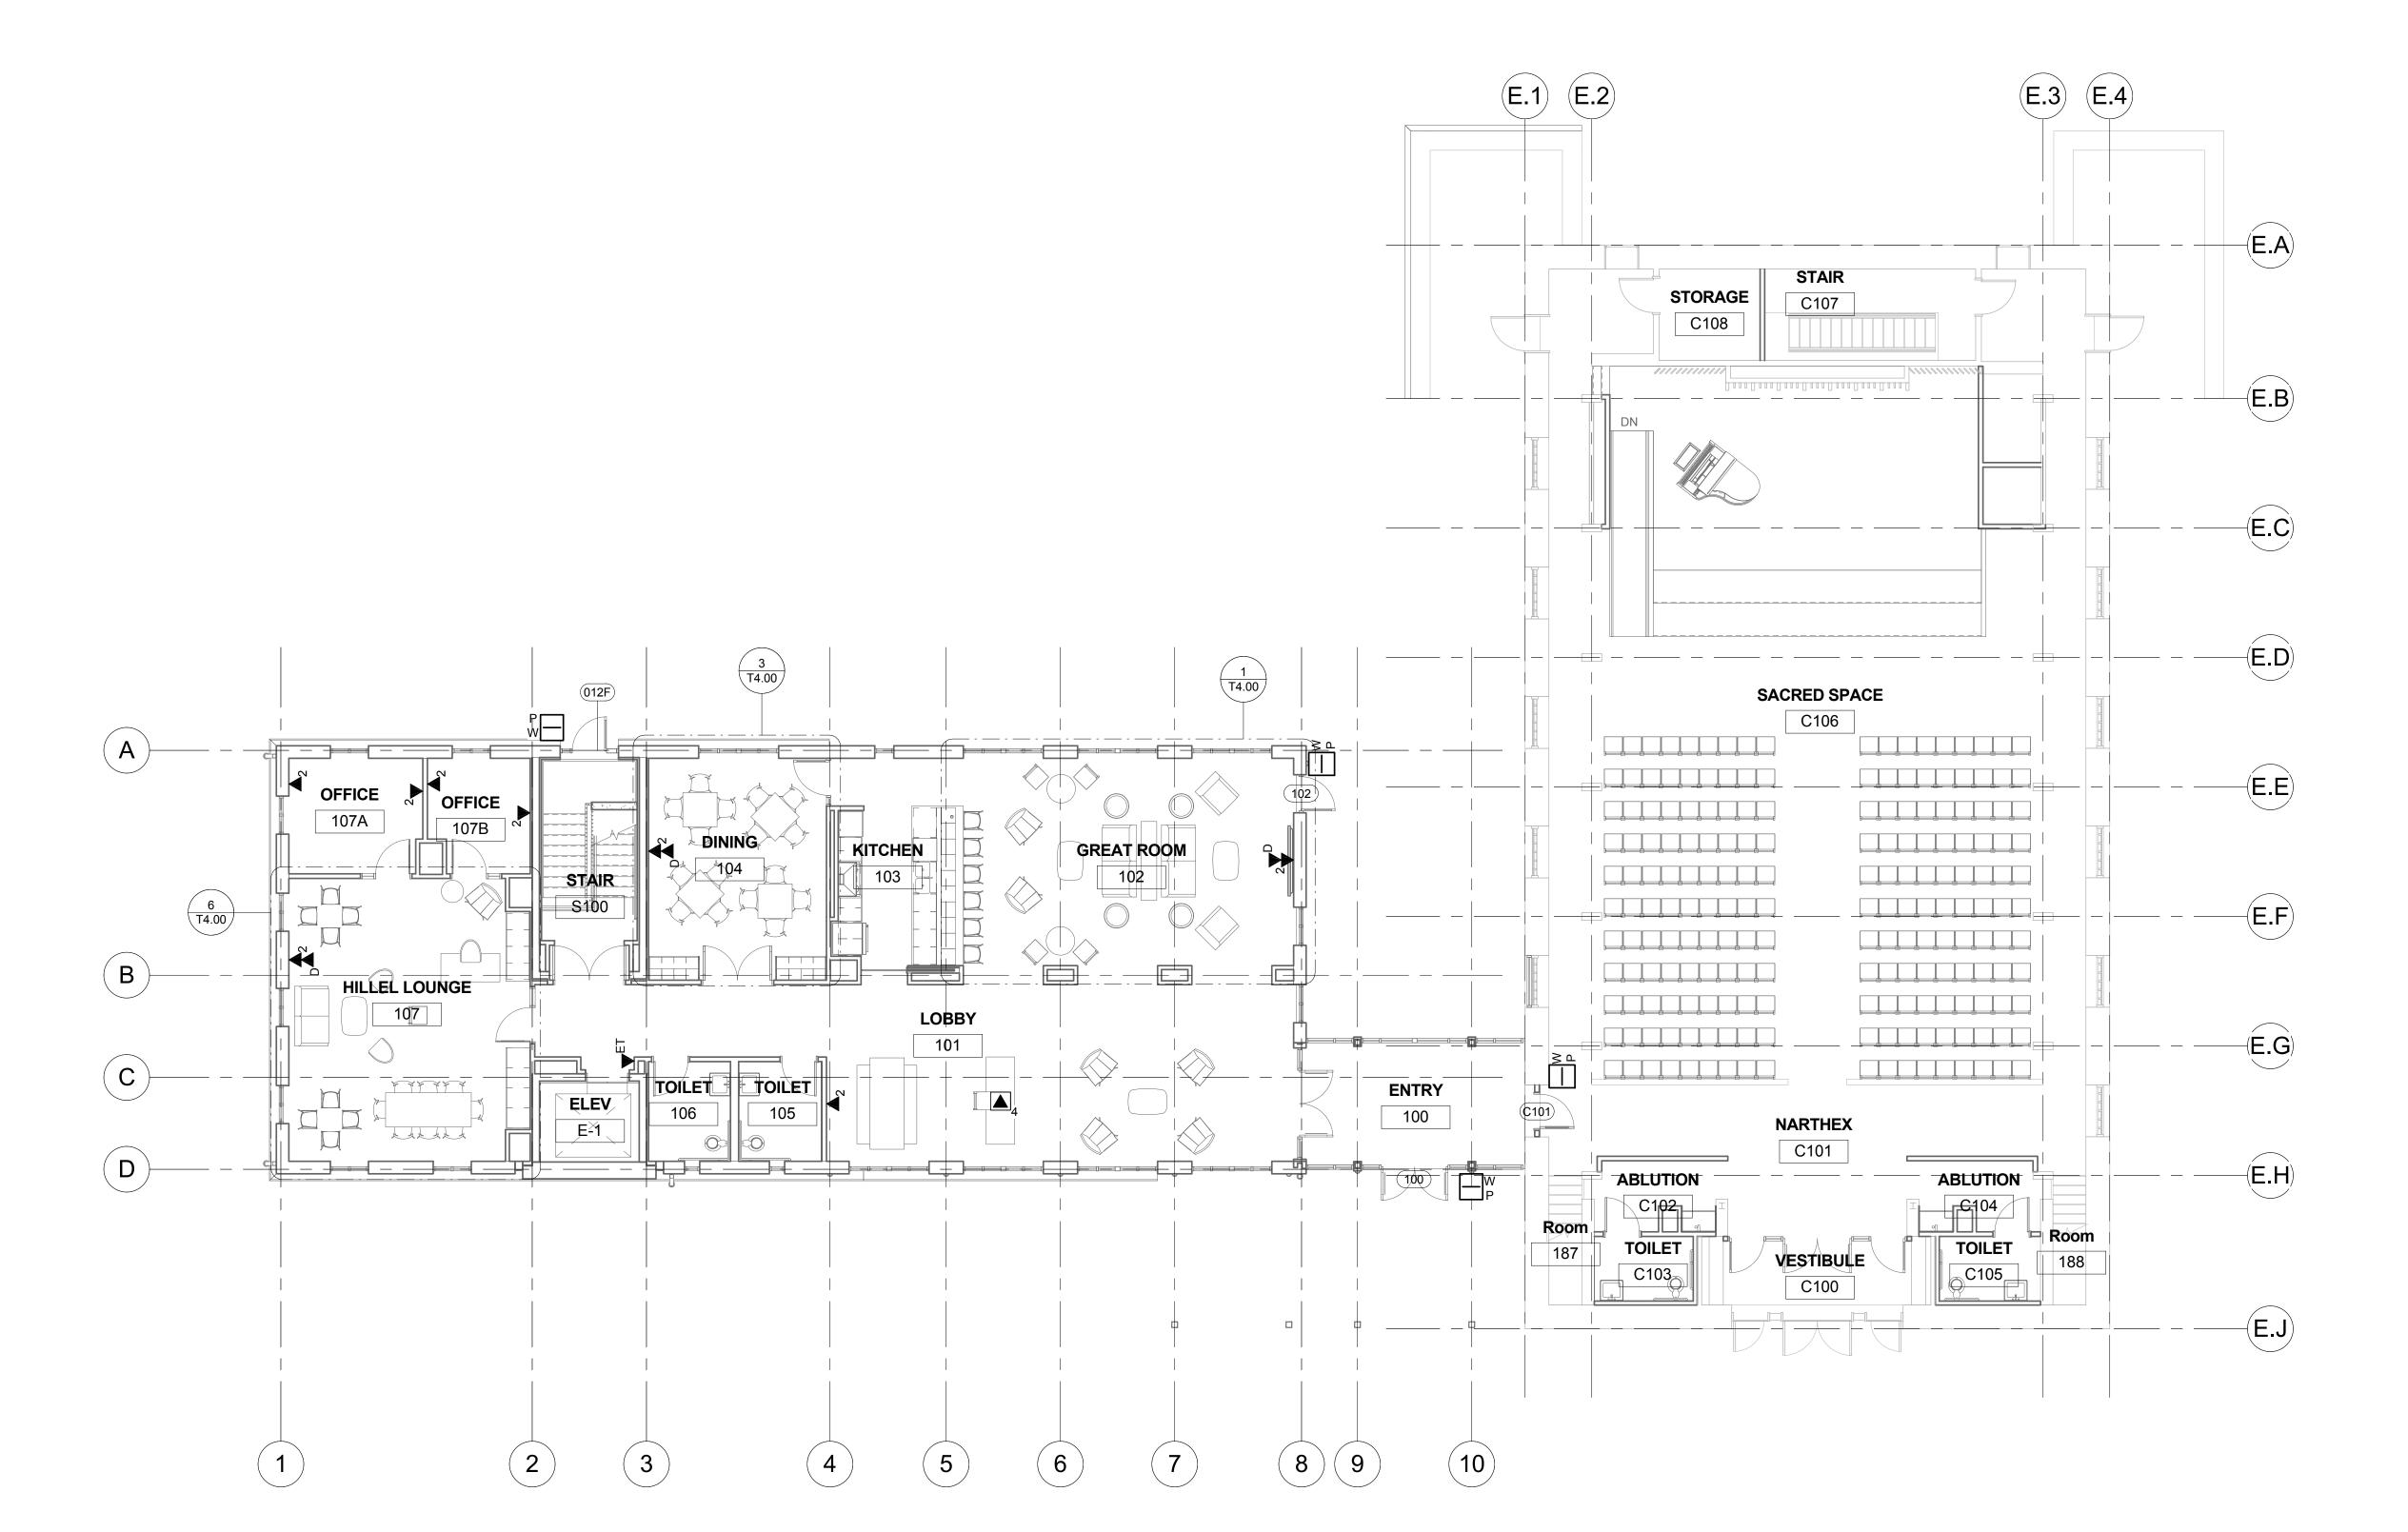

1 00 GROUND LEVEL 1/8" = 1'-0"

GOUCHER
—college—

PROJECT INFORMATION

11

GOLDSMITH INTERFAITH **CENTER**

> GOUCHER COLLEGE 1021 DULANEY VALLEY RD

BALTIMORE MD 21204

PROJECT TEAM

ARCHITECT AYERS SAINT GROSS 1040 HULL STREET, SUITE 100 BALTIMORE, MD 21230 410.347.8500

www.asg-architects.com M/E/P & FIRE PROTECTION ENGINEER MUELLER ASSOCIATES 1306 CONCOURSE DRIVE, SUITE 100

LINTHICUM, MD 21090 410.646.4500 www.muellerassoc.com STRUCTURAL ENGINEER MORABITO CONSULTANTS

952 RIDGEBROOK ROAD, SUITE 1700 SPARKS, MD 21152 410.467.2377 www.morabitoconsultants.com

300 EAST JOPPA ROAD, SUITE 200 BALTIMORE, MD 21286 410.512.4500 www.wbcm.com

CIVIL ENGINEER

LANDSCAPE ARCHITECT AYERS SAINT GROSS 1040 HULL STREET, SUITE 100 BALTIMORE, MD 21230 410.347.8500 www.asg-architects.com

IT / AV / SECURITY SPEXSYS 7257 PARKWAY DRIVE, SUITE 260 HANOVER, MD 21076 410.712.0390

REV. # DESCRIPTION

INTERFAITH CENTER

AYERS SAINT GROSS

ARCHITECTS + PLANNERS

NOT FOR CONSTRUCTION

ISSUE DATE: 1/8" = 1'-0" JOB NO.: DRAWN BY: PROJECT DESIGN PHASE

50% CONSTRUCTION DOCUMENTS

TECHNOLOGY SYSTEMS

DRAWING NAME

FLOOR PLAN - LEVEL 1 DRAWING NUMBER

T2.01


GENERAL NOTES:

1. ALL CABLING ON THIS SHEET SHALL BE TERMINATED IN THE LOWER LEVEL TELECOM ROOM.

3

5

2. SEE T4.00 FOR ADDITIONAL AUDIO VISUAL SYSTEM REQUIREMENTS.

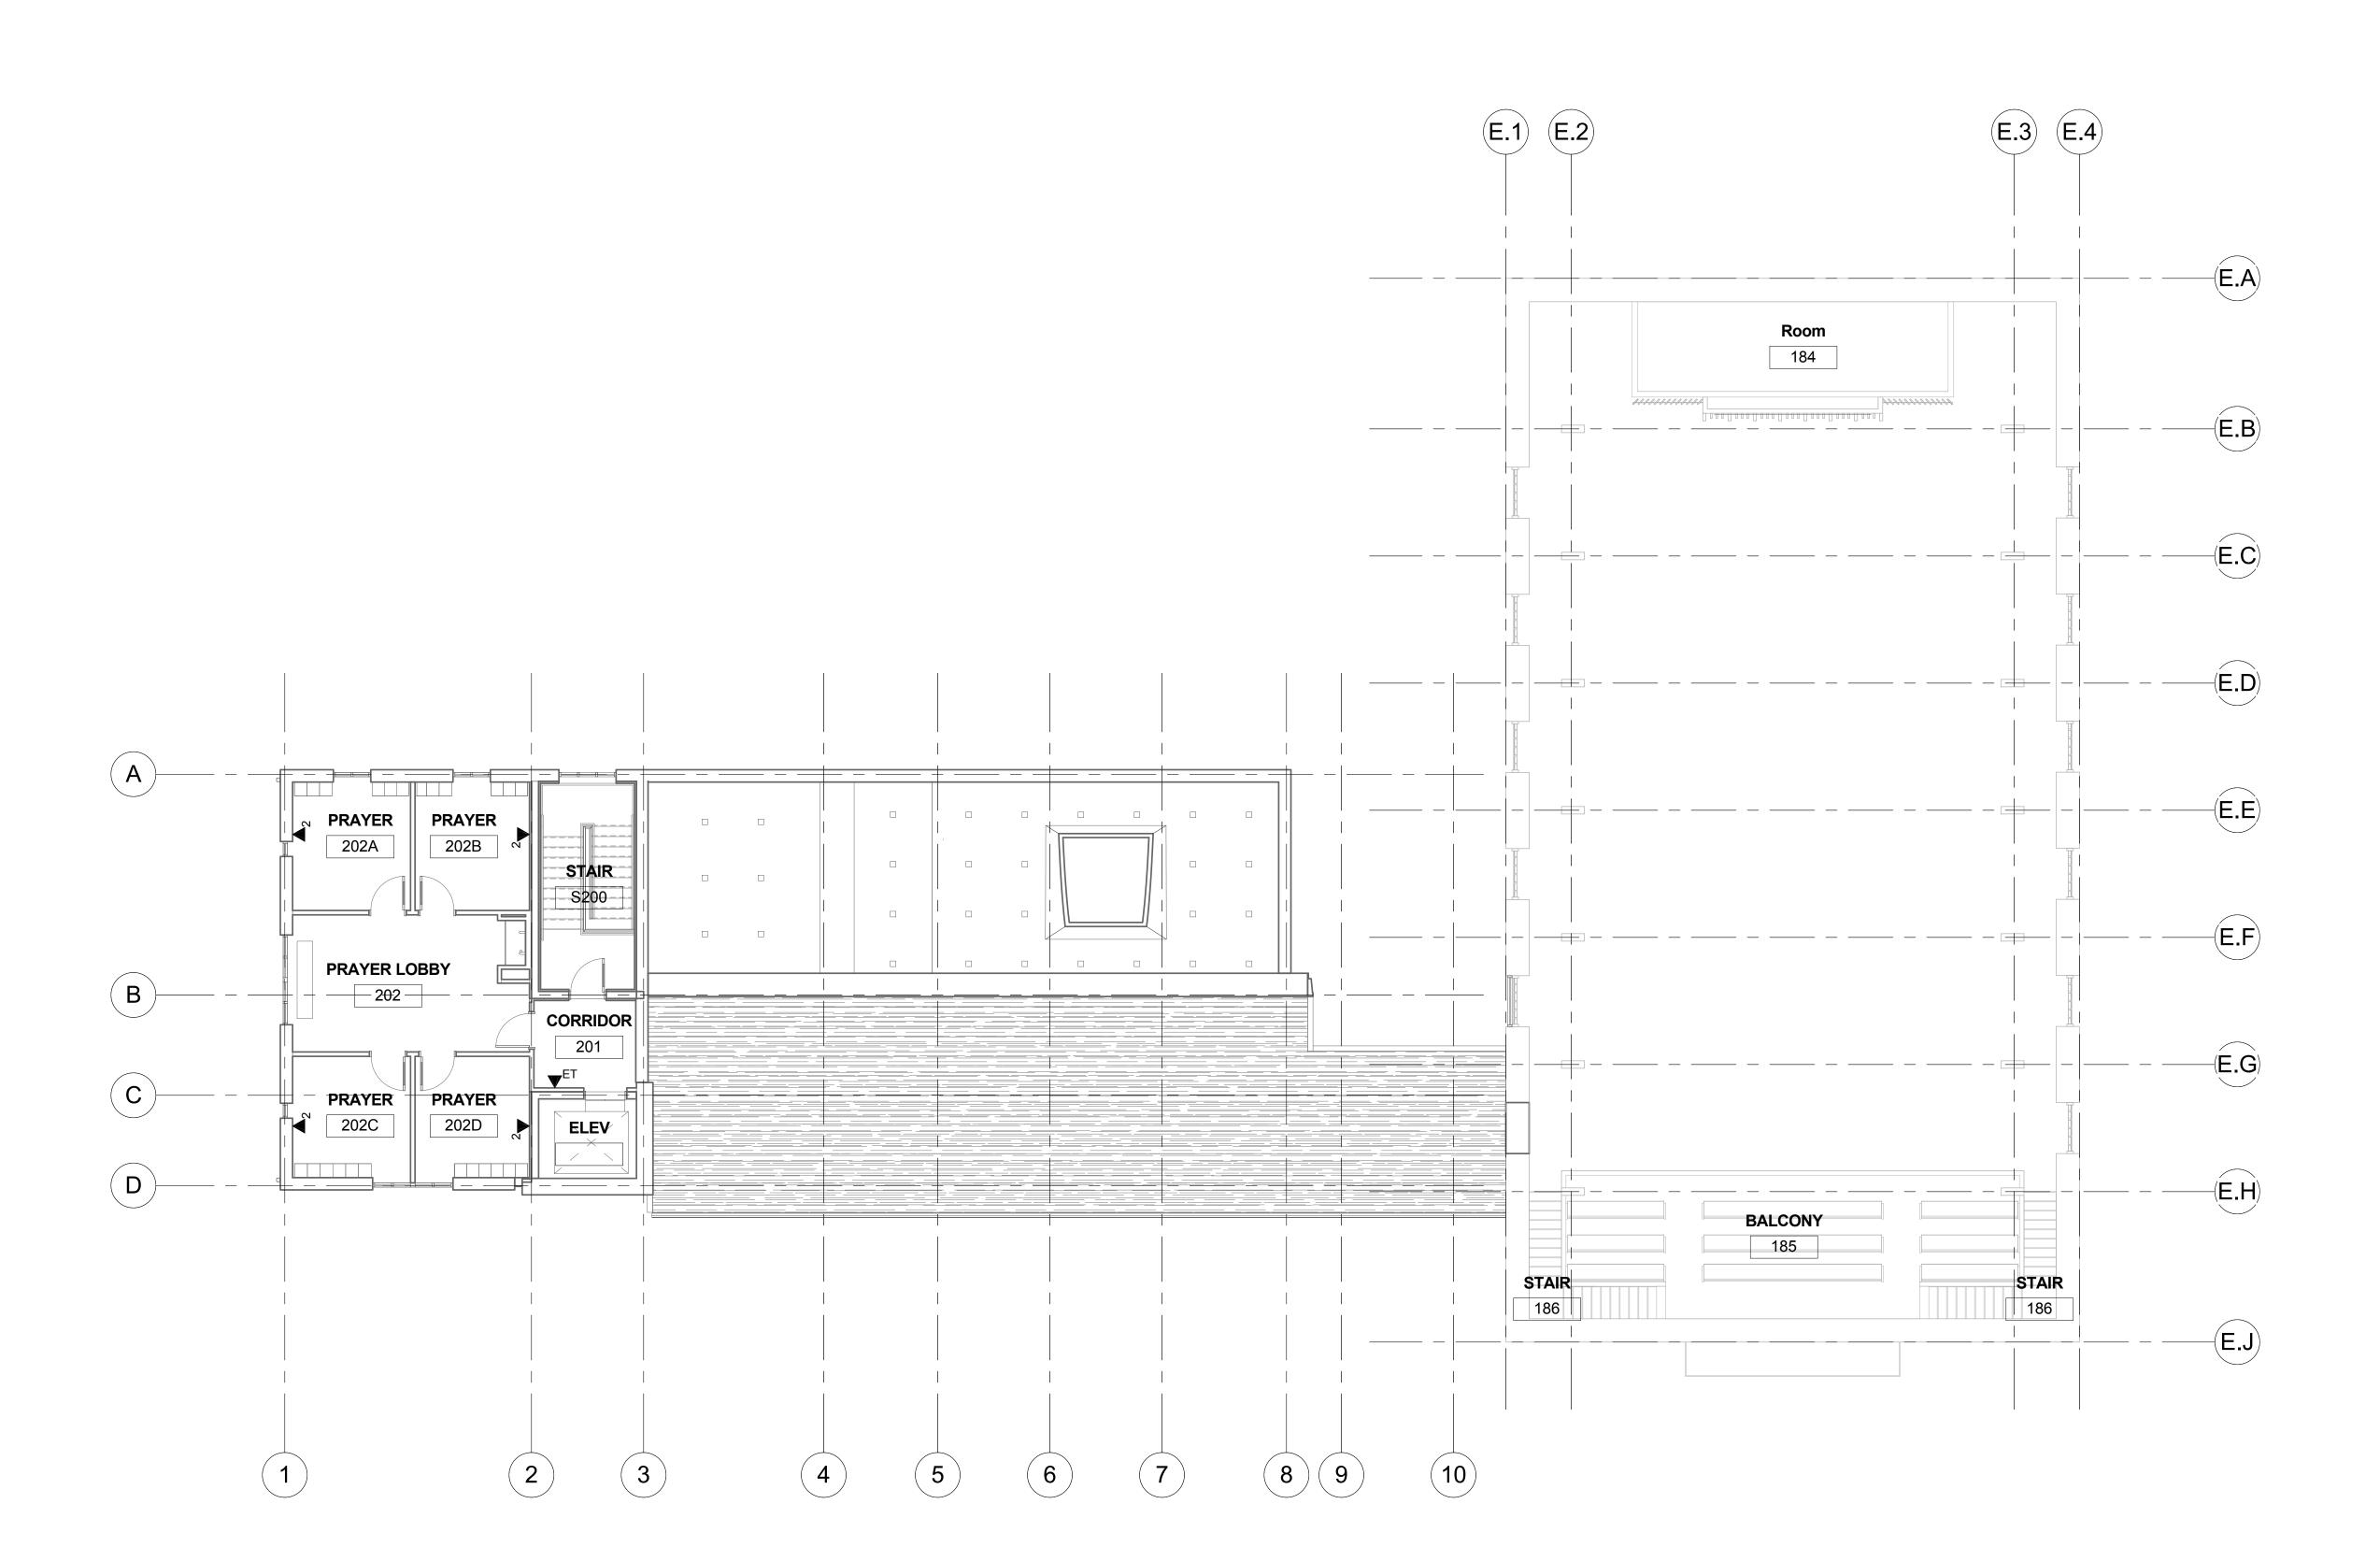

1 02 LEVEL 2 1/8" = 1'-0" GOUCHER
—college—

PROJECT INFORMATION

11

GOLDSMITH INTERFAITH CENTER

> GOUCHER COLLEGE 1021 DULANEY VALLEY RD

BALTIMORE MD 21204

PROJECT TEAM

ARCHITECT
AYERS SAINT GROSS
1040 HULL STREET, SUITE 100
BALTIMORE, MD 21230

BALTIMORE, MD 21230 410.347.8500 www.asg-architects.com

M/E/P & FIRE PROTECTION ENGINEER

MUELLER ASSOCIATES

1306 CONCOURSE DRIVE, SUITE 100
LINTHICUM, MD 21090

www.muellerassoc.com

STRUCTURAL ENGINEER

MORABITO CONSULTANTS

952 RIDGEBROOK ROAD, SUITE 1700

410.646.4500

SPARKS, MD 21152 410.467.2377 www.morabitoconsultants.com


WBCM 300 EAST JOPPA ROAD, SUITE 200 BALTIMORE, MD 21286 410.512.4500 www.wbcm.com


AYERS SAINT GROSS
1040 HULL STREET, SUITE 100
BALTIMORE, MD 21230
410.347.8500
www.asg-architects.com

IT / AV / SECURITY

SPEXSYS
7257 PARKWAY DRIVE, SUITE 260
HANOVER, MD 21076
410.712.0390

REV. # DESCRIPTION DATE

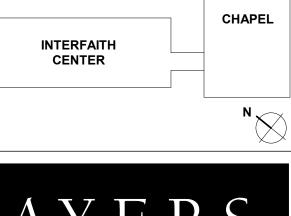

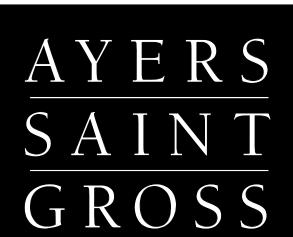

ARCHITECTS + PLANNERS

NOT FOR CONSTRUCTION

 DRAWING INFORMATION

 ISSUE DATE:
 04/28/17

 SCALE:
 1/8" = 1'-0"

 JOB NO.:
 21641.00

 DRAWN BY:
 JVS


 PROJECT DESIGN PHASE

50% CONSTRUCTION DOCUMENTS

DRAWING NAME

TECHNOLOGY SYSTEMS FLOOR PLAN - LEVEL 2

T2.02

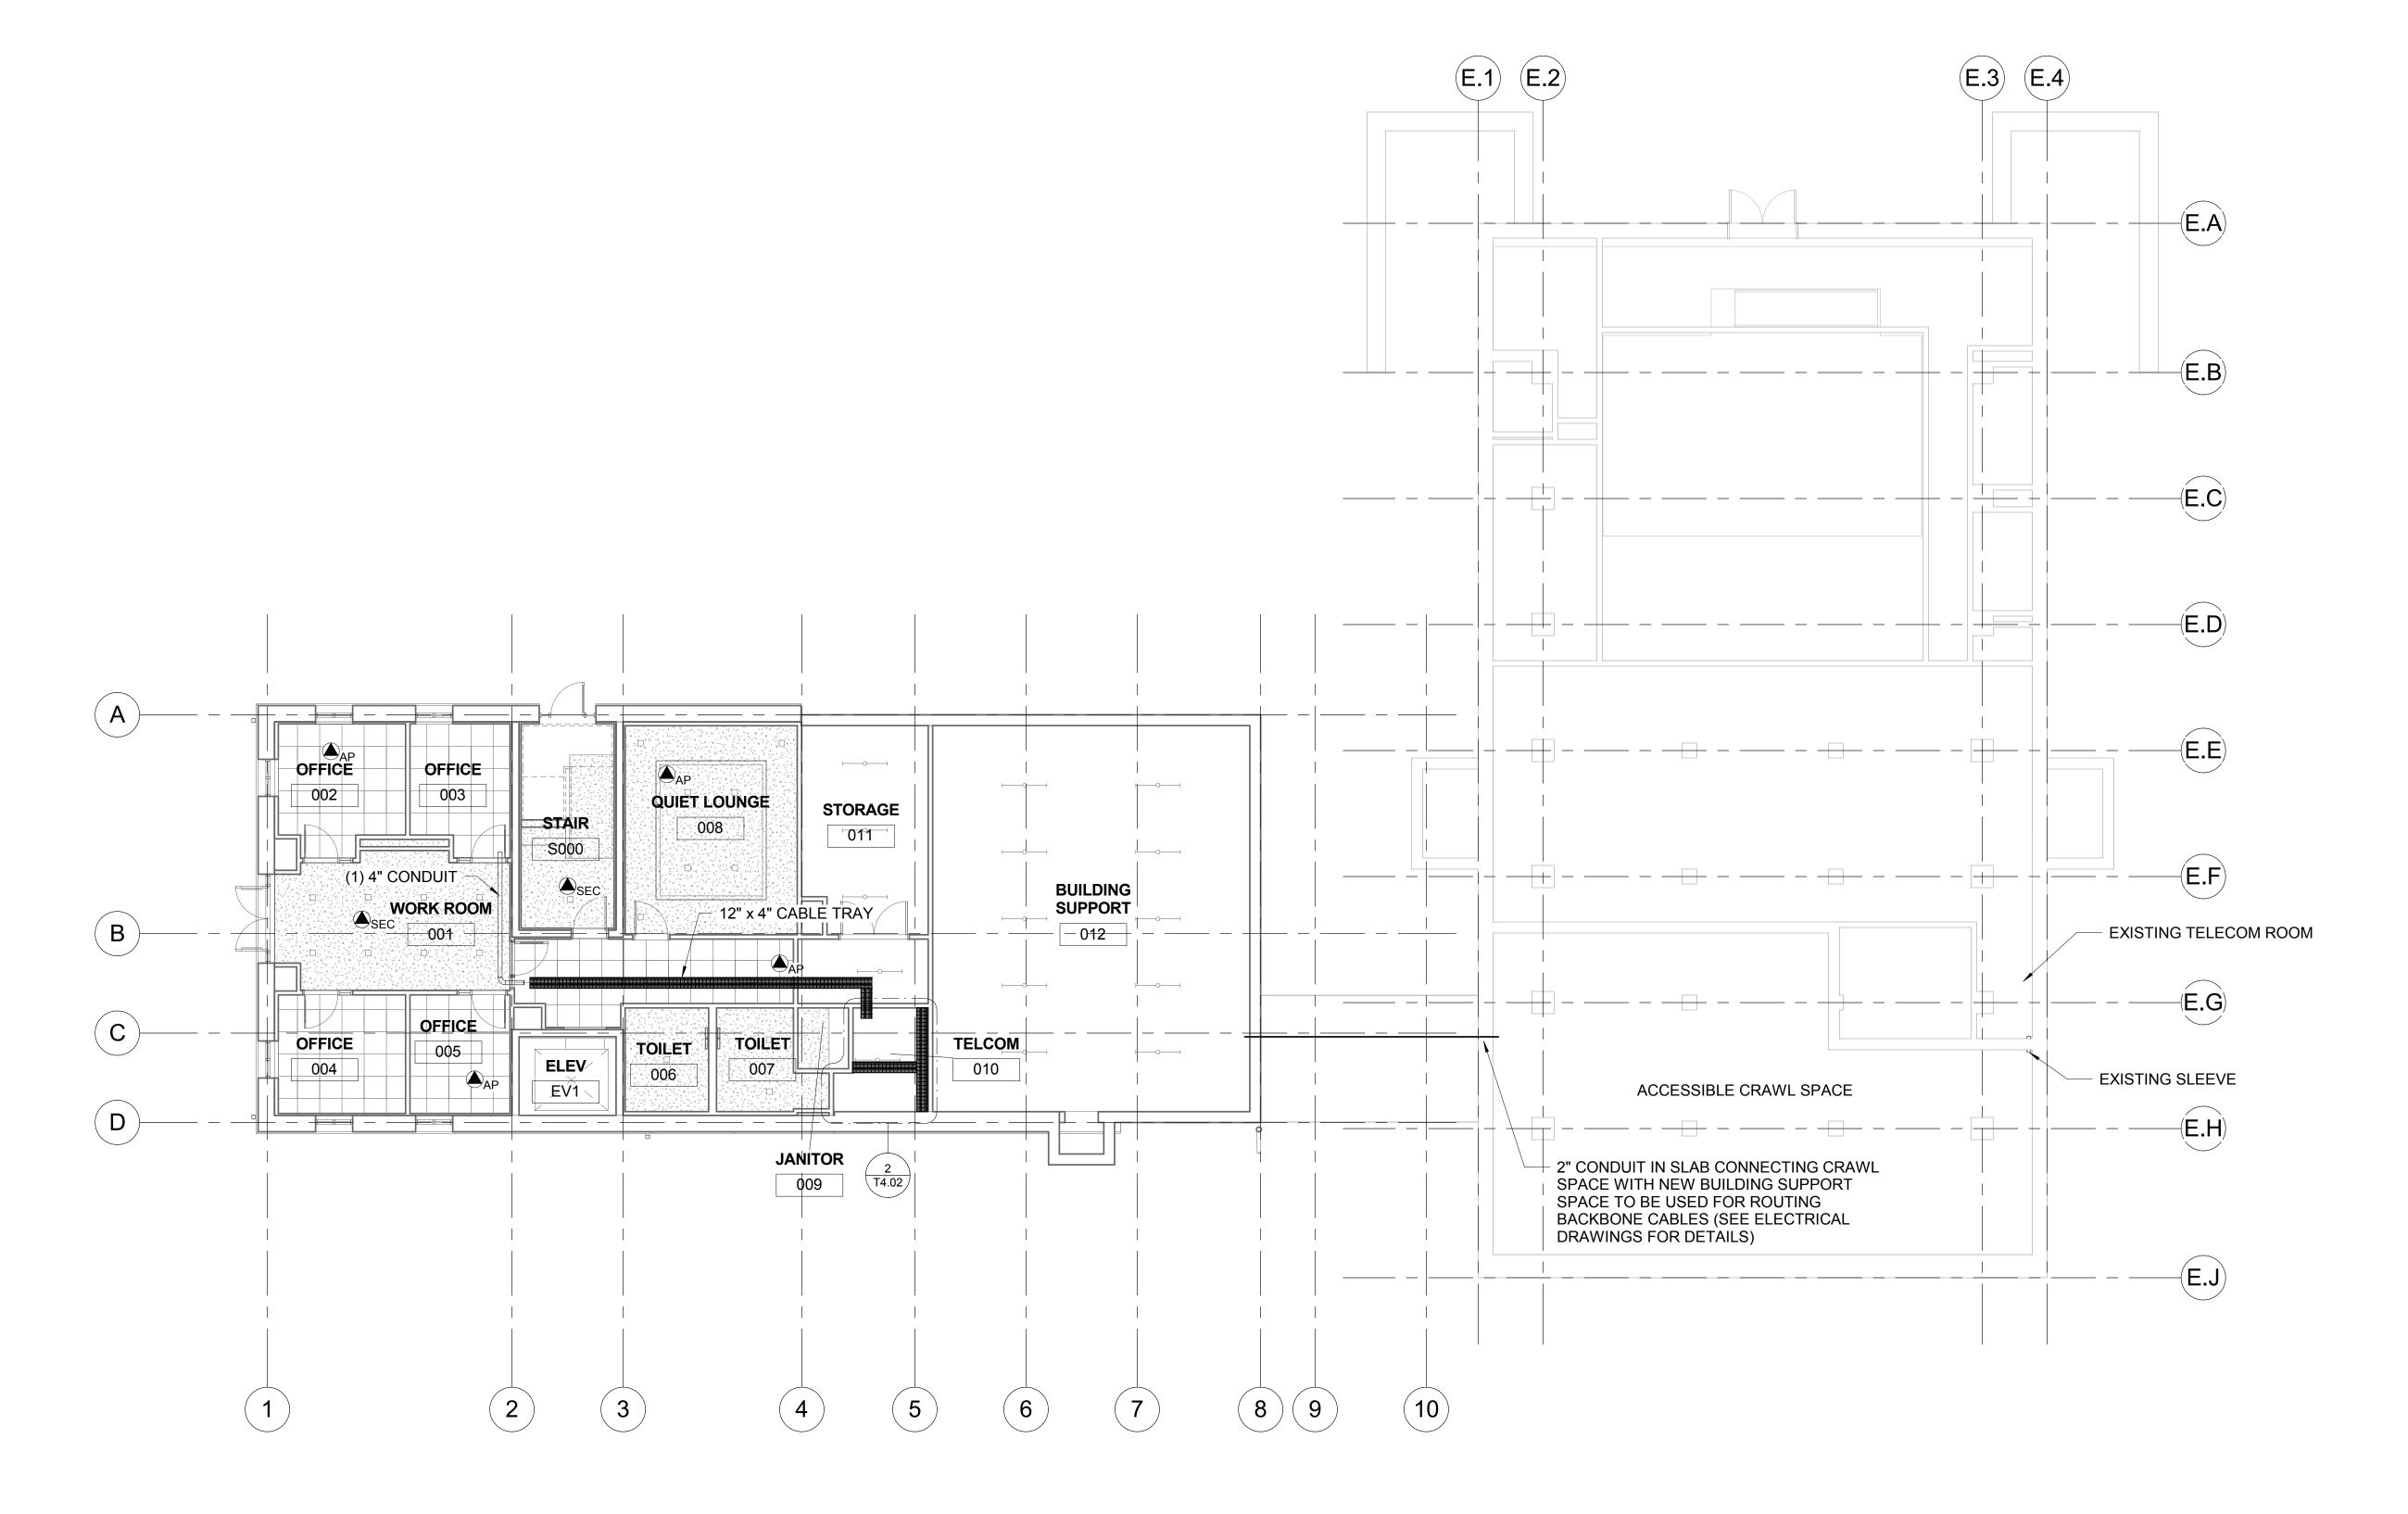

PROJECT INFORMATION

11

GOLDSMITH INTERFAITH **CENTER**

> GOUCHER COLLEGE 1021 DULANEY VALLEY RD BALTIMORE MD 21204

PROJECT TEAM

ARCHITECT AYERS SAINT GROSS 1040 HULL STREET, SUITE 100 BALTIMORE, MD 21230 410.347.8500

www.asg-architects.com M/E/P & FIRE PROTECTION ENGINEER MUELLER ASSOCIATES

410.646.4500 www.muellerassoc.com STRUCTURAL ENGINEER

1306 CONCOURSE DRIVE, SUITE 100 LINTHICUM, MD 21090

MORABITO CONSULTANTS 952 RIDGEBROOK ROAD, SUITE 1700 SPARKS, MD 21152 410.467.2377 www.morabitoconsultants.com

CIVIL ENGINEER 300 EAST JOPPA ROAD, SUITE 200 BALTIMORE, MD 21286 410.512.4500


www.wbcm.com LANDSCAPE ARCHITECT AYERS SAINT GROSS 1040 HULL STREET, SUITE 100 BALTIMORE, MD 21230 410.347.8500 www.asg-architects.com

IT / AV / SECURITY SPEXSYS 7257 PARKWAY DRIVE, SUITE 260 HANOVER, MD 21076 410.712.0390

REVISIONS REV. # DESCRIPTION

> INTERFAITH CENTER

KEY PLAN

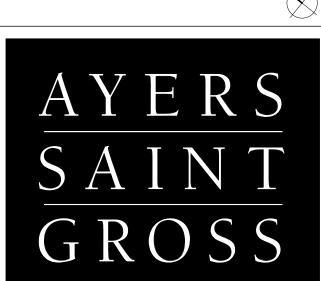

ARCHITECTS + PLANNERS

NOT FOR CONSTRUCTION

DRAWING INFORMATION	
ISSUE DATE:	04/28/17
SCALE:	1/8" = 1'-0"
JOB NO.:	21641.00
DRAWN BY:	JVS
PROJECT DESIGN PHASE	·

50% CONSTRUCTION DOCUMENTS

DRAWING NAME TECHNOLOGY SYSTEMS

REFLECTED CEILING PLAN -LOWER LEVEL

DRAWING NUMBER

T3.00

© COPYRIGHT AYERS SAINT GROSS, 2016

1) -03 LOWER LEVEL 1/8" = 1'-0"


GENERAL NOTES:

1. ALL CABLING ON THIS SHEET SHALL BE TERMINATED IN THE LOWER LEVEL TELECOM ROOM.

3

5

PRIOR TO INSTALLING ANY CABLES OR ASSOCIATED PATHWAYS FOR WIRELESS ACCESS POINTS, CONTRACTOR SHALL REQUEST A HEAT MAP SURVEY FROM SU DOIT TO CONFIRM EXACT LOCATIONS OF WIRELESS ACCESS POINTS.

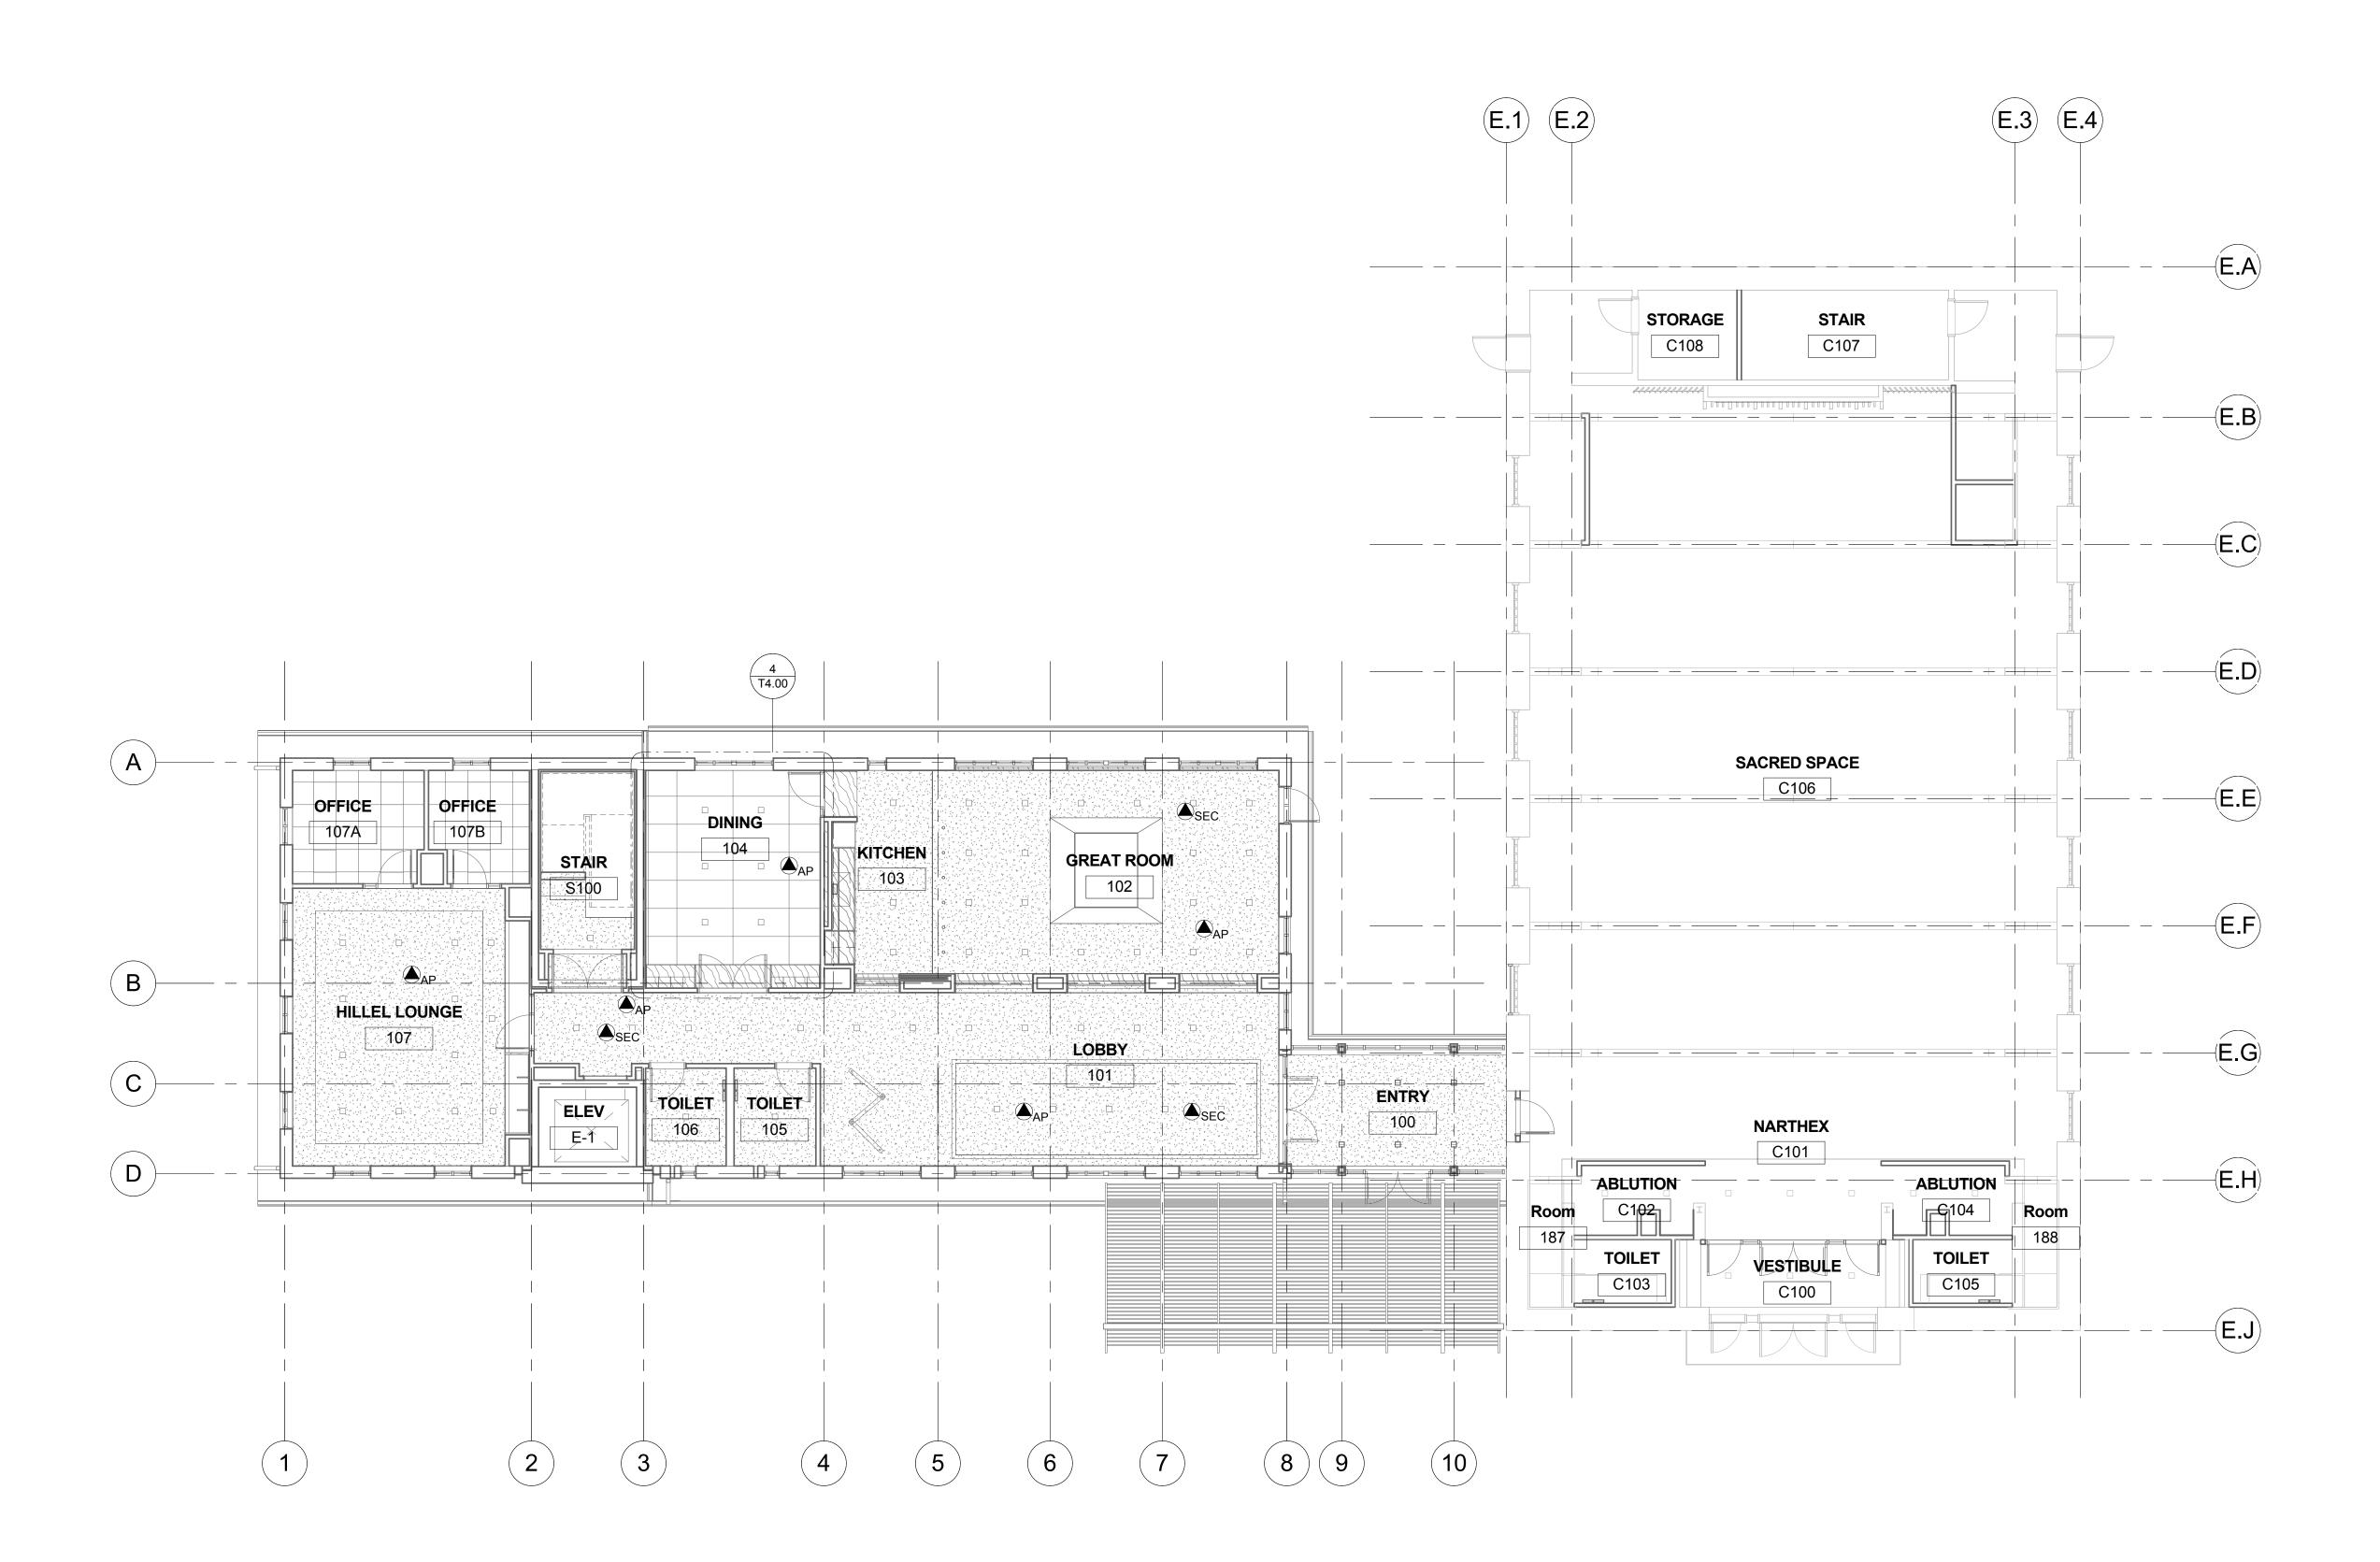

1) 00 GROUND LEVEL 1/8" = 1'-0"

PROJECT INFORMATION

11

GOLDSMITH INTERFAITH **CENTER**

> GOUCHER COLLEGE 1021 DULANEY VALLEY RD

BALTIMORE MD 21204

PROJECT TEAM

ARCHITECT AYERS SAINT GROSS 1040 HULL STREET, SUITE 100 BALTIMORE, MD 21230 410.347.8500

www.asg-architects.com M/E/P & FIRE PROTECTION ENGINEER MUELLER ASSOCIATES

1306 CONCOURSE DRIVE, SUITE 100 LINTHICUM, MD 21090 410.646.4500 www.muellerassoc.com STRUCTURAL ENGINEER


MORABITO CONSULTANTS 952 RIDGEBROOK ROAD, SUITE 1700 SPARKS, MD 21152 410.467.2377 www.morabitoconsultants.com

CIVIL ENGINEER 300 EAST JOPPA ROAD, SUITE 200 BALTIMORE, MD 21286 410.512.4500 www.wbcm.com

LANDSCAPE ARCHITECT AYERS SAINT GROSS 1040 HULL STREET, SUITE 100 BALTIMORE, MD 21230 410.347.8500 www.asg-architects.com

IT / AV / SECURITY SPEXSYS 7257 PARKWAY DRIVE, SUITE 260 HANOVER, MD 21076 410.712.0390

REV. # DESCRIPTION

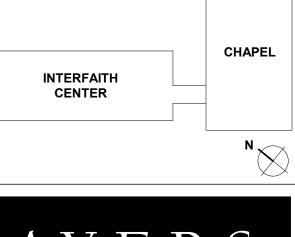

GROSS

ARCHITECTS + PLANNERS

NOT FOR CONSTRUCTION

ISSUE DATE: 1/8" = 1'-0" JOB NO.: DRAWN BY: PROJECT DESIGN PHASE

50% CONSTRUCTION

DOCUMENTS DRAWING NAME

TECHNOLOGY SYSTEMS REFLECTED CEILING PLAN -LEVEL 1

T3.01

DRAWING NUMBER


GENERAL NOTES:

1. ALL CABLING ON THIS SHEET SHALL BE TERMINATED IN THE LOWER LEVEL TELECOM ROOM.

3

5

PRIOR TO INSTALLING ANY CABLES OR ASSOCIATED PATHWAYS FOR WIRELESS ACCESS POINTS, CONTRACTOR SHALL REQUEST A HEAT MAP SURVEY FROM SU DOIT TO CONFIRM EXACT LOCATIONS OF WIRELESS ACCESS POINTS.

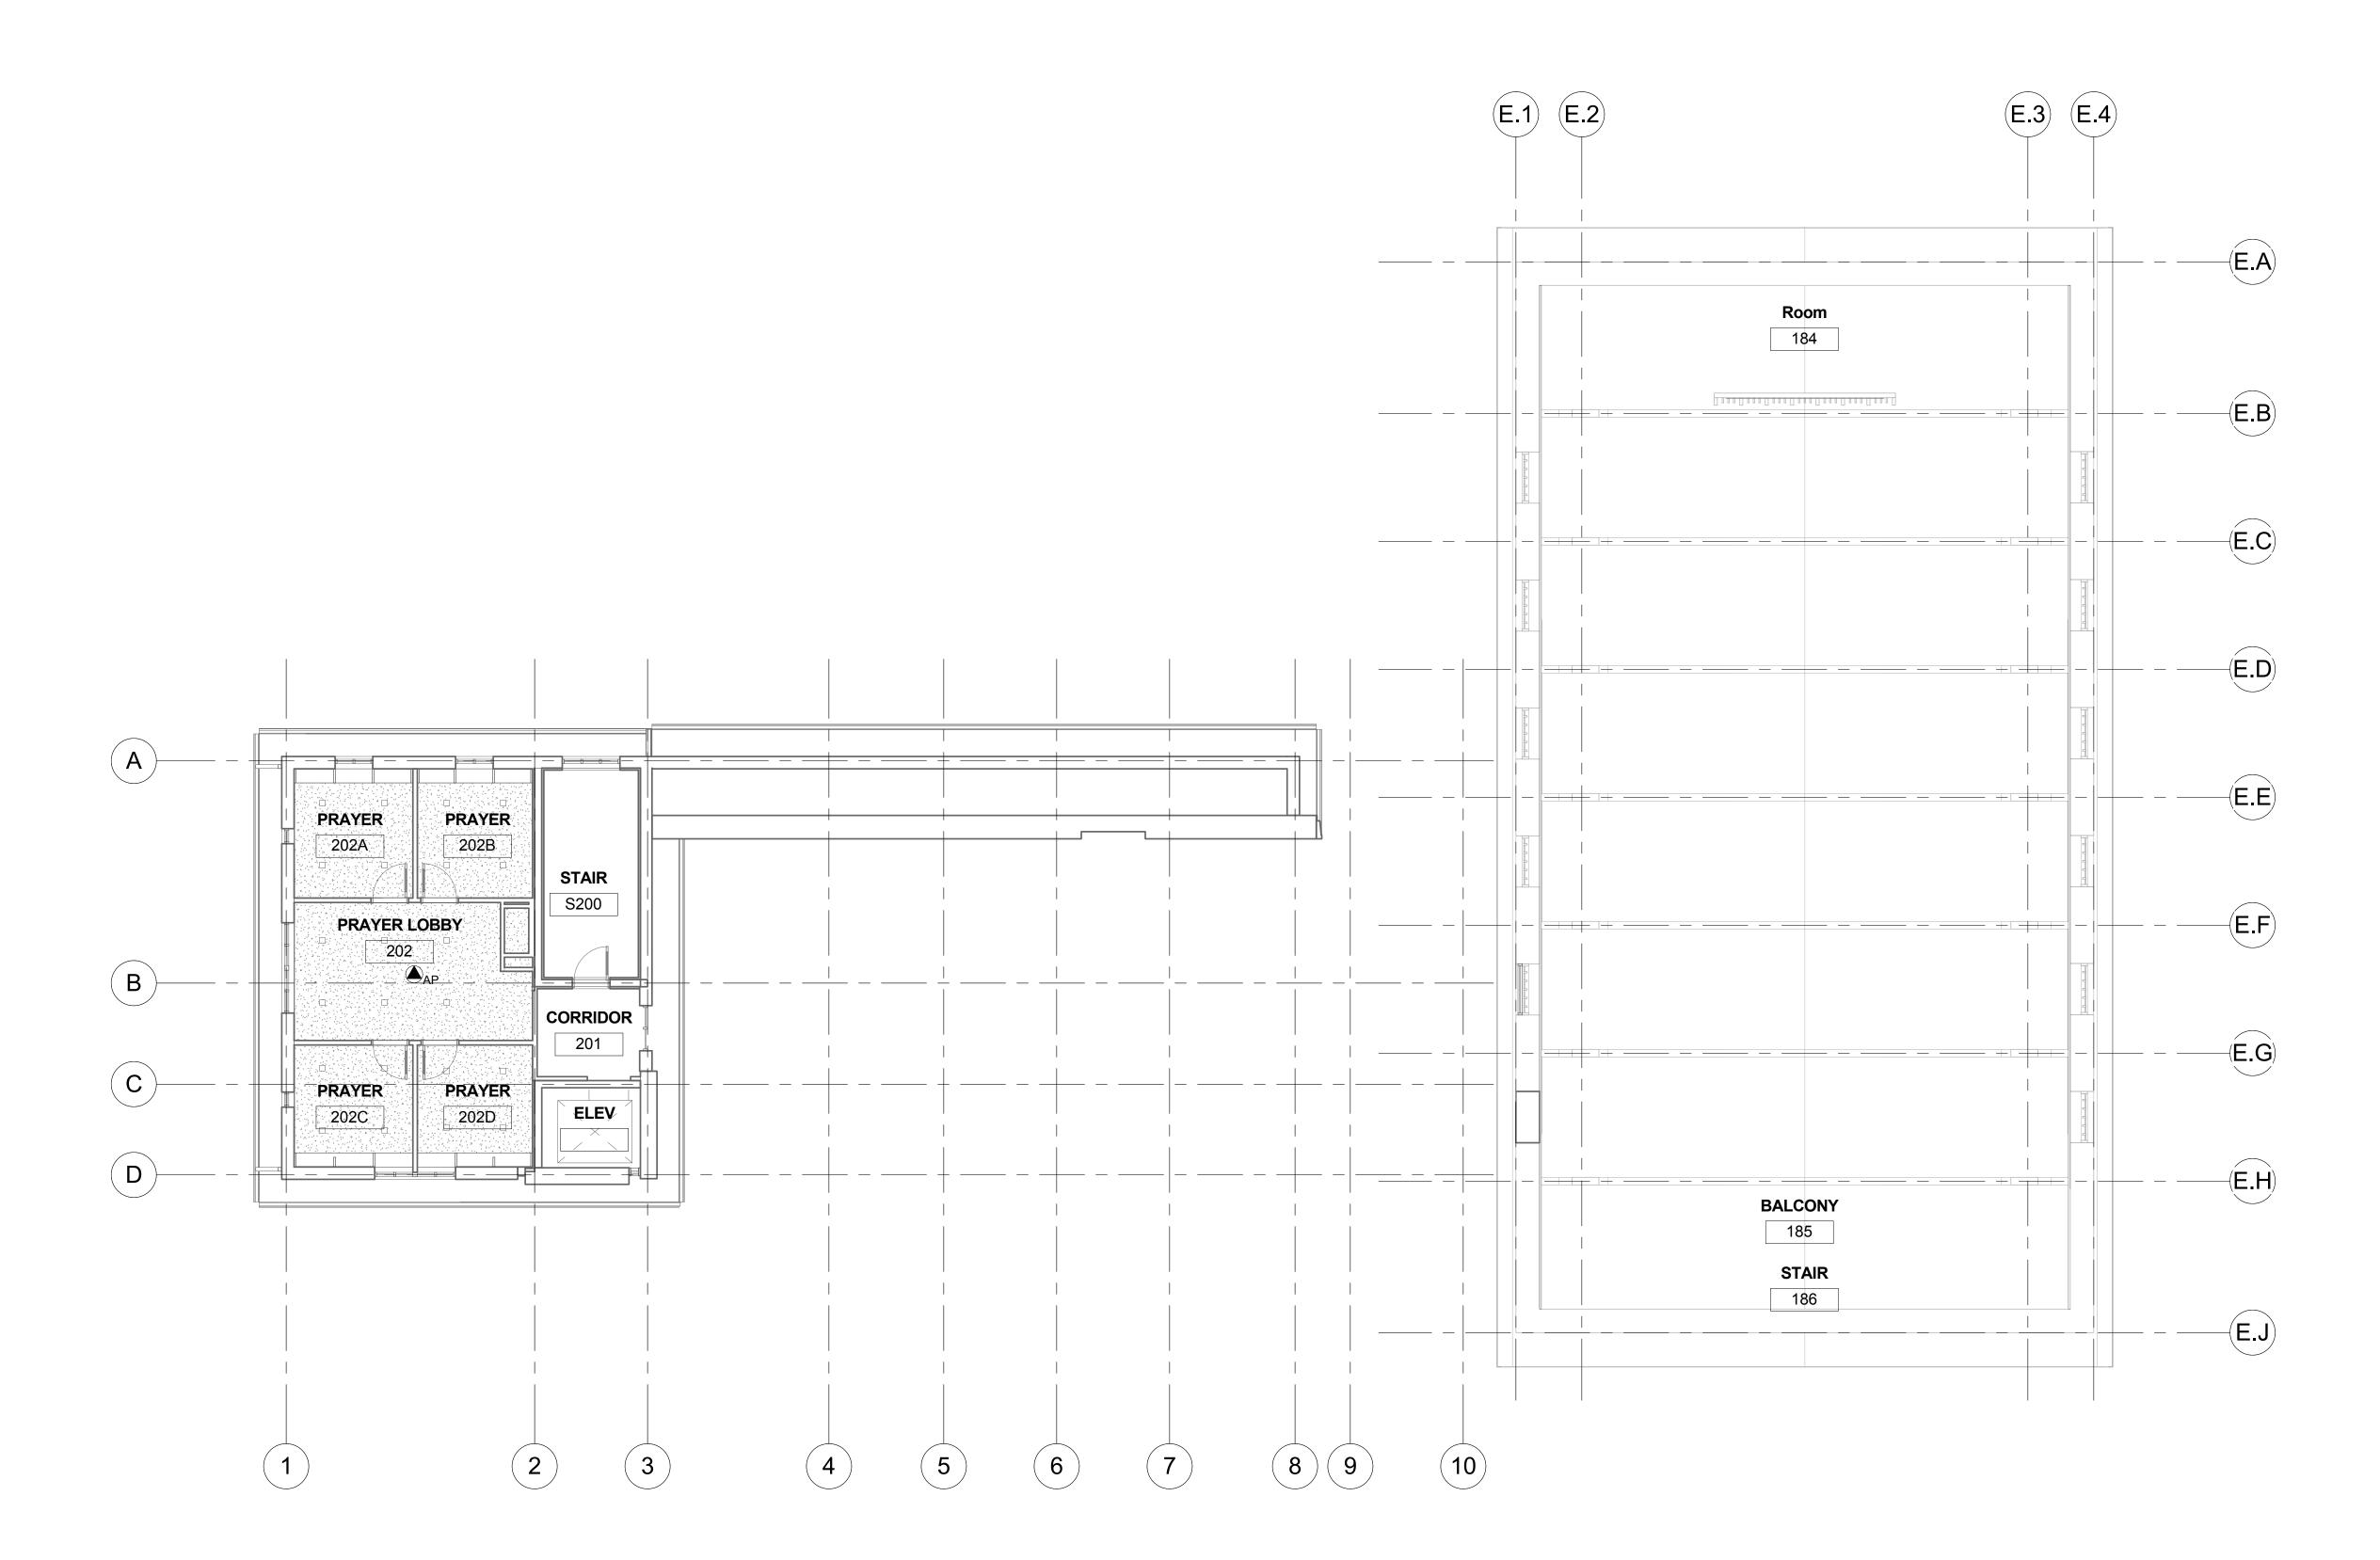

1 02 LEVEL 2 1/8" = 1'-0"

PROJECT INFORMATION

11

GOLDSMITH INTERFAITH **CENTER**

> GOUCHER COLLEGE 1021 DULANEY VALLEY RD

BALTIMORE MD 21204

PROJECT TEAM

ARCHITECT AYERS SAINT GROSS 1040 HULL STREET, SUITE 100 BALTIMORE, MD 21230 410.347.8500

www.asg-architects.com M/E/P & FIRE PROTECTION ENGINEER

MUELLER ASSOCIATES 1306 CONCOURSE DRIVE, SUITE 100 LINTHICUM, MD 21090 410.646.4500 www.muellerassoc.com

STRUCTURAL ENGINEER MORABITO CONSULTANTS 952 RIDGEBROOK ROAD, SUITE 1700 SPARKS, MD 21152 410.467.2377


www.morabitoconsultants.com

CIVIL ENGINEER 300 EAST JOPPA ROAD, SUITE 200 BALTIMORE, MD 21286 410.512.4500

www.wbcm.com LANDSCAPE ARCHITECT AYERS SAINT GROSS 1040 HULL STREET, SUITE 100 BALTIMORE, MD 21230 410.347.8500 www.asg-architects.com

IT / AV / SECURITY SPEXSYS 7257 PARKWAY DRIVE, SUITE 260 HANOVER, MD 21076 410.712.0390

REV. # DESCRIPTION

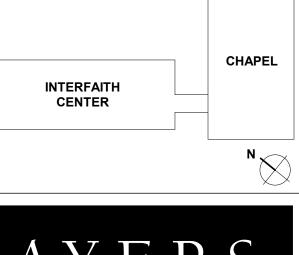

GROSS

ARCHITECTS + PLANNERS

NOT FOR CONSTRUCTION

ISSUE DATE: 1/8" = 1'-0" JOB NO.: DRAWN BY: PROJECT DESIGN PHASE

50% CONSTRUCTION

DOCUMENTS DRAWING NAME

TECHNOLOGY SYSTEMS REFLECTED CEILING PLAN -LEVEL 2

> DRAWING NUMBER T3.02

PROJECT INFORMATION

GOUCHER

GOLDSMITH INTERFAITH **CENTER**

> GOUCHER COLLEGE 1021 DULANEY VALLEY RD BALTIMORE MD 21204

> > ARCHITECT AYERS SAINT GROSS

PROJECT TEAM

1040 HULL STREET, SUITE 100 BALTIMORE, MD 21230 410.347.8500 www.asg-architects.com

M/E/P & FIRE PROTECTION ENGINEER MUELLER ASSOCIATES 1306 CONCOURSE DRIVE, SUITE 100 LINTHICUM, MD 21090 410.646.4500

www.muellerassoc.com

STRUCTURAL ENGINEER MORABITO CONSULTANTS 952 RIDGEBROOK ROAD, SUITE 1700 SPARKS, MD 21152

410.467.2377 www.morabitoconsultants.com **CIVIL ENGINEER**

300 EAST JOPPA ROAD, SUITE 200 BALTIMORE, MD 21286 410.512.4500 www.wbcm.com

LANDSCAPE ARCHITECT AYERS SAINT GROSS 1040 HULL STREET, SUITE 100 BALTIMORE, MD 21230 410.347.8500 www.asg-architects.com

IT / AV / SECURITY SPEXSYS 7257 PARKWAY DRIVE, SUITE 260 HANOVER, MD 21076 410.712.0390

DESCRIPTION

INTERFAITH CENTER

AYERS SAINT GROSS

ARCHITECTS + PLANNERS


NOT FOR CONSTRUCTION

DRAWN BY: PROJECT DESIGN PHASE **50% CONSTRUCTION**

DOCUMENTS

DRAWING NAME **TECHNOLOGY SYSTEMS - AV DETAILS**

> DRAWING NUMBER T4.00

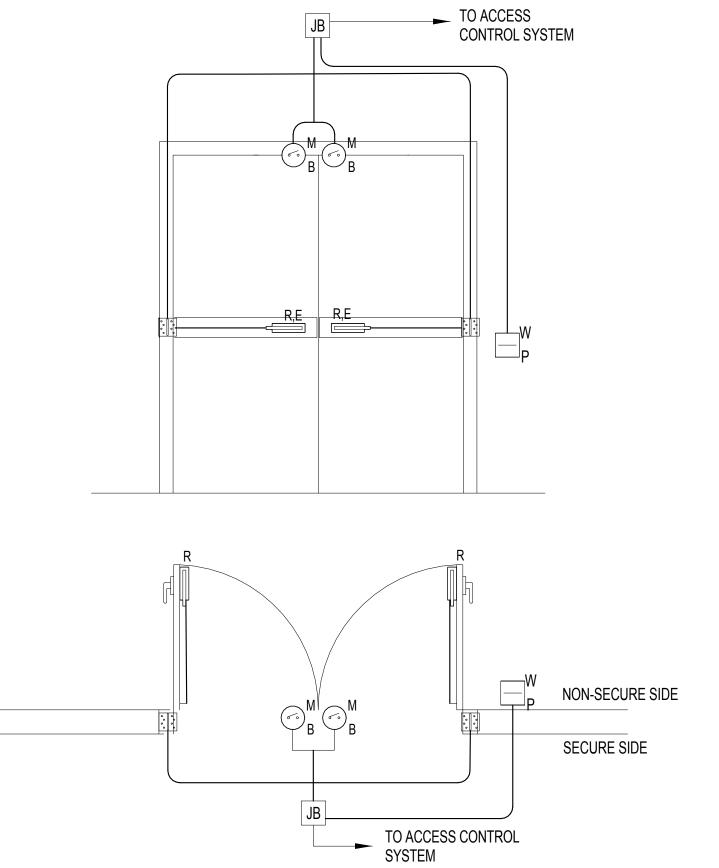

3 DOOR TYPE B NTS

SECURITY DOOR SCHEDULE


DOOR NO. DOOR TYPE

ELEVATOR


102

EV1

3

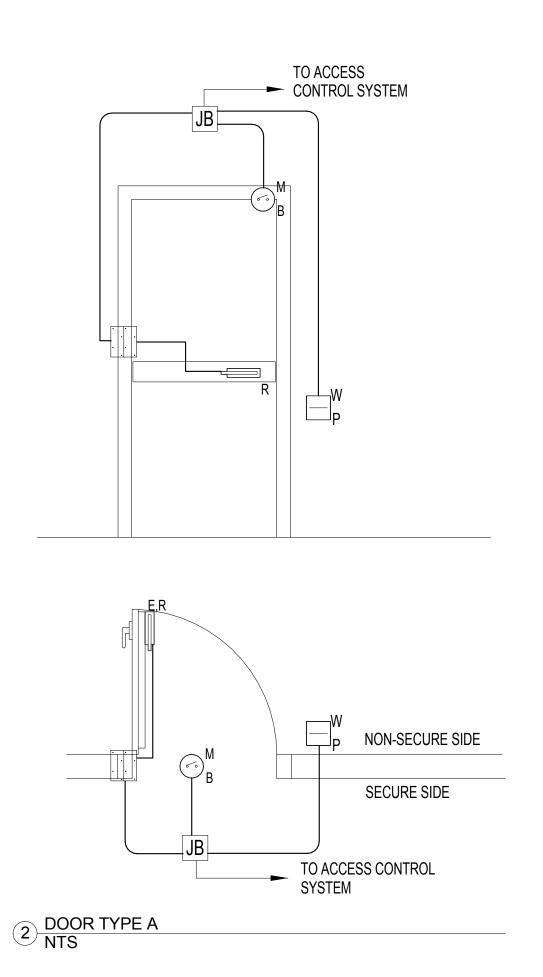

5

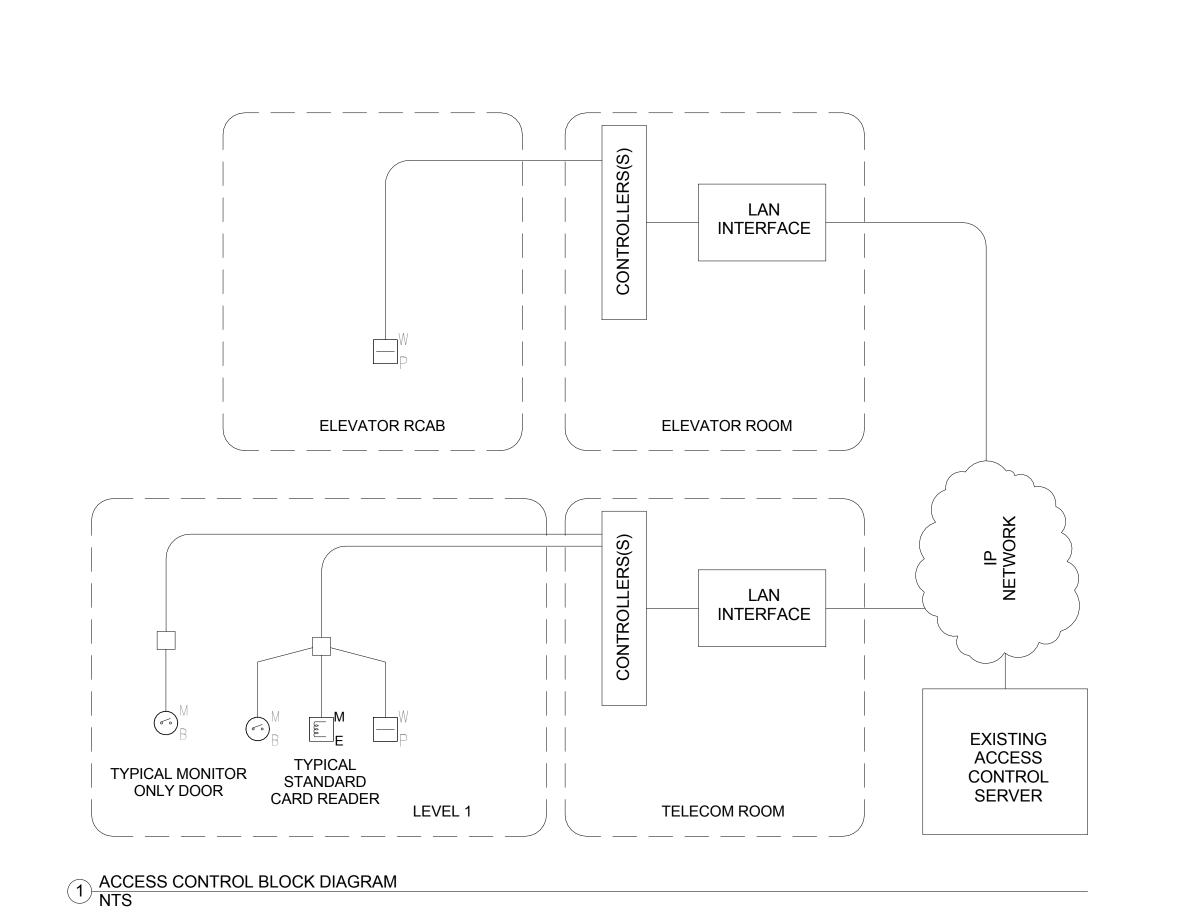

9

PROJECT INFORMATION

11

GOLDSMITH INTERFAITH **CENTER**

GOUCHER COLLEGE 1021 DULANEY VALLEY RD

BALTIMORE MD 21204

PROJECT TEAM **ARCHITECT**

AYERS SAINT GROSS 1040 HULL STREET, SUITE 100 BALTIMORE, MD 21230 410.347.8500 www.asg-architects.com

M/E/P & FIRE PROTECTION ENGINEER MUELLER ASSOCIATES

1306 CONCOURSE DRIVE, SUITE 100 LINTHICUM, MD 21090 410.646.4500 www.muellerassoc.com

STRUCTURAL ENGINEER

MORABITO CONSULTANTS 952 RIDGEBROOK ROAD, SUITE 1700 SPARKS, MD 21152


410.467.2377 www.morabitoconsultants.com **CIVIL ENGINEER**

300 EAST JOPPA ROAD, SUITE 200 BALTIMORE, MD 21286 410.512.4500 www.wbcm.com

LANDSCAPE ARCHITECT AYERS SAINT GROSS 1040 HULL STREET, SUITE 100 BALTIMORE, MD 21230 410.347.8500 www.asg-architects.com

IT / AV / SECURITY SPEXSYS 7257 PARKWAY DRIVE, SUITE 260 HANOVER, MD 21076 410.712.0390

REVISIONS REV. # DESCRIPTION **KEY PLAN**

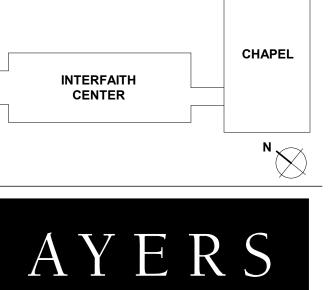

GROSS

ARCHITECTS + PLANNERS


NOT FOR CONSTRUCTION

ISSUE DATE: 12" = 1'-0" JOB NO.: DRAWN BY: PROJECT DESIGN PHASE **50% CONSTRUCTION**

DOCUMENTS DRAWING NAME

TECHNOLOGY SYSTEMS -SECURITY DETAILS


> DRAWING NUMBER T4.01

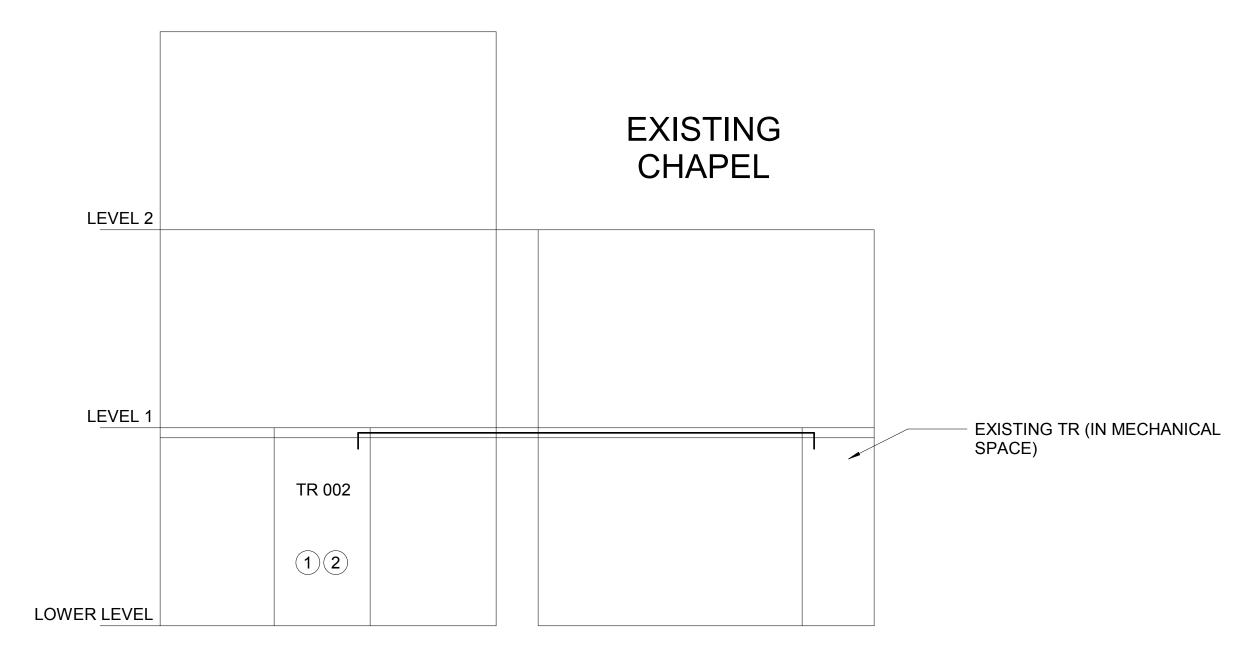



5


- INSTALL ONE (1) 6-STRAND OS2 SINGLEMODE OPTICAL FIBER CABLE FROM EXISTING TELECOM ROOM IN THE BASEMENT OF THE EXISTING CHAPEL. IN THE EXISTING CHAPEL, TERMINATE WITH LC CONNECTORS INSTALLED IN AN EXISTING WALL-MOUNTED FIBER PANEL. IN THE NEW TELECOM ROOM (002), TERMINATE WITH LC CONNECTORS INSTALLED IN A NEW RACK-MOUNTED FIBER PANEL.
- INSTALL ONE (1) 25-PAIR OSP COPPER CABLE FROM EXISTING TELECOM ROOM IN THE BASEMENT OF THE EXISTING CHAPEL. ON EACH END, TERMINATE ON A WALL-MOUNTED BUILDING ENTRANCE TERMINALS WITH SURGE PROTECTORS.


6 RISER DIAGRAM NTS

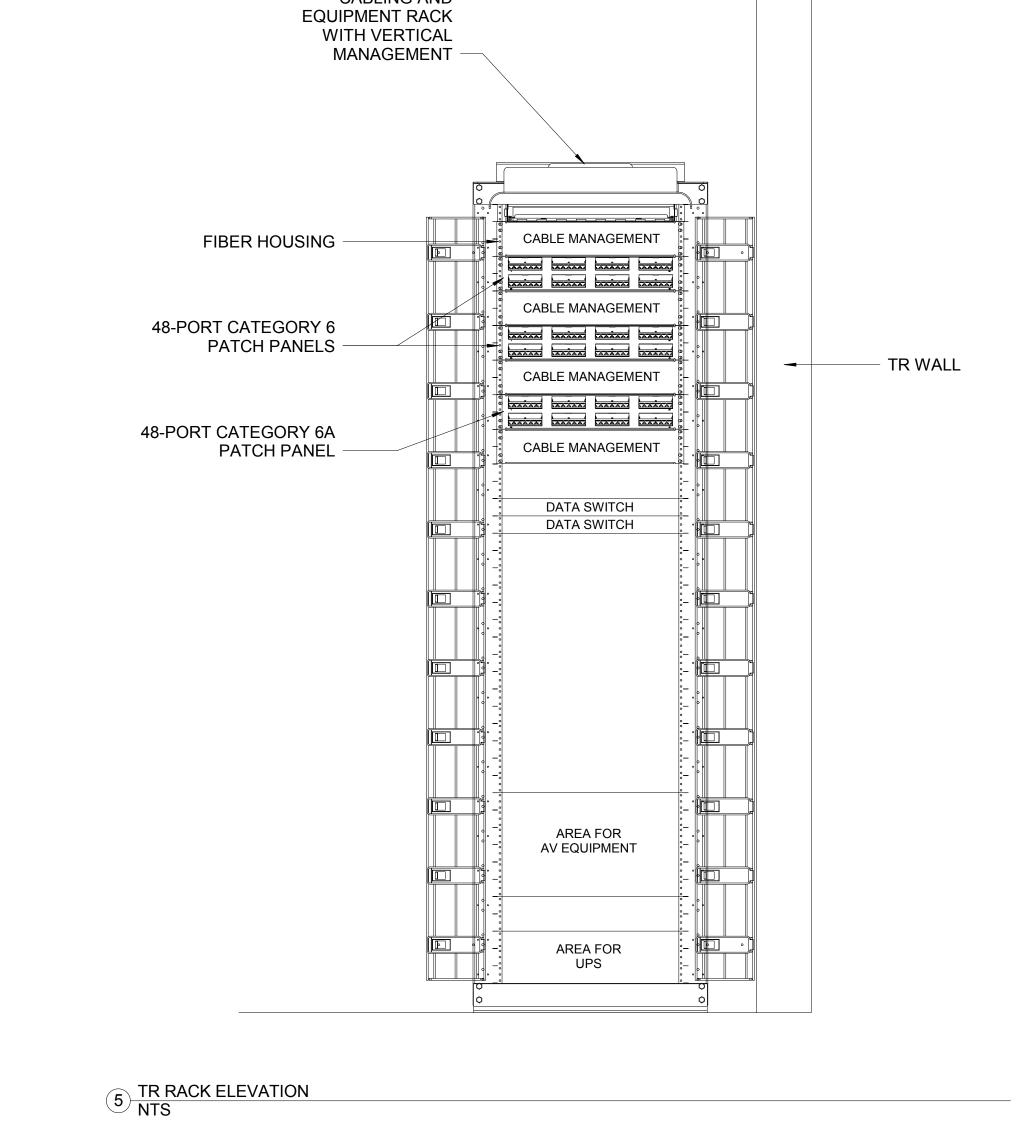

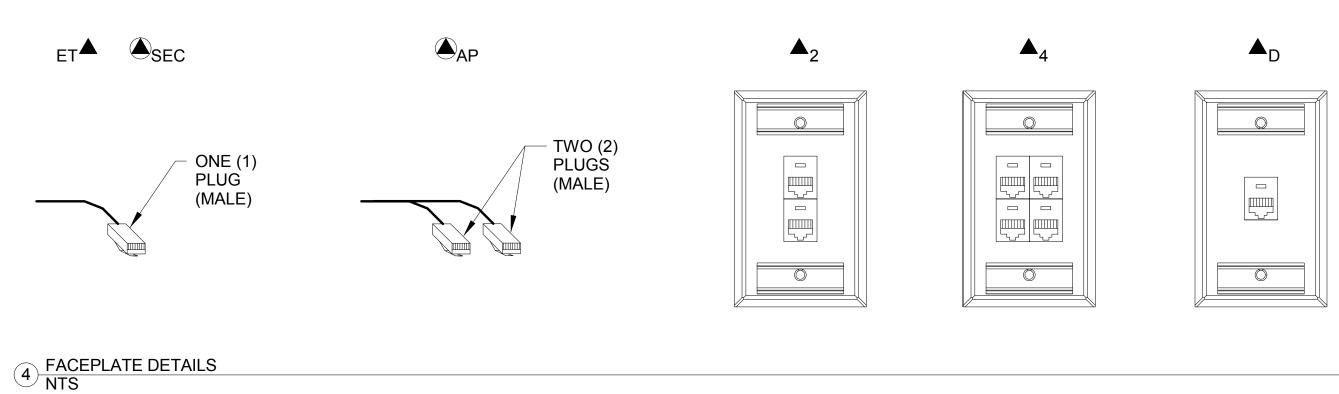

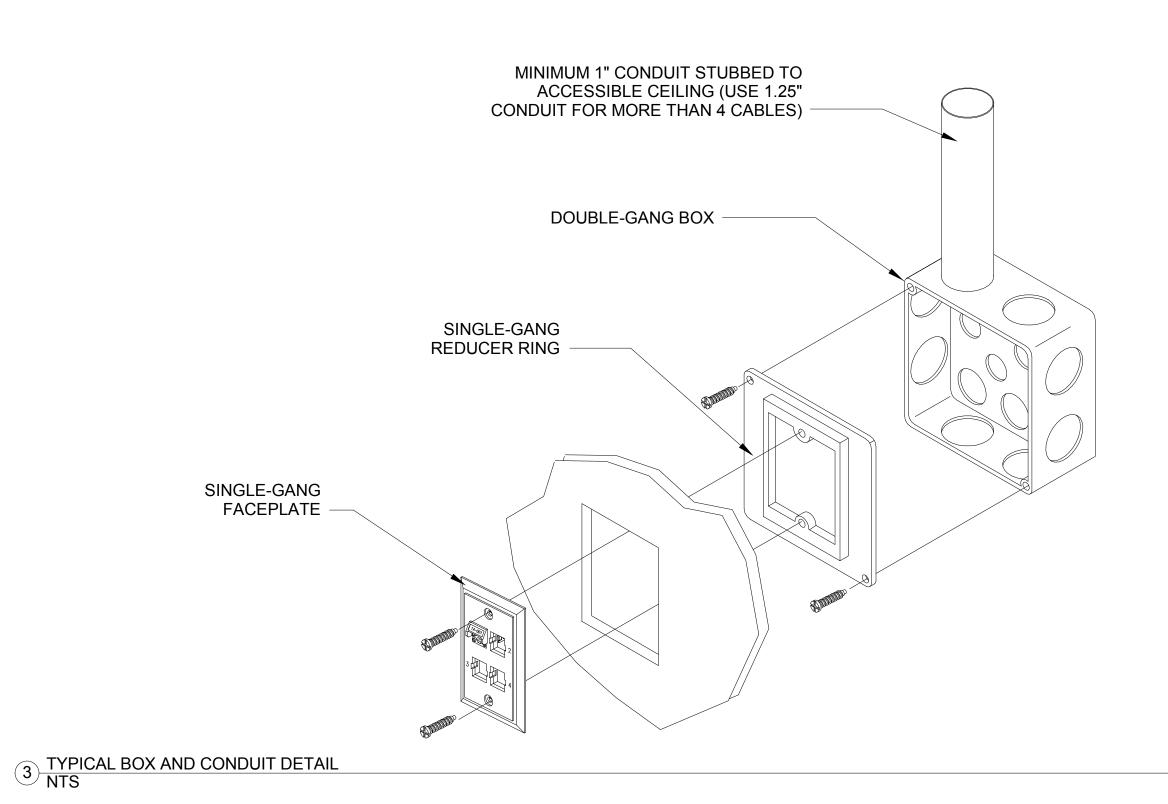

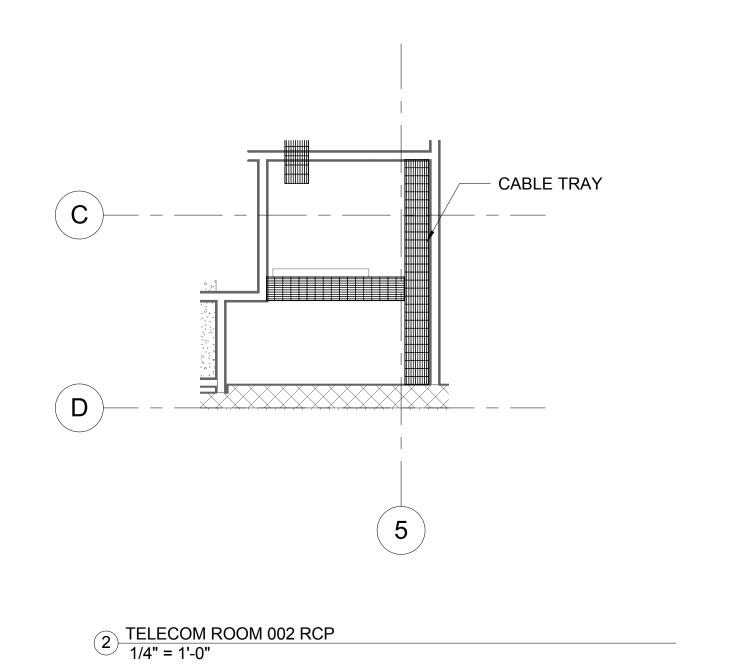

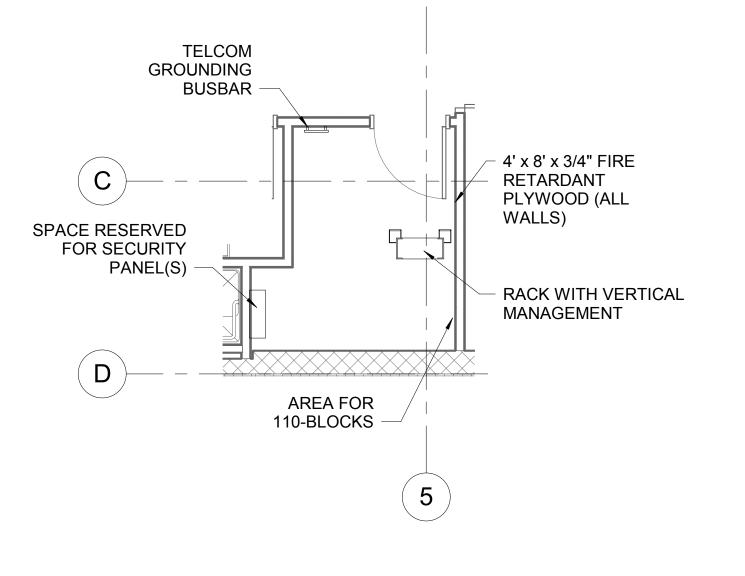



1 TELECOM ROOM 002 FLOOR PLAN 1/4" = 1'-0"

T4.02

© COPYRIGHT AYERS SAINT GROSS, 2016

CABLING AND

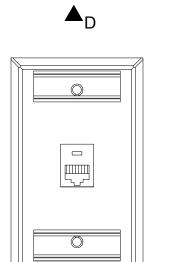

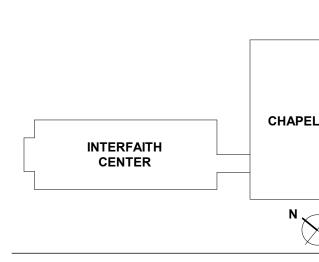

PROJECT INFORMATION

GOUCHER
—college—

GOLDSMITH INTERFAITH **CENTER**

> GOUCHER COLLEGE 1021 DULANEY VALLEY RD BALTIMORE MD 21204

> > PROJECT TEAM

ARCHITECT

AYERS SAINT GROSS

1040 HULL STREET, SUITE 100 BALTIMORE, MD 21230 410.347.8500

www.asg-architects.com

M/E/P & FIRE PROTECTION ENGINEER MUELLER ASSOCIATES 1306 CONCOURSE DRIVE, SUITE 100

LINTHICUM, MD 21090

STRUCTURAL ENGINEER

MORABITO CONSULTANTS 952 RIDGEBROOK ROAD, SUITE 1700 SPARKS, MD 21152 410.467.2377 www.morabitoconsultants.com

CIVIL ENGINEER

300 EAST JOPPA ROAD, SUITE 200 BALTIMORE, MD 21286 410.512.4500

www.wbcm.com

LANDSCAPE ARCHITECT

AYERS SAINT GROSS 1040 HULL STREET, SUITE 100

BALTIMORE, MD 21230

410.347.8500 www.asg-architects.com

IT / AV / SECURITY SPEXSYS 7257 PARKWAY DRIVE, SUITE 260

HANOVER, MD 21076

410.712.0390

REVISIONS

KEY PLAN

DESCRIPTION

410.646.4500 www.muellerassoc.com

11

AYERS SAINT GROSS

ARCHITECTS + PLANNERS

NOT FOR CONSTRUCTION

ISSUE DATE: SCALE: JOB NO.: DRAWN BY: PROJECT DESIGN PHASE **50% CONSTRUCTION**

DOCUMENTS DRAWING NAME

TELECOM CABLING DETAILS DRAWING NUMBER

TECHNOLOGY SYSTEMS -